

APD Project No. 21-0239

February 18, 2022

Town of West Seneca Planning Board c/o Jeffrey Schieber Code Enforcement Officer 1250 Union Road, Room 210 West Seneca, NY 14224

RE: Burger King (1997, 2003, 2007 Ridge Road) – Planning Board submittal

Dear Members of the Planning Board,

On behalf of our Client, JSC Management Group, LLC, we are enclosing revised plans and information as well as responses to the Town Engineer comments for the above-referenced property, and would ask that we be placed on the next Planning Board meeting for final Site Plan and Subdivision approval. We are submitting hard copies of the following items for your review and consideration:

- Letter of Intent
- Site Plans including property survey (5 copies)
- Engineer's Report (5 copies)

Please find below the Town Engineer comments (italics) and our corresponding responses (bold).

- A cross access agreement must be provided for access to and from the Wendy's property. A copy of the cross access agreement is included with this submittal.
- 2. Traffic impacts will need to be assessed.
  - A Traffic Impact Assessment was submitted electronically on 1/26/22 to the Town and County for review. Per discussions with the County on 2/18/22, they had not finalized their review or corresponding letter.
- 3. Review and approval for the proposed access on Ridge Road will be required from the Erie County Department of Public Works (ECDPW).
  - Awknowledged. Per discussions with the County on 2/18/22, they had not finalized their review or corresponding letter.
- 4. The ECDPW will also need to review and approve any tie-ins to their drainage system. They may require zero net increase in runoff in order to connect.
  - Acknowledged. Per discussions with the County on 2/18/22, they had not finalized their review or corresponding letter.
- 5. The proposed drainage design could not be properly assessed as several pipe inverts, lengths, sizes and slope were not provided. Pipe sizing calculations must also be provided.

Pipe inverts, sizes, and slopes are provided on the revised grading and drainage plan. Pipe sizing is included in the Engineer's Report.

6. An engineering report including projected water usage and sewer flows must be provided for review.

An Engineer's Report is provided in the submittal.

7. A sewer mitigation fee will be required. The fee will be calculated based upon the projected sewer flows. We have previously submitted for planning board approval and are in the process of coordinating with the local utilities.

Acknowledged.

As of the Town Board meeting on January 20, 2022, the properties have been rezoned to C-2 (S) Commercial. We are also scheduled to appear in front of the ZBA on February 23, 2022 for the required parking setback variance from Ridge Road, as this item was tabled at the January meeting. Since that time, the County has provided correspondence indicating that they have no objection to the requested setback.

We are requesting to be placed on the March 10, 2022 Planning Board agenda for Site Plan and Subdivision Approval. Should you have any comments, questions, or are in need of additional information, please feel free to contact me at (585) 742-2222.

Sincerely,

7odd Markevicz

Todd Markevicz Owner / Member





#### MARK C. POLONCARZ

COUNTY EXECUTIVE

WILLIAM E. GEARY, JR. COMMISSIONER

DEPARTMENT OF PUBLIC WORKS RATH BUILDING 14<sup>TH</sup> FLOOR

TELEPHONE:716.858.8300 FAX: 716.858.8228

February 4, 2022

Amy M. Kobler, Town Clerk Town of West Seneca 1250 Union Road West Seneca, NY 14224

Re:

Zoning Variance

1997, 2002 and 2007 Ridge Road (CR-137)

Proposed Burger King

(T) of West Seneca, County of Erie

Dear Ms. Kobler:

This Department has received a preliminary site plan for a proposed Burger King and a zoning variance to allow a 3' off street variance (Town requires 10') for property located at 1997, 2002 and 2007 Ridge Road (CR-137) in the Town of West Seneca. Erie County Department of Public Works has no issue with the proposed setback variance.

Further review by this department will commence upon receipt design plans and a Stormwater Management Report designed in accordance with the New York State Stormwater Design Manual and local Town requirements.

Sincerely,

ERIE COUNTY DEPARTMENT OF PUBLIC WORKS

Garrett M. Hacker, P.E.

Senior Civil Engineer

cc: Kar

Karen Hoak, Deputy Commissioner – Highways Darlene Svilokos, P.E., Director of Engineering Brian Rose, P.E., Supervisor of Engineering Gina Wilkolaski, P.E., Traffic Safety Engineer

Michael Pasnik, Senior Highway Maintenance Engineer

File: CR-137

#### ERIE COUNTY CLERK'S OFFICE



County Clerk's Recording Page

Return to:

**BOX 30** 

Party 1:

FX NET LEASE HOLDINGS LLC

Party 2:

**Recording Fees:** 

RECORDING	\$65.00
COE CO \$1 RET	\$1.00
COE STATE \$14.25 GEN	\$14.25
COE STATE \$4.75 RM	\$4.75
TP584	\$10.00

Book Type: D Book: 11293 Page: 9881

Page Count:

Doc Type:

EASEMENT/RTWY

Rec Date:

03/29/2016

Rec Time:

10:53:09 AM

Control #:

2016061298

UserID:

Diane

Trans #:

16049671

**Document Sequence Number** 

TT2015017385

Consideration Amount:	1.00
BASIC MT	\$0.00
SONYMA MT	\$0.00
ADDL MT/NFTA	\$0.00
SP MT/M-RAIL	\$0.00
NY STATE TT	\$0.00
<b>ROAD FUND TT</b>	\$0.00

Total: \$95.00

STATE OF NEW YORK ERIE COUNTY CLERK'S OFFICE

WARNING – THIS SHEET CONSTITUTES THE CLERK'S ENDORSEMENT REQUIRED BY SECTION 319&316-a (5) OF THE REAL PROPERTY LAW OF THE STATE OF NEW YORK. DO NOT DETACH. THIS IS NOT A BILL.

> Christopher L. Jacobs County Clerk

#### DECLARATION OF EASEMENT Store #817 – 2021 Ridge Road, West Seneca, NY (Wendy's #3872)

	THIŞ	DECL	ARA	TION	OF EASEME	NT (the	"Declaration	") is ma	ade ai	nd ente	ered into
this _	11	da	ay of		March		, 20	16, by	FX	NET	LEASE
HOLD	INGS	LLC	and	GLŔ	HOLDINGS,	LLC	(collectively	"Decla	rant"	) (ind	ividually
"Owne	er").										•

#### RECITALS

- A. FX Net Lease Holdings LLC is the owner of that certain real property situate in the Town of West Seneca, County of Erie, State of New York, known as 2021 Ridge Road, having a tax parcel number of 143.06-1-14.1, GLR Holdings, LLC is the owner of that certain real property situate in the Town of West Seneca, County of Erie, State of New York, known as 705 Orchard Park Road having a tax parcel number of 143.06-1-16 and 2007 Ridge Road having a tax parcel number of 143.06-1-13, all as more particularly described on Exhibit "A" attached hereto and incorporated herein by this reference ("Premises").
- B. Declarant desires to impose certain easements upon the Lots, the present and future owners and occupants thereof, on the terms and conditions hereinafter set forth.

NOW, THEREFORE, in consideration of the above premises and of the covenants herein contained, the Declarant does hereby declare that the Lots and all present and future owners and occupants of the Lots shall be and hereby are subject to the terms, covenants, easements, restrictions and conditions hereinafter set forth in this Declaration, so that said Lots shall be maintained, kept, sold and used in full compliance with and subject to this Declaration and, in connection therewith, Declarant covenants and agrees as follows:

#### **AGREEMENTS**

- 1. Definitions. For purposes hereof:
  - (a) The term "Owner" or "Owners" shall mean the Declarant and any and all successors or assigns of such persons as the owner or owners of fee simple title to all or any portion of the real property covered hereby, whether by sale, assignment, inheritance, operation of law, trustee's sale, foreclosure, or otherwise, but not including the holder of any lien or encumbrance on such real property.
  - (b) The term "Lot" or "Lots" shall mean each separately identified Lot of real property now, or in the future, constituting a part of Premises subjected to this Declaration as described on Exhibit "A".
  - (c) The term "Permittees" shall mean the tenant(s), subtenant(s), or occupant(s) of a Lot, and the respective employees, agents, contractors, customers, invitees and licensees of (i) the Owner of such Lot, and/or (ii) such tenant(s) or occupant(s).

WSN 61298 785-8-

#### 2. Easements.

- 2.1 <u>Grant of Reciprocal Easements</u>. Subject to any express conditions, limitations or reservations contained herein, Declarant hereby declares that the Premises and all future Lots, and all Owners and Permittees of the Lots, shall be benefited and burdened by the following reciprocal easements which are hereby imposed upon the Premises and Lots and all present and future Owner's and Permittees of the Lots:
  - (a) An easement for reasonable access, ingress and egress over all paved driveways, roadways and walkways as presently or hereafter constructed and for the passage of motor vehicles and pedestrians between all portions of the Premises intended for such purposes, and to and from all abutting streets or rights of way furnishing access to such Premises and parking only over parking spaces as presently or hereafter constructed;
  - (b) An easement under and across those parts of the Premises for the installation, maintenance, repair and replacement of water mains, storm drains, sewers, water sprinkler system lines, telephone or electrical conduits or systems, cable, gas mains and other utility facilities necessary for the orderly development and operation of each building from time to time located within the Premises; provided that (i) the rights granted pursuant to such easements shall at all times be exercised in such a manner as not to unreasonably interfere materially with the normal operation of a Lot and the businesses conducted therein and (ii) the exact location of any utilities shall be subject to the reasonable approval of the Declarant.
- 2.2 <u>Indemnification</u>. Each owner having rights with respect to an easement granted hereunder shall indemnify and hold the Owner of the burdened Premises harmless from and against all claims, liabilities and expenses (including reasonable attorneys' fees) relating to accidents, injuries, loss, or damage of or to any person or property arising from the negligent, intentional or willful acts or omissions of such Owner, its contractors, employees, agents, or others acting on behalf of such Owner.
- 2.4 <u>Reasonable Use of Easements</u>. The easements herein above granted shall be used and enjoyed by each Owner and its Permittees in such a manner so as not to unreasonably interfere with, obstruct or delay the conduct and operations of the business of any other Owner or its Permittees at any time conducted on its Lot, including, without limitation, public access to and from said business and utilities to and from said business.

#### 3. Maintenance.

3.1 <u>General</u>. Each Lot Owner shall maintain its own Lot at its sole cost and expense. Such maintenance is to include but is not limited to, snow removal, drainage/road repair and replacement, landscaping, and generally keep the location in clean and neat condition and shall take such measures as are necessary to control grass, weeds, blowing dust, dirt, litter or debris.

3.2 <u>Utilities</u>. Each Owner shall at all times during the term hereof construct, operate and maintain or cause to be constructed, operated and maintained, in good order, condition and repair, at its sole expense, any utility, or other installations, servicing its Lot or servicing any of the other Lots.

#### 4. Taxes and Assessments.

Each Owner shall pay all taxes, assessments, or charges of any type levied or made by any governmental body or agency with respect to its Lot.

5. <u>Irreparable Harm.</u> In the event of a violation or threat thereof of any of the provisions of this Declaration, each Owner agrees that such violation or threat thereof shall cause the nondefaulting Owner and/or its Permittees to suffer irreparable harm and such nondefaulting Owner and its Permittees shall have no adequate remedy at law. As a result, in the event of a violation or threat thereof of any of the provisions of this Declaration, the nondefaulting Owner, in addition to all remedies available at law or otherwise under this Declaration, shall be entitled to injunctive or other equitable relief to enjoin a violation or threat thereof of this Declaration only after all applicable notice and cure periods.

#### 6. Miscellaneous.

- 6.1 <u>Attorneys' Fees</u>. In the event a party institutes any legal action or proceeding for the enforcement of any right or obligation herein contained, the prevailing party after a final adjudication shall be entitled to recover its costs and reasonable attorneys' fees incurred in the preparation and prosecution of such action or proceeding.
- 6.2 <u>Amendment</u>. Declarant agrees that the provisions of this Declaration may be modified or amended, in whole or in part, or terminated, only by the written consent of all record Owners of the Premises or Lots.
- 6.3 <u>Consents</u>. Wherever in this Declaration the consent or approval of an Owner or Declarant is required, unless otherwise expressly provided herein, such consent or approval shall not be unreasonably withheld, conditioned or delayed. Any request for consent or approval shall: (a) be in writing; (b) specify the section hereof which requires that such notice be given or that such consent or approval be obtained; and (c) be accompanied by such background data as is reasonably necessary to make an informed decision thereon. The consent of an Owner under this Declaration, to be effective, must be given, denied or conditioned expressly and in writing.
- 6.4 <u>Covenants to Run with Land</u>. It is intended that each of the easements, covenants, conditions, restrictions, rights and obligations set forth herein shall run with the land and create equitable servitudes in favor of the real property benefited thereby, shall bind every person having any fee, leasehold or other interest therein and shall inure to the benefit of the respective parties and their successors, assigns, heirs, and personal representatives.

- 6.5 Grantee's Acceptance. The grantee of any Lot or any portion thereof, by acceptance of a deed conveying title thereto or the execution of a contract for the Purchase thereof, whether from an original party or from a subsequent owner of such Lot, shall accept such deed or contract upon and subject to each and all of the easements, covenants, conditions, restrictions and obligations contained herein. By such acceptance, any such grantee shall for himself and his successors, assigns, heirs, and personal representatives, covenant, consent, and agree to and with the other party, to keep, observe, comply with, and perform the obligations and agreements set forth herein with respect to the property so acquired by such grantee.
- 6.6 <u>Notices</u>. Notices or other communication hereunder shall be in writing and shall be sent certified or registered mail, return receipt requested, or by other national overnight courier company, or personal delivery. Notice shall be deemed given upon receipt or refusal to accept delivery. Each party may change from time to time their respective address for notice hereunder by like notice to the other party.
- 6.7 <u>Governing Law</u>. The laws of the State in which the Lots are located shall govern the interpretation, validity, performance, and enforcement of this Declaration. Any lawsuit must be venued in Erie County in the State of New York.
- 6.8 <u>Bankruptcy</u>. In the event of any bankruptcy affecting any Owner or occupant of any Lot, the parties agree that this Declaration shall, to the maximum extent permitted by law, be considered an agreement that runs with the land and that is not rejectable, in whole or in part, by the bankrupt person or entity.
- 6.9 <u>Mortgage Subordination</u>. Any mortgage or deed of trust affecting any portion of any Lot shall at all times be subject and subordinate to the terms of this Declaration, and any party foreclosing any such mortgage or deed of trust, or acquiring title by deed in lieu of foreclosure or trustee sale, shall acquire title subject to all the terms and conditions of this Declaration.

[Signature on following page]

IN WITNESS WHEREOF, Declarant has executed this Declaration as of the date first written above.

EX NET LEASE HOLDINGS LLC By: FV Real Estate Management, LLC, its Manager
By: Amito M. Ty
Johnathan M. Fox, Manager
GLR HOLDINGS, LLC By: FV Real Estate Holdings, LP, its sole member
By: FV Real Estate Management, LLC, its general partner
By: Jehntle MTV
Name: Johnathan M. Fox, Manager
in the year 2016 before me, the undersigned, ox, personally known to me or proved to me on the basis of ual whose name is subscribed to the within instrument and the same in his capacity, and that by his signature on the on upon behalf of which the individual acted, executed the
Notary Public RAHK, CARPENTER
Notary Public DESORAH K. CARPENTER Notary Public, State of New York No. 4966451 Qualified in Monroe County Ss: Commission Expires May 7, 2018
in the year 2016 before me, the undersigned, ox personally known to me or proved to me on the basis of ual whose name is subscribed to the within instrument and the same in his capacity, and that by his signature on the on upon behalf of which the individual acted, executed the
hehorari K Carpe wter  Notary Public
DEBORAH K. CARPENTER

#### LEGAL DESCRIPTION 2021 RIDGE ROAD TAX PARCEL: 143.06-1-14.1

ALL THAT TRACT OR PARCEL OF LAND situate in the Town of West Seneca, County of Erie and State of New York, being part of Lot No. 296, Township 10, Range 7 of the Buffalo Creek Indian Reservation and being more particularly described as follows:

BEGINNING at a point on the westerly line of Orchard Park Road (66.0 feet wide), said point being 170.30 feet northerly as measured from the south line of Lot No. 296 as measured along the westerly line of Orchard Park Road; thence westerly at an exterior angle of 89° 25', a distance of 270.0 feet to a point; thence northerly at an interior angle of 89° 25', a distance of 260 feet to a point in the southerly line of Ridge Road (80.00 feet wide); thence easterly along said southerly line at an exterior angle of 89° 25', a distance of 120.0 feet to a point, said point also being a distance of 150.00 feet westerly from the intersection of the southerly line of Ridge Road and the westerly line of Orchard Park Road; thence southerly at an exterior angle of 90° 35', a distance of 180.00 feet to a point; thence easterly at an exterior angle of 89° 25', a distance of 150.00 feet to a point on the westerly line of Orchard Park Road; thence southerly and along said westerly line, a distance of 80.00 feet to the point and place of beginning.

EXCEPTING THEREFROM lands appropriated by Notice of Appropriation recorded in Liber 9935 of Deeds at page 362, as supplemented by Notice of Appropriation recorded in Liber 10084 of Deeds at page 176, being Map 54, Parcel 56.

#### LEGAL DESCRIPTION 705 ORCHARD PARK ROAD TAX PARCEL: 143.06-1-16

ALL THAT TRACT OR PARCEL OF LAND, situate in the Town of West Seneca, County of Erie and State of New York, being part of Lot No. 296, Township 10, Range 7 of the Buffalo Creek Reservation, described as follows:

COMMENCING at a point in the southwesterly line of Orchard Park Road distant 135 feet southeasterly from its intersection with the southeasterly line of Ridge Road as measured along the southwesterly line of Orchard Park Road; thence southwesterly parallel to the southeasterly line of Ridge Road 150 feet; thence southeasterly parallel with the southwesterly line of Orchard Park Road 45 feet; thence northeasterly parallel to the southeasterly line of Ridge Road 150 feet to the southwesterly line of Orchard Park Road; thence northwesterly along said line of Orchard Park Road 45 feet to the place of beginning.

EXCEPTING THEREFROM those lands appropriated by the State of New York recorded in Erie County Clerk's Office in Liber 9757 of Deeds at page 419.

#### LEGAL DESCRIPTION 2007 RIDGE ROAD TAX PARCEL: 143.06-1-13

ALL THAT TRACT OR PARCEL OF LAND, situate in the Town of West Seneca, County of Erie and State of New York, being part of Lot Number 296 Township 10 Range 7 of the Buffalo Creek Reservation, bounded and described as follows:

BEGINNING at a point in the southerly line of Ridge Road distant 270 feet westerly of the intersection of said line of Ridge Road with the westerly line of Orchard Park Road measured along said line of Ridge Road; thence westerly along said line of Ridge Road 40 feet; thence southerly and parallel with the Orchard Park Road 220.10 feet; thence easterly parallel with the southerly line of said lot No. 296, 40.71 feet; thence northerly parallel with said line of Orchard Park Road 228.10 feet to the southerly line of Ridge Road at the place of beginning.

### **ENGINEER'S REPORT**

for the proposed

#### WATER USAGE AND SEWER FLOWS

# BURGER KING – WEST SENECA, NY

1997-2007 Ridge Road West Seneca, NY 14224 Erie County, NY

Prepared for:

JSC Management Group, LLC PO Box 217 Lyndonville, NY 14098

Prepared by:



615 Fishers Run, Victor, New York 14564

Phone: 585.742.2222 | Fax: 585.924.4914 | Website: www.apd.com | Email: info@apd.com

Original Date: February 18, 2022

Project No.: 21-0239

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APD Engineering & Architecture, PLLC

#### **Document Alteration**

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#### **SITE INFORMATION**

The proposed Burger King restaurant to be constructed is located at 1997-2007 Ridge Road in the West Seneca, NY. The existing properties consist of a shared access drive to two houses with a two-car detached garage and shed on-site on 1997 & 2003 Ridge Road with 2007 Ridge Road as a vacant grass lot. The Burger King restaurant is proposed for the northern portions of the existing site located at 1997-2007 Ridge Road in West Seneca, NY. The overall site is relatively flat, the finish floor elevation of the proposed building is 633.00 feet. Research into FEMA floodplain information would indicate that there is no defined flood zone within the near vicinity of the store.

#### DOMESTIC WATER AND FIRE SERVICE

Domestic water service will be supplied to the site by the Erie County Water Authority and Erie County Division of Sewer Management. The existing watermain that serves 1997-2007 Ridge Road is a 12" waterline located in Ridge Road. There are two (2) existing services for the both houses on site with 3/4" water services, which will be removed as part of this project. The proposed domestic water service will enter the building near the Southwest corner of the proposed building. Refer to the Site Plan set for additional information.

Water use within the facility will consist of potable water. Fixtures at the facility typically include water closets, lavatories, urinals, sinks, drinking fountains, mop basin, and hose bibs. The estimated peak flow demand for potable water is 54 GPM.

The reduced pressure zone (RPZ) backflow prevention device will be a 2" Watts Series LF909 RPZ. A water meter will be installed on the line before the RPZ and a reduced pressure valve will be installed after the RPZ. The RPZ will drain through a funnel and drain connecting to the wall of the mechanical room and to the building exterior. The RPZ and Meter will be located in the utility room at the Southwest corner of the proposed building.

#### **HYDRANT TEST RESULTS AND CALCULATIONS**

A hydrant flow test was conducted by the Erie County Water Authority on November 5, 2019. This was performed on two fire hydrants located along Ridge Road to the north and west of the site.

Hydrant A, the gauge or residual hydrant, is located west of the site at 1879 Ridge Road in front of the Denny's restaurant. It is connected to a 12" waterline in Ridge Road and is located approximately 1,250-feet west of the proposed Burger King. Hydrant B, the flow hydrant, is located at 1976 Ridge Road adjacent to the Valu Auto Place. This hydrant is connected to the same 12" waterline as Hydrant A within Ridge Road and is located approximately 200-feet northwest of the site. Table I below summarizes the hydrant flow data obtained from the test. A copy of the Water Flow Test Information sheet is provided in Appendix B.

Table I

	At Test Hydrant	At Flow
	(Hydrant #A)	Hydrant
	, ,	(Hydrant #B)
Residual	82 psi	
Pressure		
Static Pressure	88 psi	88 psi
Flow		2,326 gpm

Based on the hydrant flow test data provided in Appendix B, the existing water distribution system has sufficient capacity and water pressure to provide the proposed facility with adequate flows and pressures.

A separate backflow preventer application and supporting information will be submitted to Erie County in the near future, once the building plans are completed. As part of this submittal, we will include hydraulic calculations showing the anticipated pressure and required domestic flow at the building.


#### **SANITARY SEWER**

The sanitary system has been designed in accordance with the Ten State Standards for Wastewater Facilities. The existing sewer is an 8" PVC pipe gravity main along the south side of Ridge Road. There appear to be (2) existing 4" laterals for the houses based on recent Town sewer monitoring.

The Contractor shall be responsible to locate the existing sewer and abandon the 2 existing connections. The proposed sanitary lateral will connect to the existing 8" PVC sanitary sewer as shown on the Utility Plan. The proposed building finished floor elevation is 633.00 feet. A cleanout is proposed outside the building, in the grass, and a second at the point of connect to the existing sewer. There is also a proposed 1,200-gallon grease interceptor on the east side of the building which connects to the sanitary lateral.

Based on Burger King's experience of operating stores across the United States, the anticipated average daily wastewater flow rate for the store is approximately 1,600 gpd.

# Appendix A Hydrant Flow Test Data

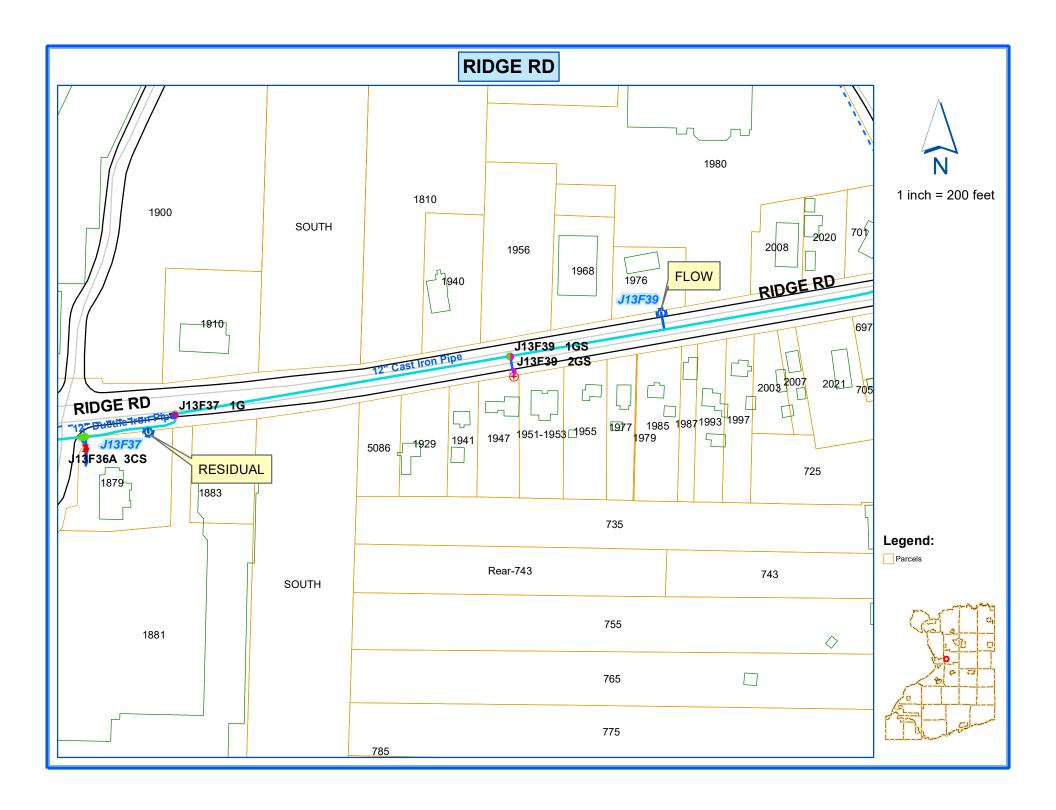

Hydrant Flow Test Inquiry -- Hydrant: J13F37 Test Date/Time: 11/05/2019 10:00 RIDGE RD Side: S Location: 1ST ZEO LANGNER RD ARM CHI 095-B Address: W SENECA FACTORY OUTLET MALL W SENECA
Size of Main/Branch: 12"/6" Fire District: 68022 FIRE DIST 3 Water District: 044 ECWA AREA-WEST SENECA

Comments: HYDRANT FLOW TEST REQUESTED BY THOMAS YAGER, ISO Performed By: DWP/MES PHONE: 716-207-4967; EMAIL: TYAGER@I SO. COM

CW #40303

Static(psi): 88 Residual(psi): 82 Required Residual Pressure(psi): 20 6,960 Total Flow(gpm): 2,326 Flow at Reqd Resid Pressure: 8,629 Dischrge Coef: .90 Elvtn Usgs(ft): Gallons Used..:

Flow Hydrants: Nzle Size Pitot Flow Comments

C Flow Hyd Flow Hydrant Address Main/Brnch

J13 F39 1976 RIDGE RD 12"/6"

2ND HYD W/O ORCHARD PK RD 1: 2.50 48.0 1,163 2: 2.50 48.0 1,163

Tot FI ow: 2, 326

Bottom

I=Flow Hydrant Inquiry ENTER=Continue F3=Exit F6=Maintain Test F7=Test Hydrant Inquiry F15=Print Test Information

# Appendix B Storm Sewer Pipe Sizing Spreadsheet



Project: Burger King, West Seneca, NY

Project No.: 21-0239

County, State: Erie County, NY

By: SAS Date: 02/18/22

#### PROPOSED DRAINAGE AREA SUMMARY - (STORM SEWER D)

		MEASURED				COMPOSITE
DESIGNATION	LAND USE	AREA	AREA	С	Axc	С
		(ft²)	(acres)			
D-5	LANDSCAPED	2,762	0.063	0.25	0.016	0.77
	IMPERVIOUS	10,774	0.247	0.90	0.223	
	TOTAL	13,536	0.311		0.238	
D-4	LANDSCAPED	0	0.000	0.25	0.000	0.00
	IMPERVIOUS	0	0.000	0.90	0.000	
	TOTAL	0	0.000		0.000	
D-3	LANDSCAPED	0	0.000	0.25	0.000	0.90
	IMPERVIOUS	1,479	0.034	0.90	0.031	
	TOTAL	1,479	0.034		0.031	
D-2	LANDSCAPED	491	0.011	0.25	0.003	0.87
	IMPERVIOUS	9,975	0.229	0.90	0.206	
	TOTAL	10,467	0.240		0.209	
D-1	LANDSCAPED	0	0.000	0.25	0.000	0.00
	IMPERVIOUS	0	0.000	0.90	0.000	
	TOTAL	0	0.000		0.000	
D	LANDSCAPED	0	0.000	0.25	0.000	0.00
	IMPERVIOUS	0	0.000	0.90	0.000	
	TOTAL	0	0.000		0.000	
TOTAL	LANDSCAPED	3,253	0.075	0.25	0.019	0.82
	IMPERVIOUS	22,228	<u>0.510</u>	0.90	<u>0.459</u>	
	TOTAL	25,481	0.585		0.478	



Project: Burger King, West Seneca, NY

Project No.: 21-0239 County, State: Erie County, NY

By: SAS
Date: 02/18/22

NOTES: \* Based on 10-year design storm

\* Matching crown of pipes

\* Min. cover = 2.00 ft

\* All CPP is smooth lined

\* Min. Tc = 5 min

### **Proposed Storm Sewer Computations**

	Structure Designatio			_	ology a			ydrology ream Struc			Peak Dis	_		Pipe Characteristics						
	From	То	T <sub>c</sub>	С	A (ac)	(C x A)		T <sub>c</sub>	(C x A)	Total (C x A)	Controlling Tc	i	Q (cfs)	Pipe Dia. M	at'l n	Length (ft)	Slope (%)	Capacity (cfs)	Velocity (fps)	Time (min)
	D-5	D-4																		
Water T.G. INV.	629.81 632.35 629.14	628.65	5.00	0.77	0.31	0.24		No upsteam structures		0.24	5.00	5.10	1.2	12 CF	PP 0.013	3 25	2.00	5.0	6.4	0.06
	D-4	D-3	0.00	• • • • • • • • • • • • • • • • • • • •	0.01		D-5	5.06	0.24	0.21	0.00	00			. 0.010		2.00	0.0	0	0.00
Water T.G. INV.	629.31 632.56 628.65	627.98	5.00	0.00	0.00		TOTAL	5.06	0.24	0.24	5.06	5.08	1.2	12 CF	PP 0.013	3 33	2.00	5.0	6.4	0.09
	D-3	D-1					D-4	5.15	0.24											
Water T.G. INV.	628.69 632.08 627.98	626.65	5.00	0.90	0.03	0.03	TOTAL	5.15	0.24	0.27	5.15	5.04	1.4	12 CF	PP 0.013	8 67	2.00	5.0	6.4	0.17
	D-2	D-1					D-3	5.32	0.27											
Water T.G. INV.	627.50 631.50 627.50	626.65	5.00	0.87	0.24	0.21	TOTAL	5.32	0.27	0.48	5.32	4.97	2.4	12 CF	PP 0.013	3 17	5.00	8.0	10.1	0.03
	D-1	D																		
Water T.G. INV.	626.65 632.17 626.65	626.50	5.00	0.00	0.00	0.00		No upsteam structures		0.00	5.00	5.10	0.0	12 CF	PP 0.013	3 3	5.00	8.0	10.1	0.00

625.20 Tailwater Condition (10-year)

Appendix C

Record Plans



### **Erie County On-Line Mapping Application**





#### Legend

Parcels

Streets and Highways

Interstate

Primary State Road

Secondary State Road

\_\_\_ County Road

Local Road

0.02 0.0 Miles


WGS\_1984\_Web\_Mercator\_Auxiliary\_Sphere THIS MAP IS NOT TO BE USED FOR NAVIGATION

ERIE COUNTY
DEPARTMENT OF ENVIRONMENT & PLANNING
OFFICE OF GIS


This map is a user generated static output from an Internet mapping site and is for reference only. Data layers that appear on this map may or may not be accurate, current, or otherwise reliable.

1: 1,128




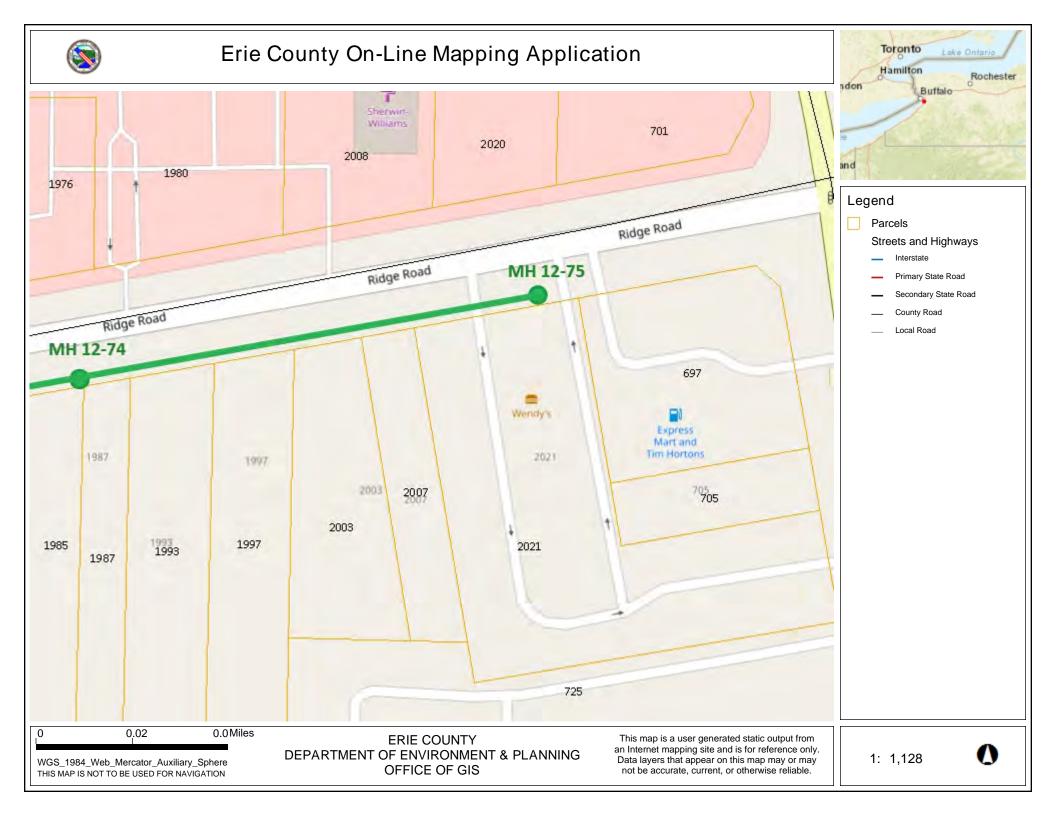

Sheet 5	Surveyo	r WS		Certificate	WS	System O	wner			
Reviwed By		Revi	iewer #			<b>Work Order</b>				
Customer WES	T SENECA				PO		Media Label	1		
<b>Date</b> 20211	201 09:35	Weather			PreClean	Light Cleaning	Date Cle	eaned		
Flow Control				Purpose	•		Direction	Downstrea	m	
Inspection Stat	us Complete	Inspection	า	Con	sequence	of Failure	Pressure			
Inspection Tech	nnology Use	d	ССТУ	Laser	Sonar	Sidewall	Zoom 🗌 C	Other		
Street ridge rd			City	WEST SENEC	CA	Drai	inage Area			
Location						Pip	<b>e Use</b> Sanitary	/ Sewage Pi	ре	
Details						Hei	ght 8 W	/idth	in	
Shape Circular			Material	Polypropylen	е	Lining				
Coating			Joint	Length	ft	<b>Total Length</b>	340.0	ft		
Len. Surveyed	340.0	o <b>ft</b>	Yea	r Constructe	ed	Year Rehabilit	ated			
<b>Up</b> 75			Rim Iı	nvert	Grade	Invert	Rim Gra	ade		ft
Northing			Eastir	ng		Eleva	ation			
Down 74			Rim Iı	nvert	Grade	Invert	Rim Gra	ade		ft
Northing			Eastir	ng		Eleva	ation			
Coordinate Sys	tem					Vertical Dat	tum			
GPS Accuracy										
Additionl Info										

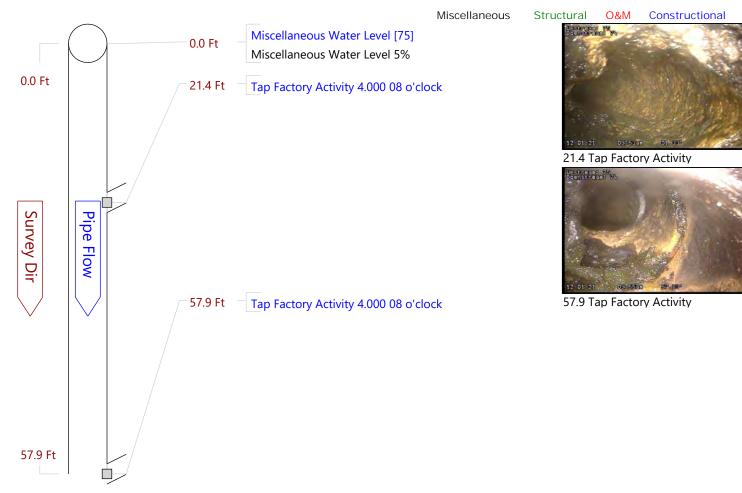

Test 2

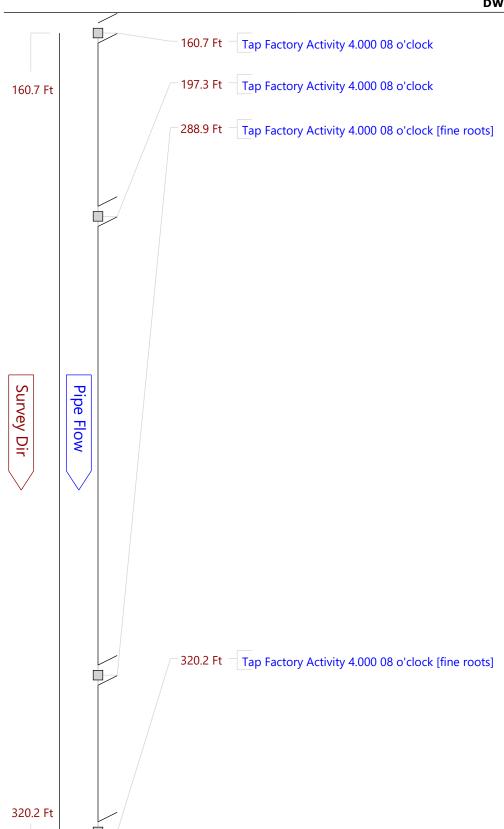



160.7 Tap Factory Activity



197.3 Tap Factory Activity



288.9 Tap Factory Activity



320.2 Tap Factory Activity

Test 2

**Project** Plate #12

340.0 Ft Manhole [74]



340.0 Manhole

Survey Dir

340.0 Ft


340.0 Ft

Pipe Flow

Test 2

Appendix D

Survey

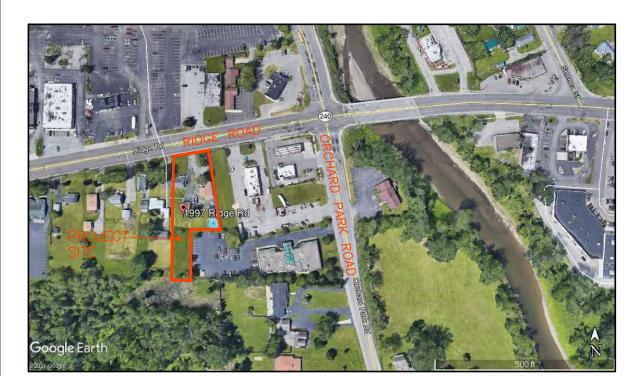

VICINITY MAP (NOT TO SCALE)

#### **RECORD DESCRIPTIONS:**

No. 1997 Ridge Road Parcel A Liber 11134, Page 9130

ALL That Tract or Parcel of Land, situate in the Town of West Seneca, County of Erie and State of New York, being part of Lot No. 296, Township 10, Range 7 of the Buffalo Creek Reservation and described as

BEGINNING at a point in the south line of said lot, 765.10 feet east of the west line of said lot; running thence easterly along the south line of said lot, 58.80 feet; thence northerly parallel with the west line of said lot, 349 feet to the south line of Ridge Road; thence westerly along the southerly line of Ridge Road 59.83 feet to a line drawn parallel with the west line of the lot from the place of beginning; thence southerly along said parallel line 340.79 feet to the south line of said lot at the place of beginning. Together with all right, title and interest of, in and to any streets and roads abutting the above—described premises.

Liber 11079, Page 2477

ALL That Tract Or Parcel Land, situate la the Town of West Seneca, County of Erie and State of New York, being part of Lot Number 296, Township 10, Range 7 of the Buffalo Creek Reservation bounded and

BEGINNING at a point in the southerly line of Ridge Road distant three hundred ten (310) feet westerly from the Intersection of said line of Ridge Road with the westerly line of Orchard Park Road, as measured along said line of Ridge Road, thence southerly parallel to the Orchard Park Road, two hundred twenty and ten hundredths (220.10) feet to lands conveyed by Herbert A. Davis by deed recorded in Liber 1304 of deeds at page 7, thence westerly and parallel to the southerly line of Lot No. 296 a distance of eight-seven and fifty six hundredths (87.56) feet to the westerly line of lands conveyed to John J. Deppler by deed recorded In Liber 800 of Deeds at page 495, thence northerly along said westerly line two hundred seven and eighteen hundredths (207.18) feet to the south line of Ridge Road, thence easterly along the south line of Ridge Road, forty—seven (47) feet to the place or beginning.

Note: the southerly course is missing in the supplied deed description No. 2007 Ridge Road

ALL THAT TRACT OR PARCEL OF LAND, situate in the Town of West Seneca, County of Erie and State of New York, being part of Lot Number 296 Township 10 Range 7 of the Buffalo Creek Reservation, bounded

Liber 11116, Page 1781

and described as follows: BEGINNING at a point in the southerly line of Ridge Road distant 270 feet westerly of the intersection of said line of Ridge Road with the westerly line of Orchard Park Road measured along said line of Ridge Road; thence westerly along said line of Ridge Road 40 feet; thence southerly and parallel with the Orchard Park Road 220.10 feet; thence easterly parallel with the southerly line of said lot No. 296, 40.71 feet; thence northerly parallel with said line of Orchard Park Road 228.10 feet to the southerly line of Ridge Road at the place of beginning.

PARCEL A: SBL 143.06-1-11 = 0.467± ACRES PARCEL B: SBL 143.06-1-12 = 0.327± ACRES PARCEL C: SBL  $143.06-1-13 = 0.206 \pm ACRES$ 

36029C0334H, EFFECTIVE DATE JUNE 7, 2019.

FLOOD ZONE CLASSIFICATION: PARCEL IS LOCATED IN ZONE-X "AREA OF MINIMAL FLOOD HAZARD" PER FEMA FLOOD INSURANCE RAIE MAP NO.

PARKING SPACES: THERE ARE NO DESIGNATED PARKING SPACES.

COMBINED AREA = 1.000± ACRES

ITEM 15: THERE WAS NO RECTIFIED ORTHOPHOTOGRAPHY, PHOTOGRAMMETRIC MAPPING, REMOTE SENSING, AIRBORNE/MOBILE LASER SCANNING USED FOR THIS SURVEY

ITEM 16: THERE WAS NO EVIDENCE OF RECENT EARTH MOVING WORK, BUILDING CONSTRUCTION OR BUILDING ADDITIONS OBSERVED IN THE PROCESS OF CONDUCTING THE

ITEM 17: NO INFORMATION REGARDING PROPOSED CHANGES TO STREET RIGHT OF WAY LINES WAS PROVIDED TO THE SURVEYOR

ITEM 18: NO PLOTTABLE EASEMENTS DISCLOSED IN DOCUMENTS WERE SUPPLIED TO THE SURVEYOR

**UTILITY NOTES:** 

1) DEPTH AND ACTUAL LOCATION OF UTILITY LINES OTHER THAN SANITARY AND STORM SEWER LINES HAVE NOT BEEN PHYSICALLY MEASURED IN THE FIELD.

2) NO STORM SEWER INFORMATION WAS PROVIDED THROUGH THE DIG SAFELY UTILITY DESIGN REQUEST.

COMMITMENT FOR TITLE INSURANCE NO. 1997, 2003 & 2007 RIDGE ROAD: TITLE POLICY AND TITLE SEARCH PROVIDED BY STEWART TITLE INSURANCE COMPANY, POLICY NO. WOG-3624 WITH EFFECTIVE DATE OF 9/7/2021.

SCHEDULE B NOTES (POLICY NO. WOG-3624): AFFECTS PARCELS A & B:

ITEM NO. 26: EASEMENT GRANTED TO NEW YORK STATE ELECTRIC AND GAS CORPORATION BY INSTRUMENT DATED JULY 12, 1944 AND RECORDED IN THE ERIE COUNTY CLERK'S OFFICE ON SEPTEMBER 5, 1944 IN LIBER 3593 OF DEEDS, PAGE 291. NOTED HEREON.

AFFECTS PARCEL C: DECLARATION OF EASEMENT BY AND BETWEEN FX NET LEASE HOLDINGS LLC AND GLR HOLDINGS LLC DATED MARCH 11, 2016 AND RECORDED IN THE ERIE COUNTY CLERK'S OFFICE ON MARCH 29, 2016 IN LIBER 11293 OF DEEDS, PAGE 9881. BLANKET EASEMENT AFFECTING SEVERAL PARCELS, NOT PLOTTABLE.

SURVEY REFERENCES

TAX MAP 143.06 LIBER 11079, PAGE 2477 (NO. 1997 RIDGE ROAD) LIBER 11134, PAGE 9130 (NO. 2003 RIDGE ROAD) LIBER 10876, PAGE 3073 (SBL 143.06-1-18.11) LIBER 11116, P.1781 (NO. 2021 RIDGE ROAD)

NOTE: NO PREVIOUS SURVEYS OR MAPS WERE PROVIDED OR OBTAINED WHILE PREPARING THIS SURVEY.

WARNING: ALTERING THIS DOCUMENT IS IN VIOLATION OF THE LAW EXCEPTING AS PROVIDED IN SECTION 7209, PART 2 OF THE NEW YORK STATE EDUCATION LAW.

THIS SURVEY WAS PREPARED WITHOUT THE BENEFIT OF AN ABSTRACT OF TITLE AND IS SUBJECT TO ANY STATEMENT OF FACTS THAT MAY BE REVEALED BY AN EXAMINATION OF SUCH.

NOTE: THE UNDERGROUND UTILITIES SHOWN HAVE BEEN LOCATED FROM FIELD SURVEY INFORMATION AND EXISTING DRAWINGS. THE SURVEYOR MAKES NO GUARANTEES THAT THE UNDERGROUND UTILITIES SHOWN COMPRISE ALL SUCH UTILITIES IN THE AREA, EITHER IN SERVICE OR ABANDONED. THE SURVEYOR FURTHER DOES NOT WARRANT THAT THE UNDERGROUND UTILITIES SHOWN ARE IN THE EXACT LOCATION INDICATED. THE SURVEYOR DOES CERTIFY THAT THEY ARE LOCATED AS ACCURATELY AS POSSIBLE FROM INFORMATION AVAILABLE. THE SURVEYOR HAS NOT PHYSICALLY LOCATED THE UNDERGROUND UTILITIES.









DRIVE

0.2'W、

633.16 633.12 /

EXIST. IP 633.104 EXIST. IP FENCE 53.1'S. F4

\ × 631.93

× 633.47

ASPHALT DRIVE

------GARDEN

<sup>UP</sup> 207.18'D&M

SEE EASEMENT GRANTED TO NEW YORK

L.3593, P,291, SHEDULE B, ITEM NO. 20

× 633.56

53.1'S, 51.2'S,

633.58 ×

0.57°E

0.10'E


GRASS -

× 633.65

× 632.69

STATE ELECTRIC AND GAS CORP. BY

632.80 ×

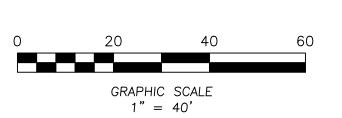

RPD

G

RO

-POINT OF

BEGINNING

L.11079, P.2477

∼DI #209 RIM=629.25


INV 18"CMP N=626.05

INV 6"CMP E=626.15

INV 6"CMP W=626.75

SAMH #400 RIM=628.72

INV 8"PVC SW=624.39

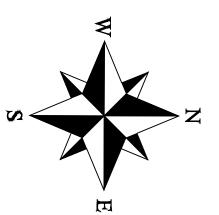

LEGEND

CLF	—//—	CHAIN LINK FENCE
SFL	—//—	STOCKADE FENCE
WFL	—//—	WIRE FENCE
мв		MAIL BOX
	þ	SIGN
	Œ	TREE DECIDUOUS
—G—		GAS LINE
GM	G	GAS METER
GV	×	GAS VALVE
DI		DRAINAGE INLET
—st—		STORM SEWER LINE
SCO	00	SEWER CLEANOUT
—SA—		SANITARY SEWER LINE
INV	(	INVERT ELEVATION
TC	TR	TRAFFIC CONTROL BOX
LIGHT	<del>-</del> \$ <del>-</del>	LIGHT STANDARD
ЕМ	E	ELECTRIC METER
UP	Ø	UTILITY POLE
—онw—		OVERHEAD WIRES
—UE—		UNDERGROUND ELECTRIC
—uT—		UNDERGROUND TELEPHONE
— w —		WATER LINE
CONC.		CONCRETE
SW		SIDEWALK
EP		EDGE OF PAVEMENT
D&M		DEED AND MEASURED
СР	Δ	PRIMARY CONTROL POINT
ВМ	•	BENCHMARK

FROM CENTER OF PROPERTY - VIEWS FROM RIDGE ROAD -

FROM NORTHWEST CORNER OF PROPERTY

1.1'W

FRAME

AREA =

511.0± Sa.Ft. S

FF=634.78

SHED - AREA =

ASPHALT DRIVE

× 634.45

634.55 (34.55) 98.2± Sq.Ft. 634.63 × 634.55

GARAGE

634.07 **1.4'W** ASPHALT DRIVE × 633.93

- GRASS -

× 634.13

× 634.26

ASPHALT DRIVE

1-1/2 STORY

FRAME HOUSE

AREA = Sq.Ft.

2007 RIDGE ROAD

2007 RIDGES LLC GLR HOLDINGS LLC (RECORD OWNER) (RECORD 06-1-13 SBL 143.06-1781

× 633.15

No. 1997

1-1/2 STORY

FRAME


HOUSE

1,012.4± Sq.Ft.

634.13\* \*634.09

**4** × 634.86

ASPHALT DRIVE × 634.39

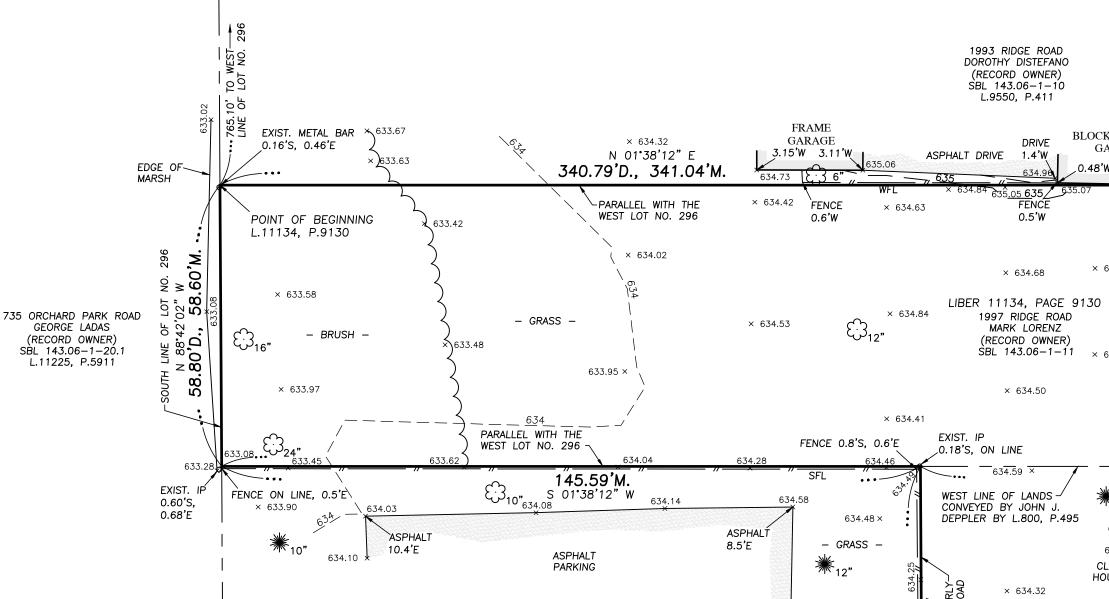

PARCEL ZONING INFORMATION PROVIDED: ZONING TABLE PREPARED BY THE TOWN OF WEST SENECA DATED 3/21/2021 SHOWN BELOW.

LOCAL JURISDICTION:	TOWN OF WEST SENECA
ZONING CLASSIFICATIO	N R 60A RESIDENCE DISTRICT (PROPOSED C-2 (S) REZONING)
PERMITTED USES:	SPECIAL USE PERMIT TO ALLOW OPERATION AS A EATING OR DRINKING ESTABLISHMENTS, PROVIDED THAT ANY ENTERTAINMENT SHALL BE LIMITED TO TELEVISION, RADIO OR RECORDED MUSIC, AND FURTHER PROVIDED THAT NO SALES OF ALCOHOLIC BEVERAGES FOR CONSUMPTION ON THE PREMISES SHALL BE PERMITTED ON ANY LOT WHERE A SIDE LOT ABUTS ANY R DISTRICT BOUNDARY.
OWNER:	MARK A. LORENZ, SR. (CURRENT), JSC MANAGEMENT GROUP, LLC (UNDER CONTRACT)
PROPERTY ACREAGE:	0.794+/- ACRES PER 8/12/2021 SURVEY

BULK REQUIREMENTS	REQUIRED	PROPOSED	VARIANCE
FRONT YARD	40 FT MINIMUM	± 46 FT	NO
REAR YARD	10 FT; IF REAR YARD ABUTS R DISTRICT BOUNDARIES, THE REAR YARD SHALL BE:30 FT OR A DISTANCE EQUAL TO THE HEIGHT OF THE PRINCIPAL BUILDING, WHICHEVER IS GREATER.	± 230 FT	NO.
SIDE YARD	5 FT. IF SIDE YARD ABUTS AN R DISTRICT ZONE, MINIMUM REQUIRED FOR SIDE YARDS FOR MULTIFAMILY DWELLING/MIXED OCCUPANCY IN. THE ABUTTING R DISTRICT (5 FT FOR SINGLE FAMILY).	± 27 FT	NO
MINIMUM LOT AREA	900 SF	± 34,550 SQ FT	NO
MINIMUM LOT	50 FT	± 108 FT	NO
MAXIMUM BUILDING COVERAGE	50% (34,550 SQ FT)	± 7.92%	NO
MAXIMUM BUILDING HEIGHT	40 FT	24 FT	NO
INGRESS/EGRESS MINIMUM DRIVE WIDTH	A 30 FT DRIVE FOR INGRESS / EGRESS SHALL BE PROVIDED FOR ALL MULTIFAMILY AND SPECIAL DEVELOPMENTS OR 20 FT MIN, FOR SEPARATE INGRESS / EGRESS DRIVES:	20 FT & 22 FT	NO.
PARKING REQUIREMENT	3 SPACES FOR EACH 5 SEATS (40 SEATS = 24 SPACES)	18 SPACES	YES
PARKING STALL WIDTH	9 FT MIN	9 FT	NO
PARKING STALL LENGTH	18 FT MIN	18 FT	NO
MINIMUM STACKING REQUIREMENTS	5 SPACES PER BOOTH / SERVICE WINDOW	9 SPACES	NO
OFF-STREET PARKING SETBACK (PAVEMENT)	NO OPEN OFF-STREET PARKING SPACE WITHIN 10 FT OF ANY STREET LINE OR ANY R DISTRICT BOUNDARY.	6.34' (W) & 3.44' (E)	YES

SURVEY CONTROL

VERTICAL DATUM = NAVD88 (GEOID 18)

HORIZONTAL DATUM = NAD83 (2011)


ALL UNDERGROUND UTILITY LOCATIONS ARE APPROXIMATE. BEFORE


1-800-962-7962


YOU DIG, DRILL, OR BLAST, CALL DIG SAFELY NEW YORK AT


25 ORCHARD PARK ROAD S.K.S.K. REALTY, INC. (RECORD OWNER) SBL 143.06-1-18.1 L.10876, P.3073


△ <sub>CP #2</sub>

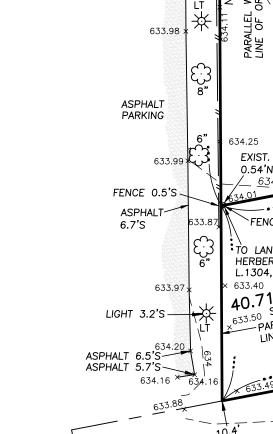

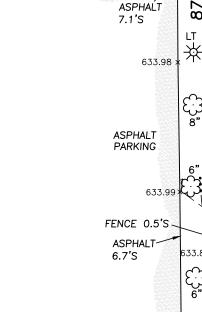

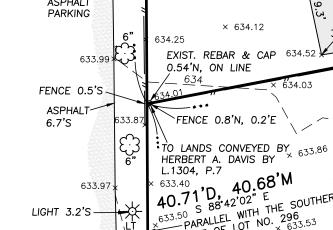

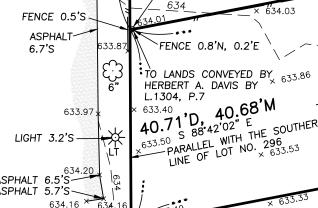

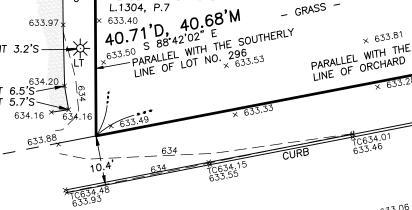

ASPHALT PARKING LOT -× 633.22 × 633.06 2021 RIDGE ROAD 2021 RIDGE ROAD LLC (RECORD OWNER) SBL 143.06-1-14.1 L.11375, P.8310 × 633.82

BLOCK & FRAME

GARAGE

× 634.61

× 634.50

× 634.32

× 634.69 634.83

HOUSE × 634.44

× 634.24

× 634.46

LIBER 11079, PAGE 2477 2003 RIDGE ROAD

MARK A. LORENZ SR.

(RECORD OWNER)

GRASS -

CERTIFICATION:

JSC West Seneca Land LLC Stewart Title Insurance Company Woods Oviatt Gilman LLP Northern Bank & Trust Company Mawn and Mawn, P.C.

This is to certify that this map or plat and the survey on which it is based were made in accordance with the 2021 Minimum Standard Detail Requirements for ALTA/NSPS Land Title Surveys, jointly established and adopted by ALTA and NSPS, and includes items 1,2,3,4,5,6a,6b,7a,7b1,7c,8,9,11(a),11(b),13,14,15,16,17,18 and19 of Table A thereof. The field work was completed on 8/12/2021.

Rosanne Frandina, PLS, PE New York State License No. 50510

Date of Plat or Map:\_\_\_\_\_

8/12/2021 10/14/2021 REVISED PER 9/23/21 REVIEW MJC 8/12/2021 ADD PARCEL SBL 143.06-1-13 | MJC 11/19/2021 8/12/2021 1/23/2021 REVISED PER COMMENTS MJC ADD CERTIFICATION PARTIES MJC 8/12/2021 2/13/2021 8/12/2021 ADD SCHED. B, ITEM NO.26 NOTE MJC 12/13/2021 8/12/2021 2/4/2022 UPDATE TITLE POLICY INFO.

COMMENT

This map void unless Embossed with New ork State Licensed Land Surveyors Seal No. 50510

NO. 1997 RIDGE ROAD ~ SBL NO. 143.06-1-11 NO. 2003 RIDGE ROAD ~ SBL NO. 143.06-1-12 NO. 2007 RIDGE ROAD ~ SBL NO. 143.06-1-13 ALTA/NSPS LAND TITLE SURVEY PART OF LOT 296, TWP 10, RGE 7

PRELIMINARY

OUT FOR REVIEW 2/4/2022

OF THE BUFFALO CREEK RESERVATION TOWN OF WEST SENECA COUNTY OF ERIE ~ STATE OF NEW YORK

FRANDINA ENGINEERING and LAND SURVEYING. PC CIVIL ENGINEERS and LAND SURVEYORS

1701 Hertel Avenue, Buffalo, New York 14216 Phone: (716) 883-1299 www.FRANDINA.com

CADD \ 4775 1997-2003 RIDGE RD BURGER KING.DWG

DATE OF SURVEY DATE OF REVISION

Rosanne Frandina, PE, LS

DRAWING NAME: SURVEY DATE: 8/12/2021 JOB NO.: 4775

SHEET NO.: SV SHEET: 1 OF 1 DWN BY: MJC SCALE: 1" = 20'CHK'D BY: RF




# SITE DEVELOPMENT PLANS

**FOR** 

# BURGER KING - TOWN OF WEST SENECA, NY

1997, 2003, & 2007 RIDGE ROAD WEST SENECA, NY, 14224

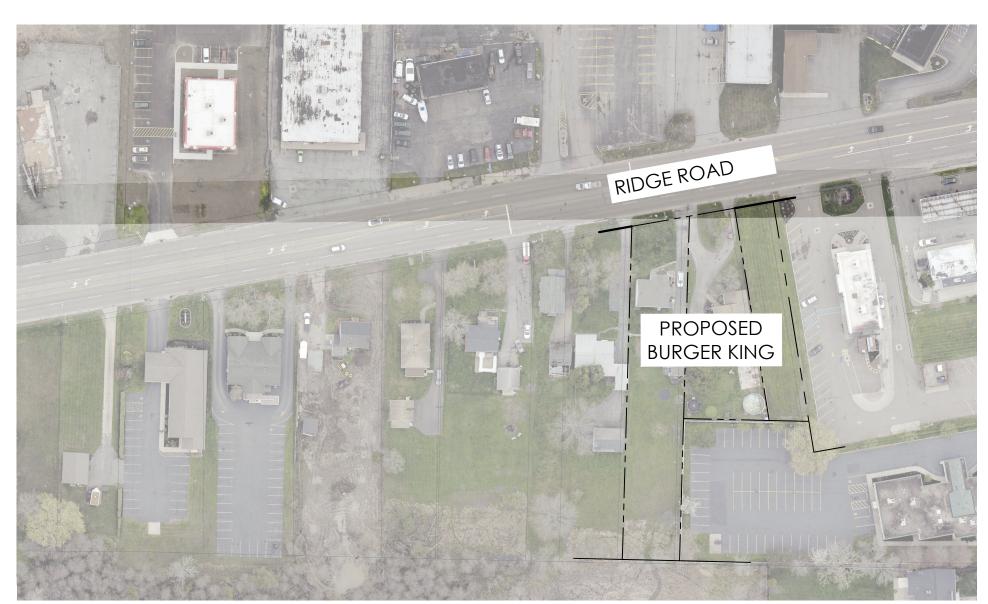

**LOCATION SKETCH** 

#### **DRAWING LIST:**

Cover Sheet Survey C1 Demolition Plan C2 Overall Site Plan C2.1 Site Plan C3 Grading & Drainage Plan C3.1 Stormwater Plan C4 Utility Plan C5 Planting & Lighting Plan C6 Details Sheet Details Sheet C8 Details Sheet C9 Details Sheet

Specifications

#### **CLIENT:**

JSC MANAGEMENT GROUP BURGER KING FRANCHISEE PO BOX 217 LYNDONVILLE NY 14098 (585) 755-3950

# **ENGINEER:**

APD ENGINEERING & ARCHITECTURE 615 FISHERS RUN VICTOR, NY 14564 (585) 742-0222 CONTACT: TODD MARKEVICZ, P.E.

## **AGENCY & MUNICIPALITY CONTACTS:**

TOWN OF WEST SENECA 1250 UNION ROAD, ROOM 210 WEST SENECA, NY 14224 716-558-3242 CONTACT: JEFFREY SCHIEBER

## **UTILITY CONTACTS:**

ELECTRIC SERVICE: NYSEG LANCASTER ELECTRIC ADDRESS: 150 ERIE ST, LANCASTER, NY 14086 PHONE: 1-716-681-5030 CONTACT:

GAS SERVICE: NATIONAL FUEL GAS | BUFFALO - NFG101 ADDRESS: 409 MAIN ST., BUFFALO, NY 14203 PHONE: 716-857-7431 **CONTACT: TIM NUGENT** 

PHONE SERVICE: VERIZON ADDRESS: 65 FRANKLIN STREET, ROOM 602, BUFFALO, NY 14202 PHONE: 716-398-5785 CONTACT: CAROLYN YUNKE

WATER SERVICE: ERIE COUNTY WATER AUTHORITY ADDRESS: 295 MAIN STREET, ROOM 350, BUFFALO, NY 14203 PHONE: 716-685-8207 CONTACT: ADAM MASSARO

SANITARY SEWER SERVICE: ERIE COUNTY DIVISION OF SEWER MANAGEMENT ADDRESS: 95 FRANKLIN STREET, ROOM 1034, BUFFALO, NY 14202 PHONE: 716-558- 3241 CONTACT: WEST SENECA CODE ENFORCEMENT - JEFF BASKA

Α		
В		
С		
D		_
Е		
F		
G		
Н		
	Revisions:	Date:
1	Revised per Town Comments	02/18/22
2		
3		
4		
5		
6		
7		
8		
	OF NEW MANUEL FIRM	IP'R

Issued:



Name: Todd G. Markevicz

Exp. Date: December 31, 2023

It is a violation of law for any person, unless acting under the

DO NOT SCALE PLANS

opying, Printing, Software and other processes required to produ Engineer of Record with any need for additional dimensions or





# JSC MANAGEMENT GROUP ATTN: JAMES CAMMILLERI BURGER KING FRANCHISEE 585.755.3950 Store #: Burger King

Burger King

S.B.L. No. 143.06-1-11, 12, & 13

1997, 2003, & 2007 Ridge Road

West Seneca, NY 14224

Erie County (Town of West Seneca)

Project Name & Location:


# Cover Sheet

Drawing Name:

Project No. Date: 04/19/21 21-0239 Type:

Drawn By: SAS

Drawing No. N.T.S.

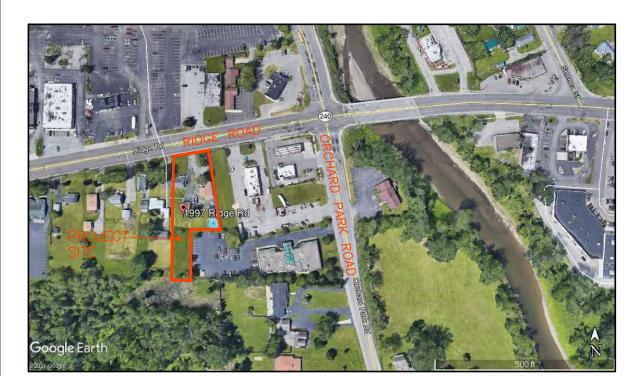

VICINITY MAP (NOT TO SCALE)

#### **RECORD DESCRIPTIONS:**

No. 1997 Ridge Road Parcel A Liber 11134, Page 9130

ALL That Tract or Parcel of Land, situate in the Town of West Seneca, County of Erie and State of New York, being part of Lot No. 296, Township 10, Range 7 of the Buffalo Creek Reservation and described as

BEGINNING at a point in the south line of said lot, 765.10 feet east of the west line of said lot; running thence easterly along the south line of said lot, 58.80 feet; thence northerly parallel with the west line of said lot, 349 feet to the south line of Ridge Road; thence westerly along the southerly line of Ridge Road 59.83 feet to a line drawn parallel with the west line of the lot from the place of beginning; thence southerly along said parallel line 340.79 feet to the south line of said lot at the place of beginning. Together with all right, title and interest of, in and to any streets and roads abutting the above—described premises.

Liber 11079, Page 2477

ALL That Tract Or Parcel Land, situate la the Town of West Seneca, County of Erie and State of New York, being part of Lot Number 296, Township 10, Range 7 of the Buffalo Creek Reservation bounded and

BEGINNING at a point in the southerly line of Ridge Road distant three hundred ten (310) feet westerly from the Intersection of said line of Ridge Road with the westerly line of Orchard Park Road, as measured along said line of Ridge Road, thence southerly parallel to the Orchard Park Road, two hundred twenty and ten hundredths (220.10) feet to lands conveyed by Herbert A. Davis by deed recorded in Liber 1304 of deeds at page 7, thence westerly and parallel to the southerly line of Lot No. 296 a distance of eight-seven and fifty six hundredths (87.56) feet to the westerly line of lands conveyed to John J. Deppler by deed recorded In Liber 800 of Deeds at page 495, thence northerly along said westerly line two hundred seven and eighteen hundredths (207.18) feet to the south line of Ridge Road, thence easterly along the south line of Ridge Road, forty—seven (47) feet to the place or beginning.

Note: the southerly course is missing in the supplied deed description No. 2007 Ridge Road

ALL THAT TRACT OR PARCEL OF LAND, situate in the Town of West Seneca, County of Erie and State of New York, being part of Lot Number 296 Township 10 Range 7 of the Buffalo Creek Reservation, bounded

Liber 11116, Page 1781

and described as follows: BEGINNING at a point in the southerly line of Ridge Road distant 270 feet westerly of the intersection of said line of Ridge Road with the westerly line of Orchard Park Road measured along said line of Ridge Road; thence westerly along said line of Ridge Road 40 feet; thence southerly and parallel with the Orchard Park Road 220.10 feet; thence easterly parallel with the southerly line of said lot No. 296, 40.71 feet; thence northerly parallel with said line of Orchard Park Road 228.10 feet to the southerly line of Ridge Road at the place of beginning.

PARCEL A: SBL 143.06-1-11 = 0.467± ACRES PARCEL B: SBL 143.06-1-12 = 0.327± ACRES PARCEL C: SBL  $143.06-1-13 = 0.206 \pm ACRES$ 

36029C0334H, EFFECTIVE DATE JUNE 7, 2019.

FLOOD ZONE CLASSIFICATION: PARCEL IS LOCATED IN ZONE-X "AREA OF MINIMAL FLOOD HAZARD" PER FEMA FLOOD INSURANCE RAIE MAP NO.

PARKING SPACES: THERE ARE NO DESIGNATED PARKING SPACES.

COMBINED AREA = 1.000± ACRES

ITEM 15: THERE WAS NO RECTIFIED ORTHOPHOTOGRAPHY, PHOTOGRAMMETRIC MAPPING, REMOTE SENSING, AIRBORNE/MOBILE LASER SCANNING USED FOR THIS SURVEY

ITEM 16: THERE WAS NO EVIDENCE OF RECENT EARTH MOVING WORK, BUILDING CONSTRUCTION OR BUILDING ADDITIONS OBSERVED IN THE PROCESS OF CONDUCTING THE

ITEM 17: NO INFORMATION REGARDING PROPOSED CHANGES TO STREET RIGHT OF WAY LINES WAS PROVIDED TO THE SURVEYOR

ITEM 18: NO PLOTTABLE EASEMENTS DISCLOSED IN DOCUMENTS WERE SUPPLIED TO THE SURVEYOR

**UTILITY NOTES:** 

1) DEPTH AND ACTUAL LOCATION OF UTILITY LINES OTHER THAN SANITARY AND STORM SEWER LINES HAVE NOT BEEN PHYSICALLY MEASURED IN THE FIELD.

2) NO STORM SEWER INFORMATION WAS PROVIDED THROUGH THE DIG SAFELY UTILITY DESIGN REQUEST.

COMMITMENT FOR TITLE INSURANCE NO. 1997, 2003 & 2007 RIDGE ROAD: TITLE POLICY AND TITLE SEARCH PROVIDED BY STEWART TITLE INSURANCE COMPANY, POLICY NO. WOG-3624 WITH EFFECTIVE DATE OF 9/7/2021.

SCHEDULE B NOTES (POLICY NO. WOG-3624): AFFECTS PARCELS A & B:

ITEM NO. 26: EASEMENT GRANTED TO NEW YORK STATE ELECTRIC AND GAS CORPORATION BY INSTRUMENT DATED JULY 12, 1944 AND RECORDED IN THE ERIE COUNTY CLERK'S OFFICE ON SEPTEMBER 5, 1944 IN LIBER 3593 OF DEEDS, PAGE 291. NOTED HEREON.

AFFECTS PARCEL C: DECLARATION OF EASEMENT BY AND BETWEEN FX NET LEASE HOLDINGS LLC AND GLR HOLDINGS LLC DATED MARCH 11, 2016 AND RECORDED IN THE ERIE COUNTY CLERK'S OFFICE ON MARCH 29, 2016 IN LIBER 11293 OF DEEDS, PAGE 9881. BLANKET EASEMENT AFFECTING SEVERAL PARCELS, NOT PLOTTABLE.

SURVEY REFERENCES

TAX MAP 143.06 LIBER 11079, PAGE 2477 (NO. 1997 RIDGE ROAD) LIBER 11134, PAGE 9130 (NO. 2003 RIDGE ROAD) LIBER 10876, PAGE 3073 (SBL 143.06-1-18.11) LIBER 11116, P.1781 (NO. 2021 RIDGE ROAD)

NOTE: NO PREVIOUS SURVEYS OR MAPS WERE PROVIDED OR OBTAINED WHILE PREPARING THIS SURVEY.

WARNING: ALTERING THIS DOCUMENT IS IN VIOLATION OF THE LAW EXCEPTING AS PROVIDED IN SECTION 7209, PART 2 OF THE NEW YORK STATE EDUCATION LAW.

THIS SURVEY WAS PREPARED WITHOUT THE BENEFIT OF AN ABSTRACT OF TITLE AND IS SUBJECT TO ANY STATEMENT OF FACTS THAT MAY BE REVEALED BY AN EXAMINATION OF SUCH.

NOTE: THE UNDERGROUND UTILITIES SHOWN HAVE BEEN LOCATED FROM FIELD SURVEY INFORMATION AND EXISTING DRAWINGS. THE SURVEYOR MAKES NO GUARANTEES THAT THE UNDERGROUND UTILITIES SHOWN COMPRISE ALL SUCH UTILITIES IN THE AREA, EITHER IN SERVICE OR ABANDONED. THE SURVEYOR FURTHER DOES NOT WARRANT THAT THE UNDERGROUND UTILITIES SHOWN ARE IN THE EXACT LOCATION INDICATED. THE SURVEYOR DOES CERTIFY THAT THEY ARE LOCATED AS ACCURATELY AS POSSIBLE FROM INFORMATION AVAILABLE. THE SURVEYOR HAS NOT PHYSICALLY LOCATED THE UNDERGROUND UTILITIES.









DRIVE

0.2'W、

633.16 633.12 /

EXIST. IP 633.104 EXIST. IP FENCE 53.1'S. F4

\ × 631.93

× 633.47

ASPHALT DRIVE

------GARDEN

<sup>UP</sup> 207.18'D&M

SEE EASEMENT GRANTED TO NEW YORK

L.3593, P,291, SHEDULE B, ITEM NO. 20

× 633.56

53.1'S, 51.2'S,

633.58 ×

0.57°E

0.10'E


GRASS -

× 633.65

× 632.69

STATE ELECTRIC AND GAS CORP. BY

632.80 ×

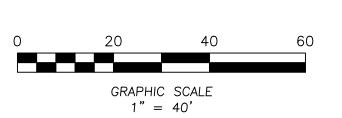

RPD

G

RO

-POINT OF

BEGINNING


L.11079, P.2477

∼DI #209 RIM=629.25

INV 18"CMP N=626.05

INV 6"CMP E=626.15

INV 6"CMP W=626.75

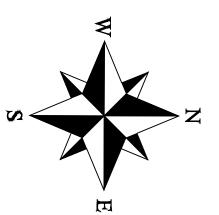

LEGEND

CLF	—//—	CHAIN LINK FENCE
SFL	—//—	STOCKADE FENCE
WFL	—//—	WIRE FENCE
мв		MAIL BOX
	þ	SIGN
	Œ	TREE DECIDUOUS
—G—		GAS LINE
GM	G	GAS METER
GV	×	GAS VALVE
DI		DRAINAGE INLET
—st—		STORM SEWER LINE
SCO	00	SEWER CLEANOUT
—SA—		SANITARY SEWER LINE
INV	(	INVERT ELEVATION
TC	TR	TRAFFIC CONTROL BOX
LIGHT	<del>-</del> \$ <del>-</del>	LIGHT STANDARD
ЕМ	E	ELECTRIC METER
UP	Ø	UTILITY POLE
—онw—		OVERHEAD WIRES
—UE—		UNDERGROUND ELECTRIC
—uT—		UNDERGROUND TELEPHONE
— w —		WATER LINE
CONC.		CONCRETE
SW		SIDEWALK
EP		EDGE OF PAVEMENT
D&M		DEED AND MEASURED
СР	Δ	PRIMARY CONTROL POINT
ВМ	•	BENCHMARK

FROM CENTER OF PROPERTY - VIEWS FROM RIDGE ROAD -

FROM NORTHWEST CORNER OF PROPERTY

1.1'W

FRAME

AREA =

511.0± Sa.Ft. S

FF=634.78

SHED - AREA =

ASPHALT DRIVE

× 634.45

634.55 (34.55) 98.2± Sq.Ft. 634.63 × 634.55

GARAGE

634.07 **1.4'W** ASPHALT DRIVE × 633.93

- GRASS -

× 634.13

× 634.26

ASPHALT DRIVE

1-1/2 STORY

FRAME HOUSE

AREA = Sq.Ft.

2007 RIDGE ROAD

2007 RIDGES LLC GLR HOLDINGS LLC (RECORD OWNER) (RECORD 06-1-13 SBL 143.06-1781

× 633.15

No. 1997

1-1/2 STORY

FRAME


HOUSE

1,012.4± Sq.Ft.

634.13\* \*634.09

**4** × 634.86

ASPHALT DRIVE × 634.39

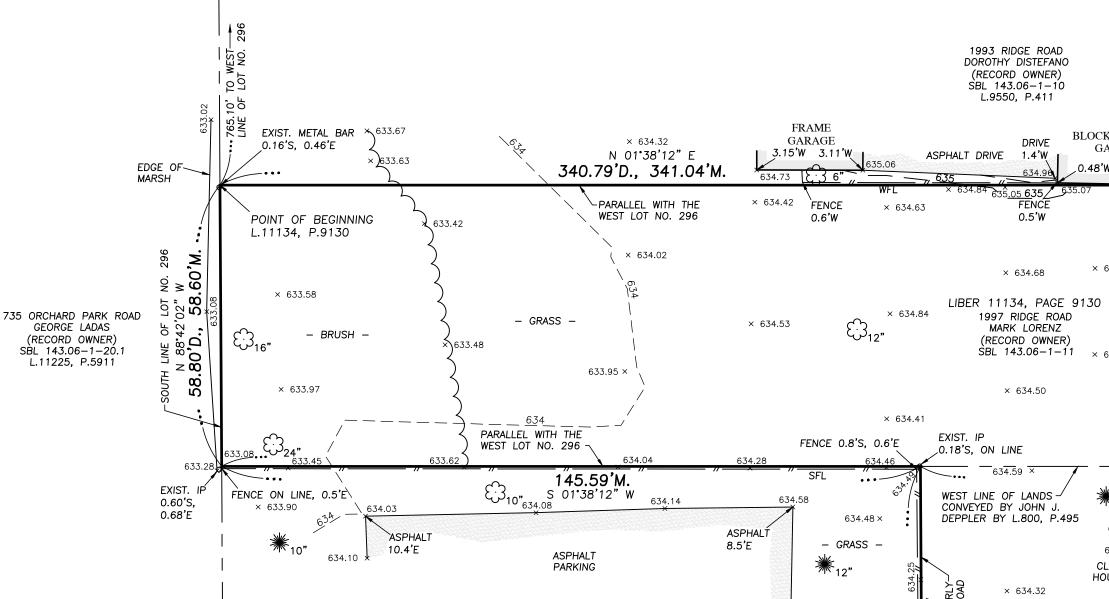

PARCEL ZONING INFORMATION PROVIDED: ZONING TABLE PREPARED BY THE TOWN OF WEST SENECA DATED 3/21/2021 SHOWN BELOW.

LOCAL JURISDICTION:	TOWN OF WEST SENECA
ZONING CLASSIFICATIO	N R 60A RESIDENCE DISTRICT (PROPOSED C-2 (S) REZONING)
PERMITTED USES:	SPECIAL USE PERMIT TO ALLOW OPERATION AS A EATING OR DRINKING ESTABLISHMENTS, PROVIDED THAT ANY ENTERTAINMENT SHALL BE LIMITED TO TELEVISION, RADIO OR RECORDED MUSIC, AND FURTHER PROVIDED THAT NO SALES OF ALCOHOLIC BEVERAGES FOR CONSUMPTION ON THE PREMISES SHALL BE PERMITTED ON ANY LOT WHERE A SIDE LOT ABUTS ANY R DISTRICT BOUNDARY.
OWNER:	MARK A. LORENZ, SR. (CURRENT), JSC MANAGEMENT GROUP, LLC (UNDER CONTRACT)
PROPERTY ACREAGE:	0.794+/- ACRES PER 8/12/2021 SURVEY

BULK REQUIREMENTS	REQUIRED	PROPOSED	VARIANCE
FRONT YARD	40 FT MINIMUM	± 46 FT	NO
REAR YARD	10 FT; IF REAR YARD ABUTS R DISTRICT BOUNDARIES, THE REAR YARD SHALL BE:30 FT OR A DISTANCE EQUAL TO THE HEIGHT OF THE PRINCIPAL BUILDING, WHICHEVER IS GREATER.	± 230 FT	NO.
SIDE YARD	5 FT. IF SIDE YARD ABUTS AN R DISTRICT ZONE, MINIMUM REQUIRED FOR SIDE YARDS FOR MULTIFAMILY DWELLING/MIXED OCCUPANCY IN. THE ABUTTING R DISTRICT (5 FT FOR SINGLE FAMILY).	± 27 FT	NO
MINIMUM LOT AREA	900 SF	± 34,550 SQ FT	NO
MINIMUM LOT	50 FT	± 108 FT	NO
MAXIMUM BUILDING COVERAGE	50% (34,550 SQ FT)	± 7.92%	NO
MAXIMUM BUILDING HEIGHT	40 FT	24 FT	NO
INGRESS/EGRESS MINIMUM DRIVE WIDTH	A 30 FT DRIVE FOR INGRESS / EGRESS SHALL BE PROVIDED FOR ALL MULTIFAMILY AND SPECIAL DEVELOPMENTS OR 20 FT MIN, FOR SEPARATE INGRESS / EGRESS DRIVES:	20 FT & 22 FT	NO.
PARKING REQUIREMENT	3 SPACES FOR EACH 5 SEATS (40 SEATS = 24 SPACES)	18 SPACES	YES
PARKING STALL WIDTH	9 FT MIN	9 FT	NO
PARKING STALL LENGTH	18 FT MIN	18 FT	NO
MINIMUM STACKING REQUIREMENTS	5 SPACES PER BOOTH / SERVICE WINDOW	9 SPACES	NO
OFF-STREET PARKING SETBACK (PAVEMENT)	NO OPEN OFF-STREET PARKING SPACE WITHIN 10 FT OF ANY STREET LINE OR ANY R DISTRICT BOUNDARY.	6.34' (W) & 3.44' (E)	YES

SURVEY CONTROL

VERTICAL DATUM = NAVD88 (GEOID 18)

HORIZONTAL DATUM = NAD83 (2011)


ALL UNDERGROUND UTILITY LOCATIONS ARE APPROXIMATE. BEFORE


1-800-962-7962


YOU DIG, DRILL, OR BLAST, CALL DIG SAFELY NEW YORK AT


25 ORCHARD PARK ROAD S.K.S.K. REALTY, INC. (RECORD OWNER) SBL 143.06-1-18.1 L.10876, P.3073

△ <sub>CP #2</sub>

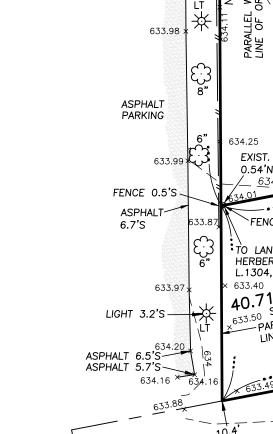

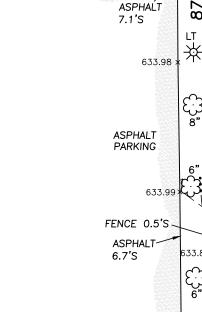

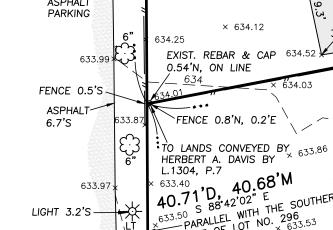

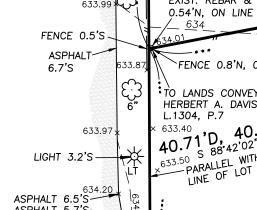

FENCE 0.8'N, 0.2'E HERBERT A. DAVIS BY L.1304, P.7

LANDS CONVEYED BY 633.86 × 633.40 40.71'D, 40.68'M 40.71 S 88'42'02" E SOUTH

ASPHALT PARKING LOT -× 633.22 × 633.06 2021 RIDGE ROAD 2021 RIDGE ROAD LLC (RECORD OWNER) SBL 143.06-1-14.1 L.11375, P.8310 × 633.82

BLOCK & FRAME

GARAGE

× 634.61

× 634.50

× 634.32

× 634.69 634.83

HOUSE × 634.44

× 634.24

× 634.46

LIBER 11079, PAGE 2477 2003 RIDGE ROAD

MARK A. LORENZ SR.

(RECORD OWNER)

GRASS -

CERTIFICATION:

This is to certify that this map or plat and the survey on which it is based were made in accordance with the 2021 Minimum Standard Detail Requirements for ALTA/NSPS Land Title Surveys, jointly established and adopted by ALTA and NSPS, and includes items 1,2,3,4,5,6a,6b,7a,7b1,7c,8,9,11(a),11(b),13,14,15,16,17,18 and19 of Table A thereof. The field work was completed on 8/12/2021.

Rosanne Frandina, PLS, PE New York State License No. 50510

JSC West Seneca Land LLC Stewart Title Insurance Company Woods Oviatt Gilman LLP Northern Bank & Trust Company Mawn and Mawn, P.C.

Date of Plat or Map:\_\_\_\_\_

DATE OF SURVEY DATE OF REVISION COMMENT 8/12/2021 10/14/2021 REVISED PER 9/23/21 REVIEW MJC 8/12/2021 ADD PARCEL SBL 143.06-1-13 | MJC 11/19/2021 8/12/2021 1/23/2021 REVISED PER COMMENTS MJC ADD CERTIFICATION PARTIES MJC 8/12/2021 2/13/2021 8/12/2021 ADD SCHED. B, ITEM NO.26 NOTE MJC 12/13/2021 8/12/2021 2/4/2022 UPDATE TITLE POLICY INFO.

This map void unless Embossed with New ork State Licensed Land Surveyors Seal No. 50510

NO. 2003 RIDGE ROAD ~ SBL NO. 143.06-1-12 NO. 2007 RIDGE ROAD ~ SBL NO. 143.06-1-13

SAMH #400 RIM=628.72

INV 8"PVC SW=624.39

ALTA/NSPS LAND TITLE SURVEY PART OF LOT 296, TWP 10, RGE 7 OF THE BUFFALO CREEK RESERVATION

PRELIMINARY

OUT FOR REVIEW 2/4/2022

TOWN OF WEST SENECA COUNTY OF ERIE ~ STATE OF NEW YORK

NO. 1997 RIDGE ROAD ~ SBL NO. 143.06-1-11


FRANDINA ENGINEERING and LAND SURVEYING. PC CIVIL ENGINEERS and LAND SURVEYORS 1701 Hertel Avenue, Buffalo, New York 14216 Phone: (716) 883-1299

DRAWING NAME: SURVEY SHEET NO.: SV DATE: 8/12/2021 SHEET: 1 OF 1 DWN BY: MJC JOB NO.: 4775 SCALE: 1" = 20'CHK'D BY: RF


CADD \ 4775 1997-2003 RIDGE RD BURGER KING.DWG


Rosanne Frandina, PE, LS

www.FRANDINA.com

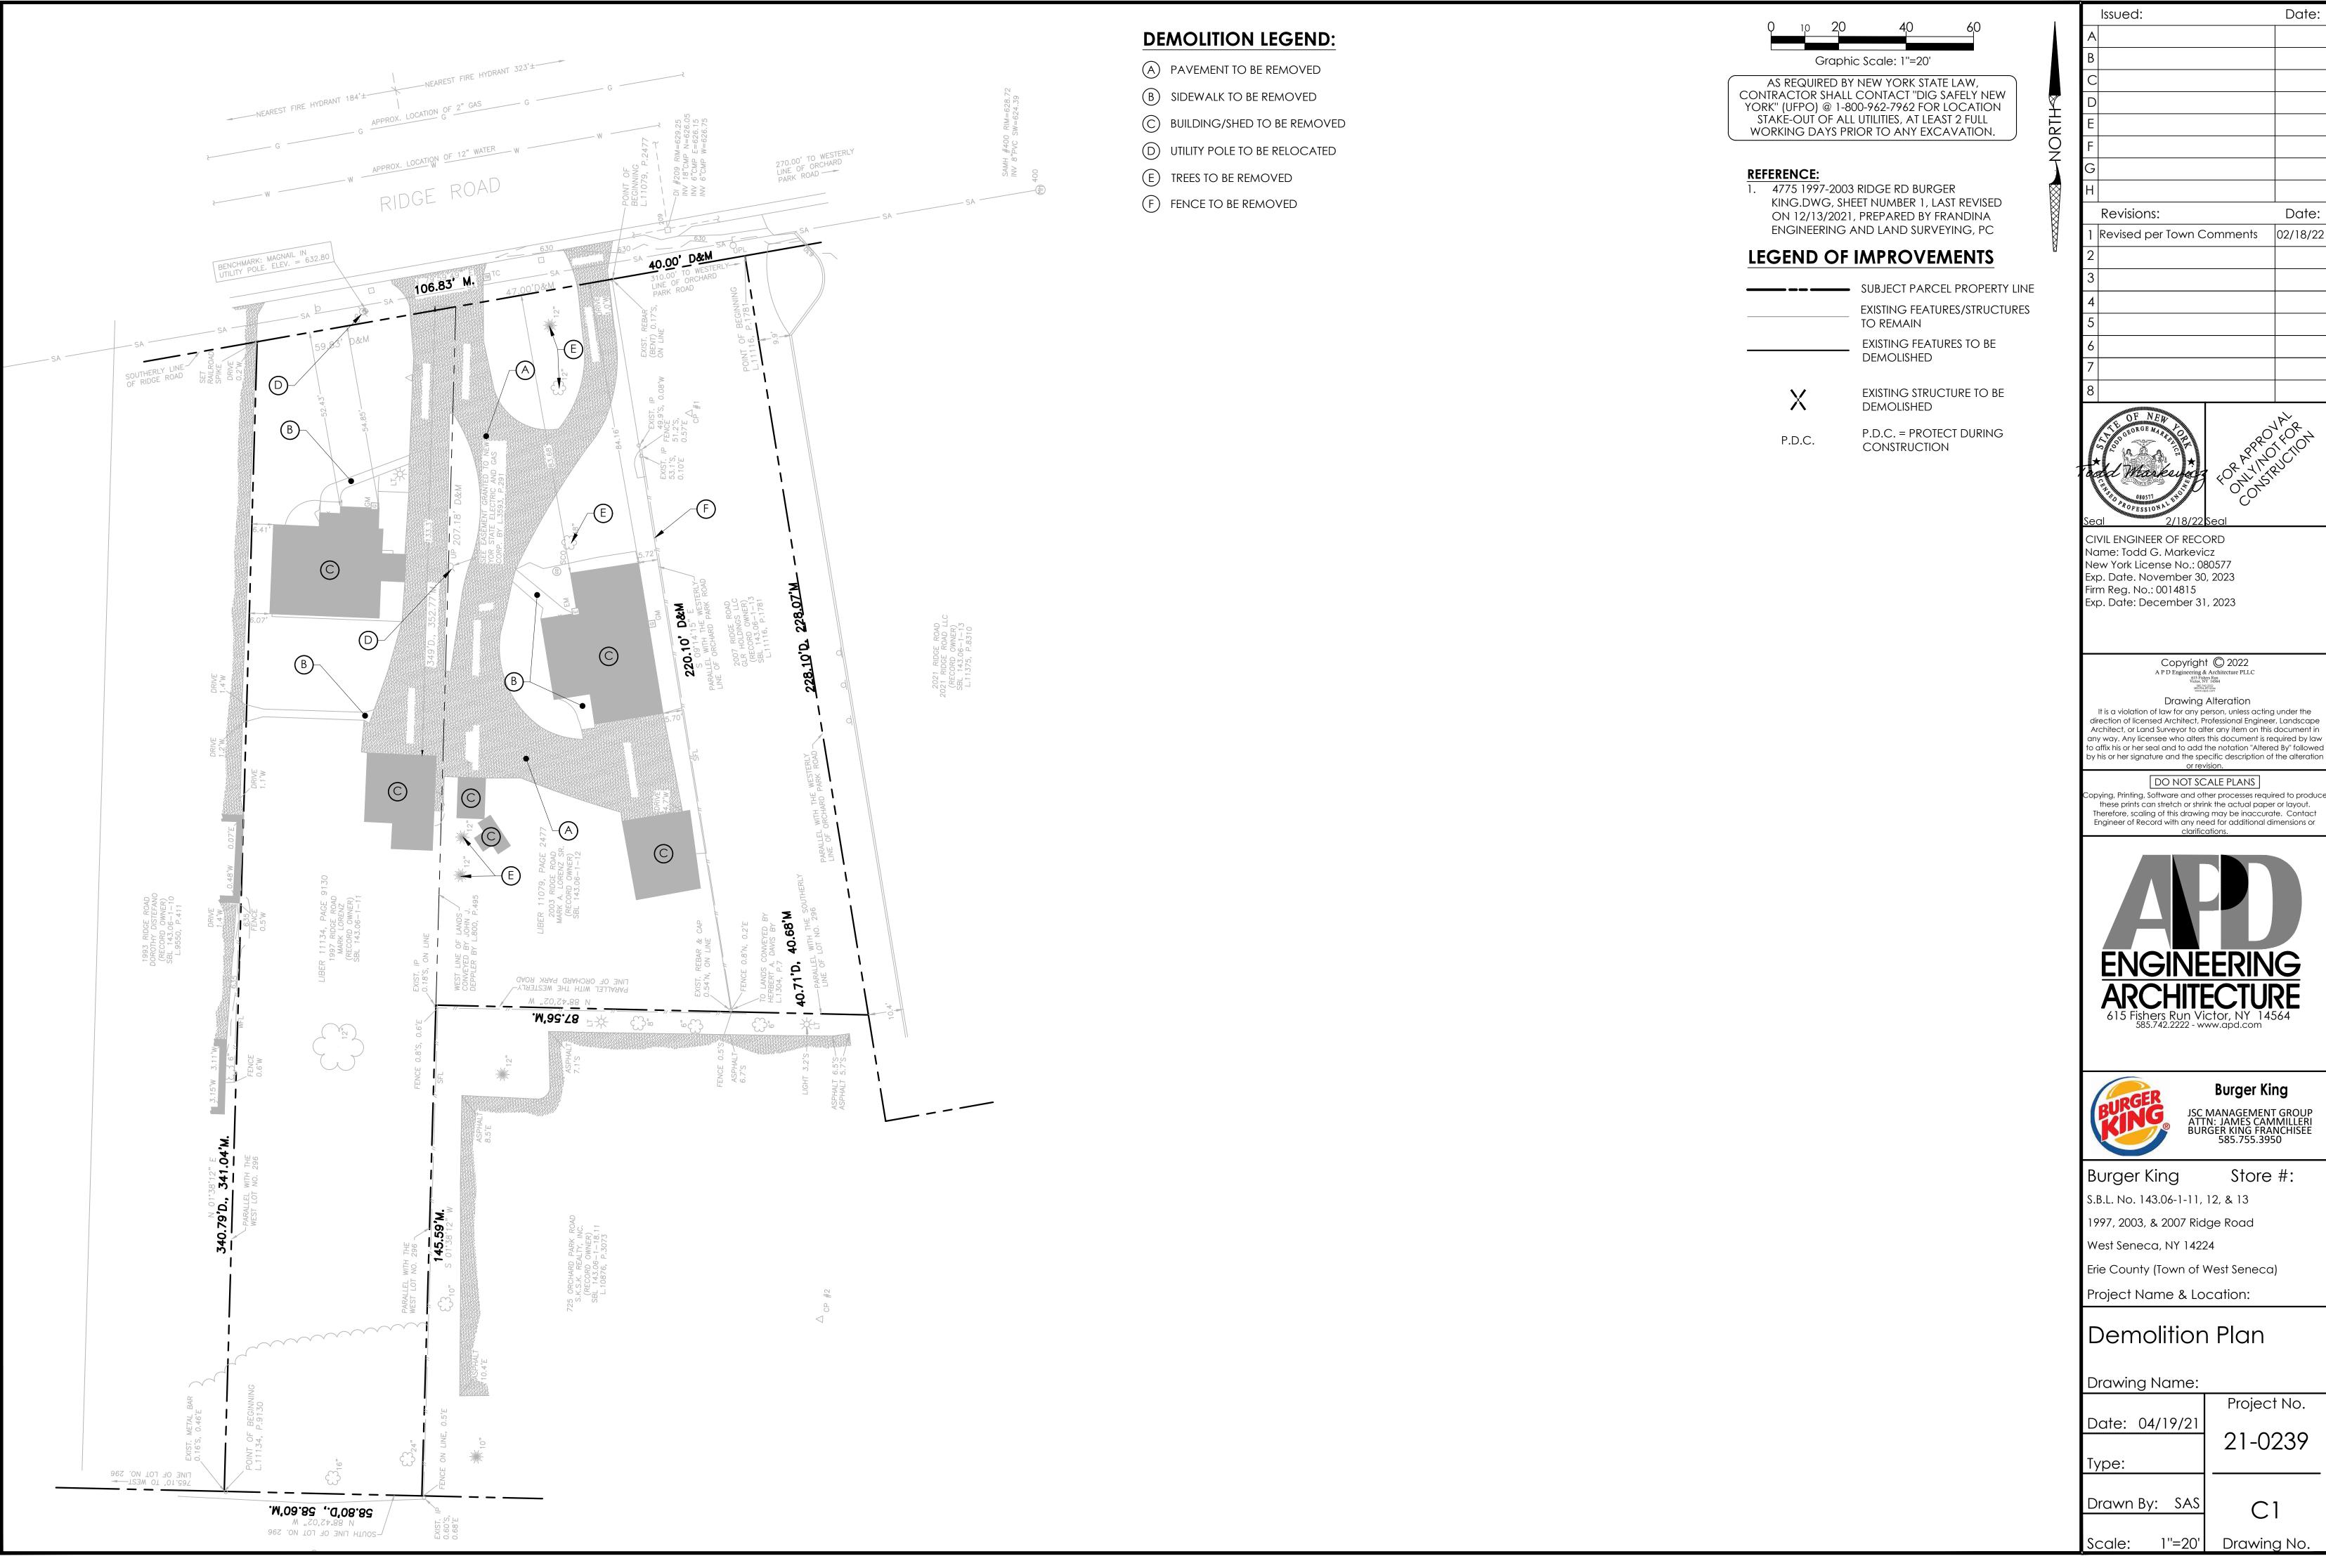

Date:

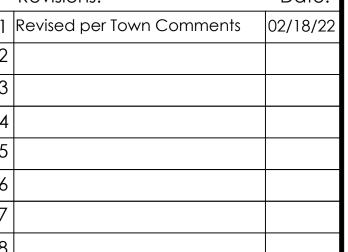

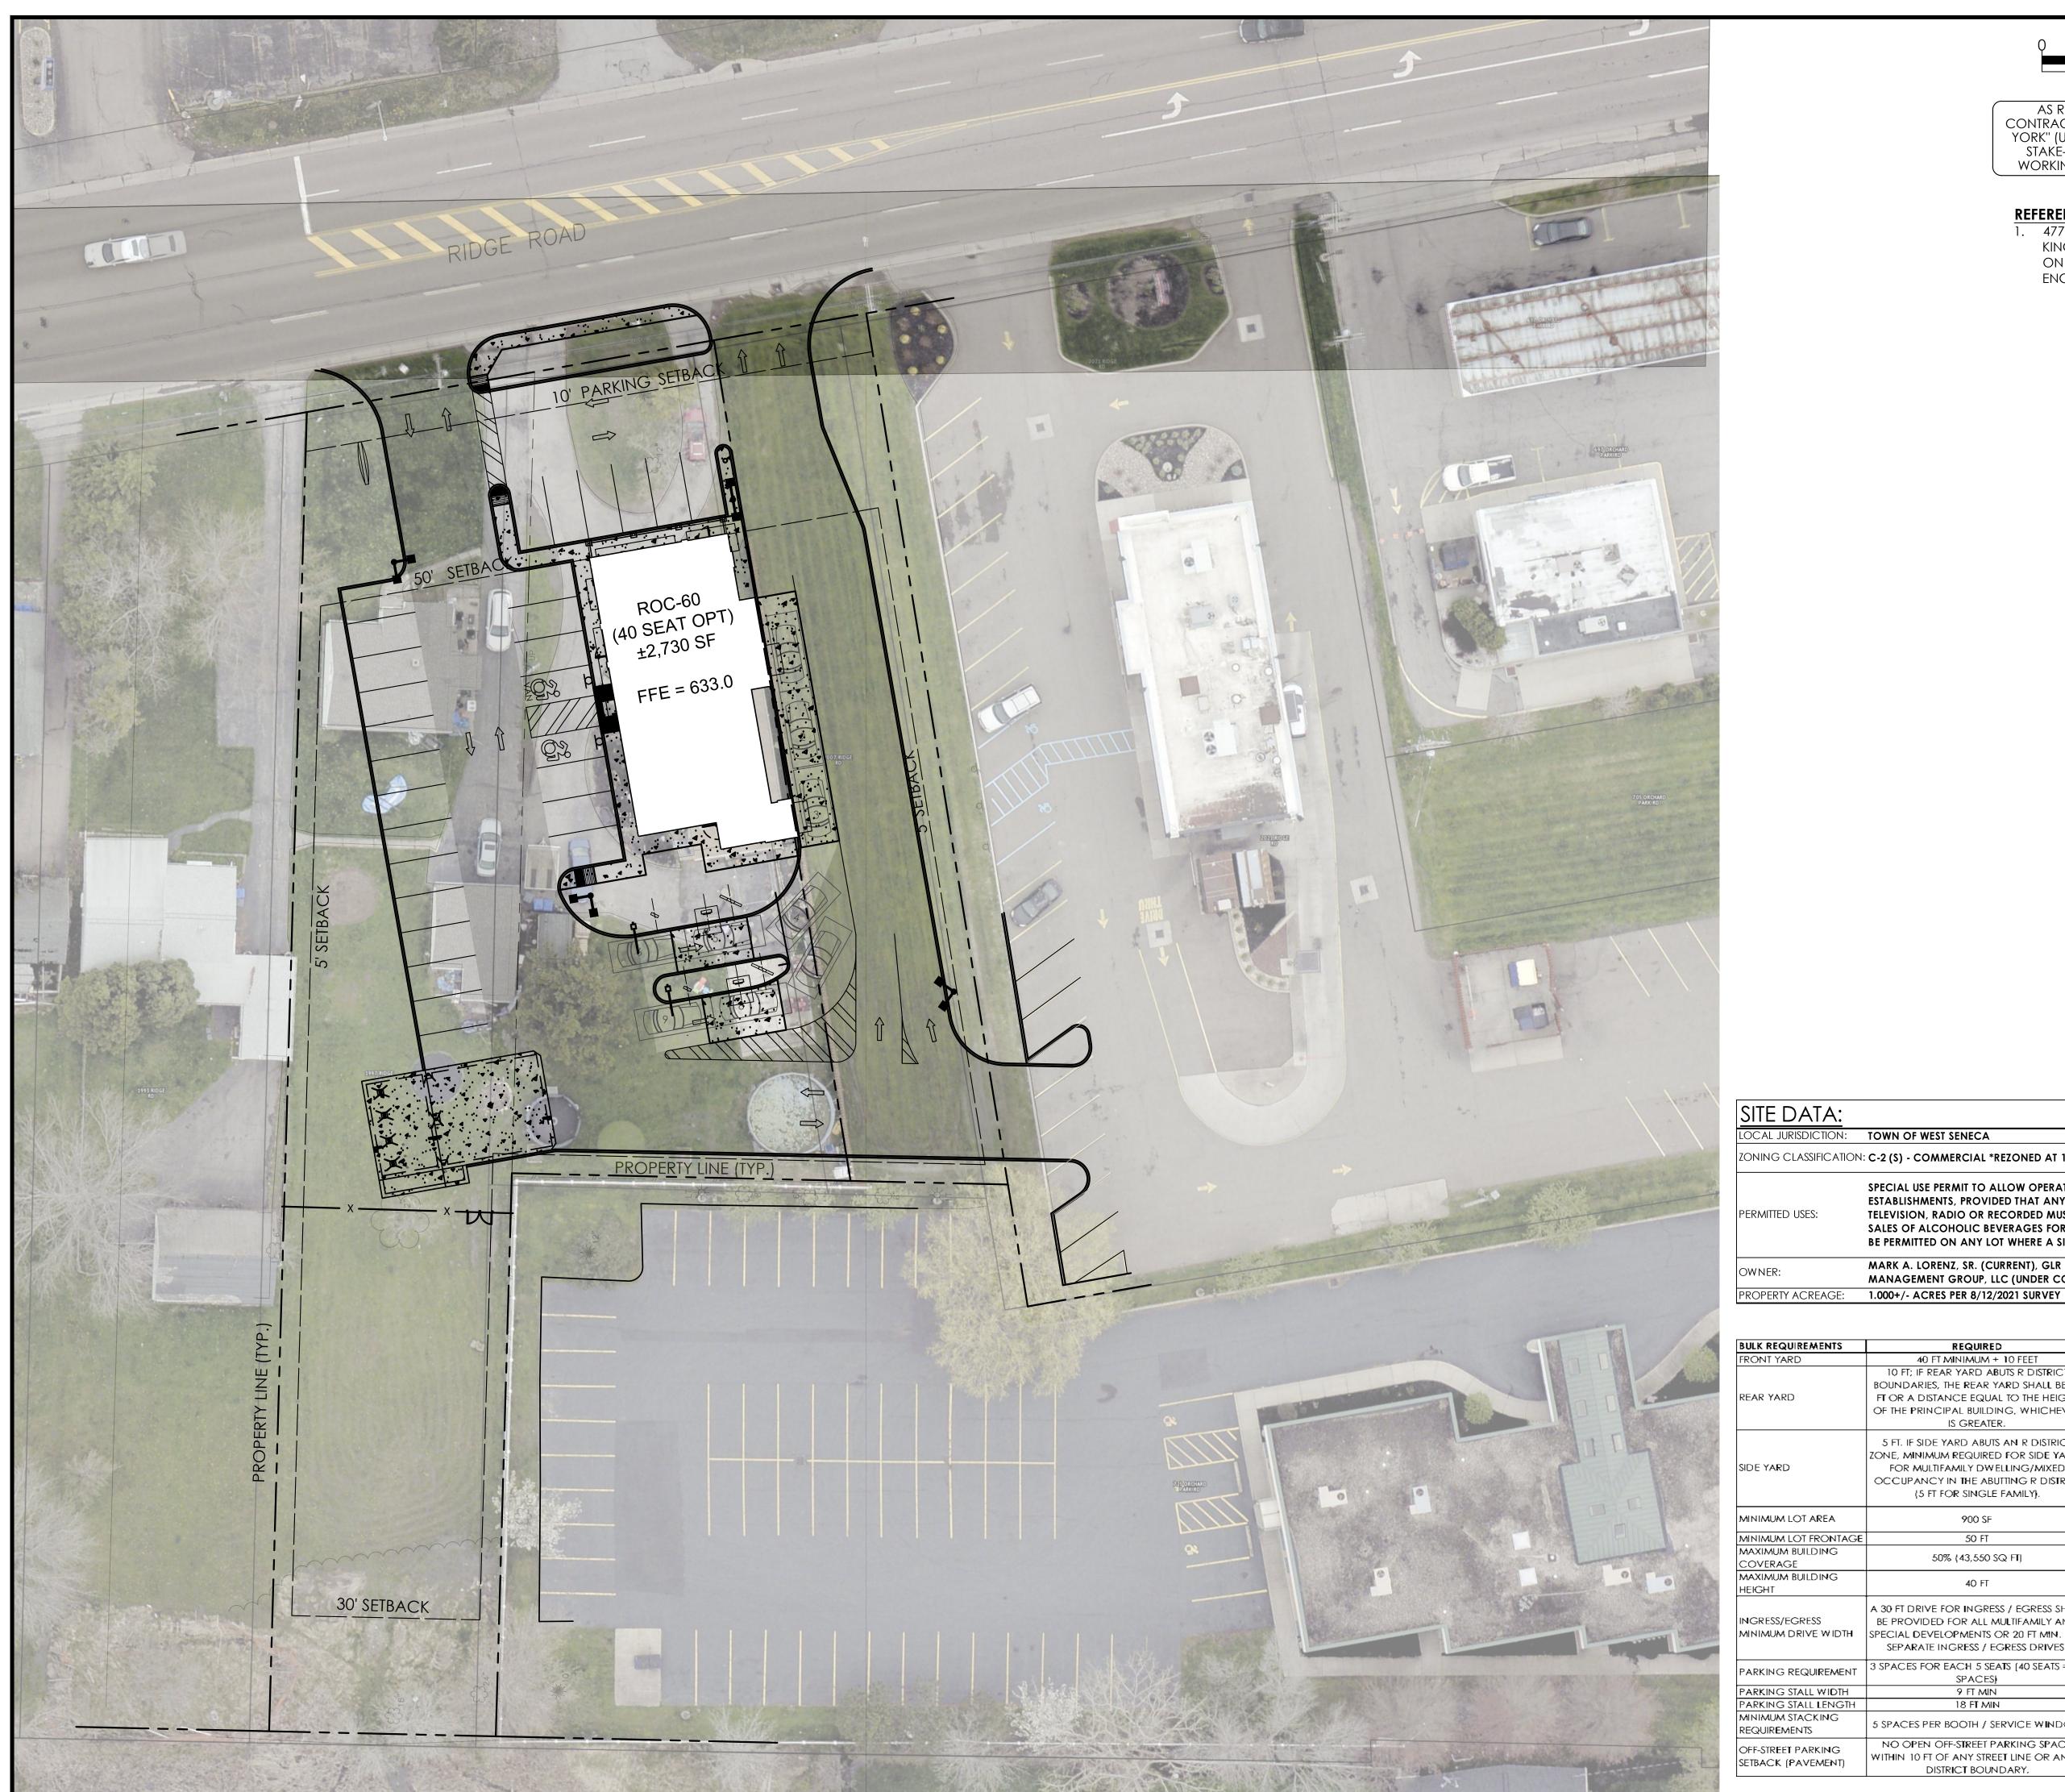



Graphic Scale: 1"=20'

AS REQUIRED BY NEW YORK STATE LAW,
CONTRACTOR SHALL CONTACT "DIG SAFELY NEW
YORK" (UFPO) @ 1-800-962-7962 FOR LOCATION
STAKE-OUT OF ALL UTILITIES, AT LEAST 2 FULL
WORKING DAYS PRIOR TO ANY EXCAVATION.

#### REFERENCE:

1. 4775 1997-2003 RIDGE RD BURGER KING.DWG, SHEET NUMBER 1, LAST REVISED ON 12/13/2021, PREPARED BY FRANDINA ENGINEERING AND LAND SURVEYING, PC

Α		
В		
С		
D		
Е		
F		
G		
Н		
	Revisions:	Date
1	Minor Site Plan Revisions	01/06/2
2	Revised per Town Comments	02/18/2
3		

Issued:



CIVIL ENGINEER OF RECORD Name: Todd G. Markevicz New York License No.: 080577 Exp. Date. November 30, 2023 Firm Reg. No.: 0014815 Exp. Date: December 31, 2023

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A P D Engineering & Architecture PLLC
615 Fighers Run
Victor, NY 1454
85574.6914 [Inc.
www.upd.com

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DO NOT SCALE PLANS

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# Burger King

JSC MANAGEMENT GROUP ATTN: JAMES CAMMILLERI BURGER KING FRANCHISEE 585.755.3950

Store #: S.B.L. No. 143.06-1-11, 12, & 13 1997, 2003, & 2007 Ridge Road

West Seneca, NY 14224 Erie County (Town of West Seneca)

Project Name & Location:

Overall Site Plan

Drawing Name:

Project No. Date: 04/19/21 21-0239


Drawn By: SAS Drawing No.

SITE DATA:	
OCAL JURISDICTION:	TOWN OF WEST SENECA
ONING CLASSIFICATION	C-2 (S) - COMMERCIAL *REZONED AT 1/20/22 TOWN BOARD MEETING
ermitted uses:	SPECIAL USE PERMIT TO ALLOW OPERATION AS A EATING OR DRINKING ESTABLISHMENTS, PROVIDED THAT ANY ENTERTAINMENT SHALL BE LIMITED TO TELEVISION, RADIO OR RECORDED MUSIC, AND FURTHER PROVIDED THAT NO SALES OF ALCOHOLIC BEVERAGES FOR CONSUMPTION ON THE PREMISES SHALL BE PERMITTED ON ANY LOT WHERE A SIDE LOT ABUTS ANY R DISTRICT BOUNDARY.

MANAGEMENT GROUP, LLC (UNDER CONTRACT)

MARK A. LORENZ, SR. (CURRENT), GLR HOLDINGS, LLC (CURRENT) JSC

BULK REQUIREMENTS	REQUIRED	PROPOSED	VARIANCE
FRONT YARD	40 FT MINIMUM + 10 FEET	50 FT	NO
REAR YARD	10 FT; IF REAR YARD ABUTS R DISTRICT BOUNDARIES, THE REAR YARD SHALL BE 30 FT OR A DISTANCE EQUAL TO THE HEIGHT OF THE PRINCIPAL BUILDING, WHICHEVER IS GREATER.	± 235 FT	NO
SIDE YARD	5 FT. IF SIDE YARD ABUTS AN R DISTRICT ZONE, MINIMUM REQUIRED FOR SIDE YARDS FOR MULTIFAMILY DWELLING/MIXED OCCUPANCY IN THE ABUTTING R DISTRICT (5 FT FOR SINGLE FAMILY).	± 36 FT	NO
MINIMUM LOT AREA	900 SF	± 43,550 SQ FT	NO
MINIMUM LOT FRONTAGE	50 FT	± 147 FT	NO
MAXIMUM BUILDING COVERAGE	50% (43,550 SQ FT)	±6.3%	NO
MAXIMUM BUILDING HEIGHT	40 FT	24 FT	NO
INGRESS/EGRESS MINIMUM DRIVE WIDTH	A 30 FT DRIVE FOR INGRESS / EGRESS SHALL BE PROVIDED FOR ALL MULTIFAMILY AND SPECIAL DEVELOPMENTS OR 20 FT MIN. FOR SEPARATE INGRESS / EGRESS DRIVES.	24 FT & 24 FT	NO
PARKING REQUIREMENT	3 SPACES FOR EACH 5 SEATS (40 SEATS = 24 SPACES)	28 SPACES	NO
PARKING STALL WIDTH	9 FT MIN	9 FT	NO
PARKING STALL LENGTH	18 FT MIN	18 FT	NO
MINIMUM STACKING REQUIREMENTS	5 SPACES PER BOOTH / SERVICE WINDOW	9 SPACES	NO
OFF-STREET PARKING SETBACK (PAVEMENT)	NO OPEN OFF-STREET PARKING SPACE WITHIN 10 FT OF ANY STREET LINE OR ANY R DISTRICT BOUNDARY.	3' (N)	YES

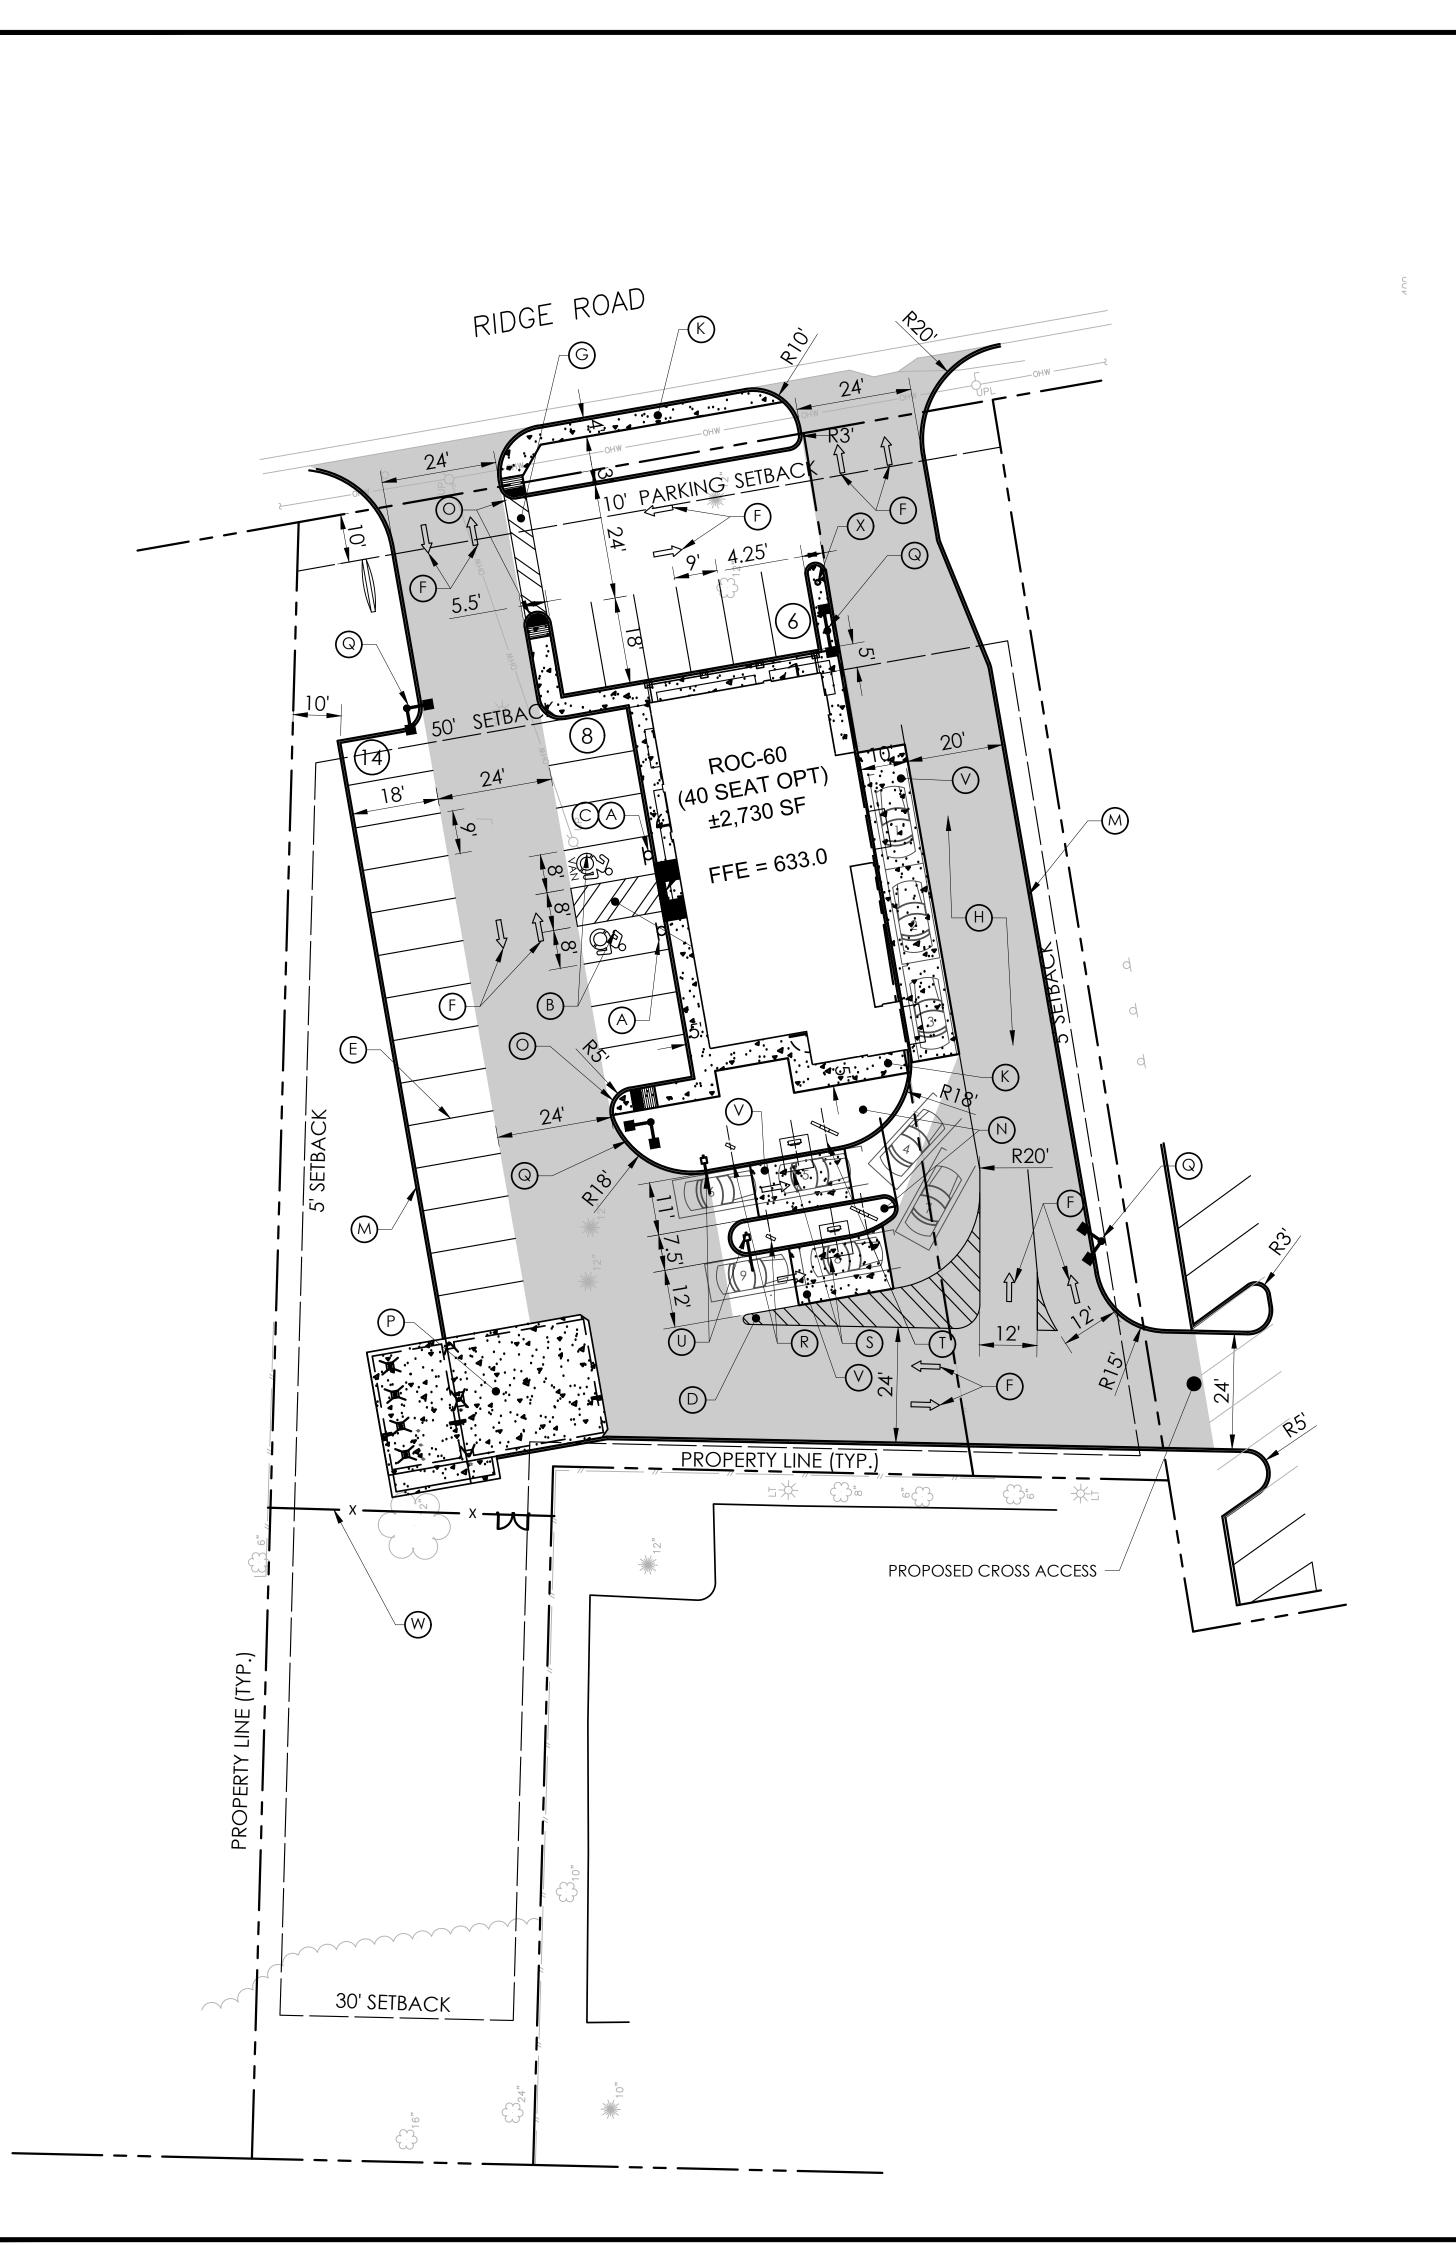

# SITE LEGEND:

- ACCESSIBLE PARKING SIGN, POST & BOLLARD (REFER TO DETAIL)
- B) PAINTED ACCESSIBLE PARKING SYMBOL (REFER TO DETAIL)
- (C) "VAN ACCESSIBLE" SIGN (REFER TO DETAIL)
- PAINTED PARKING ISLAND AREA TO BE STRIPED WITH 4" SYSL @ 2'-0" O.C. AND AT 45° TO PARKING SPACE.
- (E) SYSL/4" PARKING STALL STRIPING
- (F) PAVEMENT MARKINGS ARROWS (REFER TO DETAIL)
- (G) PEDESTRIAN CROSSWALK (REFER TO DETAIL)
- (H) HEAVY DUTY PAVEMENT (REFER TO DETAIL)
- (I) HEAVY DUTY CONCRETE (REFER TO DETAIL)
- (J) EDGE OF PAVEMENT
- (K) CONCRETE SIDEWALK (REFER TO DETAIL)
- TRANSFORMER PAD, INSTALL PER ELECTRIC COMPANY REQUIREMENTS. INCLUDE BOLLARDS AS NECESSARY.
- M CONCRETE CURB (REFER TO DETAIL)
- N LAWN/MULCH AREA (REFER TO PLANTING PLAN FOR DELINEATION)
- ADA RAMP AND DETECTABLE WARNING (REFER TO DETAIL)
- P DUMPSTER LOCATION (REFER TO ARCH. PLAN DETAIL)
- Q LIGHT POLE (REFER TO DETAIL)
- (R) OPTIONAL PREVIEW BOARD (REFER TO DETAIL)
- S ORDER CONFIRMATION UNIT (REFER TO DETAIL)
- (T) MENU BOARD (REFER TO DETAIL)
- (U) CLEARANCE BAR (REFER TO DETAIL)
- (V) CONCRETE PAD FOR DRIVE-THRU LANE (REFER TO DETAIL)
- (W) 6' BOARD ON BOARD FENCE WITH 6' GATE
- FLAG POLE EDER FLAG OF OAK CREEK, WI AND MODEL ECH35 (REFER TO BUILDING PLANS FOR ADDITIONAL DETAILS)

SITE DATA:	
LOCAL JURISDICTION:	TOWN OF WEST SENECA
ZONING CLASSIFICATION	: C-2 (\$) - COMMERCIAL *REZONED AT 1/20/22 TOWN BOARD MEETING
PERMITTED USES:	SPECIAL USE PERMIT TO ALLOW OPERATION AS A EATING OR DRINKING ESTABLISHMENTS, PROVIDED THAT ANY ENTERTAINMENT SHALL BE LIMITED TO TELEVISION, RADIO OR RECORDED MUSIC, AND FURTHER PROVIDED THAT NO SALES OF ALCOHOLIC BEVERAGES FOR CONSUMPTION ON THE PREMISES SHALL BE PERMITTED ON ANY LOT WHERE A SIDE LOT ABUTS ANY R DISTRICT BOUNDARY.
OWNER:	MARK A. LORENZ, SR. (CURRENT), GLR HOLDINGS, LLC (CURRENT) JSC MANAGEMENT GROUP, LLC (UNDER CONTRACT)
PROPERTY ACREAGE:	1.000+/- ACRES PER 8/12/2021 SURVEY

BULK REQUIREMENTS	REQUIRED	PROPOSED	VARIANCE
FRONT YARD	40 FT MINIMUM + 10 FEET	50 FT	NO
REAR YARD	10 FT; IF REAR YARD ABUTS R DISTRICT BOUNDARIES, THE REAR YARD SHALL BE 30 FT OR A DISTANCE EQUAL TO THE HEIGHT OF THE PRINCIPAL BUILDING, WHICHEVER IS GREATER.	± 235 FT	NO
SIDE YARD	5 FT. IF SIDE YARD ABUTS AN R DISTRICT ZONE, MINIMUM REQUIRED FOR SIDE YARDS FOR MULTIFAMILY DWELLING/MIXED OCCUPANCY IN THE ABUTTING R DISTRICT (5 FT FOR SINGLE FAMILY).	± 36 FT	NO
MINIMUM LOT AREA	900 SF	± 43,550 SQ FT	NO
MINIMUM LOT FRONTAGE	50 FT	± 147 FT	NO
MAXIMUM BUILDING COVERAGE	50% (43,550 SQ FI)	±6.3%	NO
MAXIMUM BUILDING HEIGHT	40 FT	24 FT	NO
INGRESS/EGRESS MINIMUM DRIVE WIDTH	A 30 FT DRIVE FOR INGRESS / EGRESS SHALL BE PROVIDED FOR ALL MULTIFAMILY AND SPECIAL DEVELOPMENTS OR 20 FT MIN. FOR SEPARATE INGRESS / EGRESS DRIVES.	24 FT & 24 FT	NO
PARKING REQUIREMENT	3 SPACES FOR EACH 5 SEATS (40 SEATS = 24 SPACES)	28 SPACES	NO
PARKING STALL WIDTH	9 FT MIN	9 FT	NO
PARKING STALL LENGTH	18 FT MIN	18 FT	NO
MINIMUM STACKING REQUIREMENTS	5 SPACES PER BOOTH / SERVICE WINDOW	9 SPACES	NO
OFF-STREET PARKING SETBACK (PAVEMENT)	NO OPEN OFF-STREET PARKING SPACE WITHIN 10 FT OF ANY STREET LINE OR ANY R DISTRICT BOUNDARY.	3' {N}	YES



AS REQUIRED BY NEW YORK STATE LAW, CONTRACTOR SHALL CONTACT "DIG SAFELY NEW YORK" (UFPO) @ 1-800-962-7962 FOR LOCATION STAKE-OUT OF ALL UTILITIES, AT LEAST 2 FULL WORKING DAYS PRIOR TO ANY EXCAVATION.

#### REFERENCE:

 4775 1997-2003 RIDGE RD BURGER KING.DWG, SHEET NUMBER 1, LAST REVISED ON 12/13/2021, PREPARED BY FRANDINA ENGINEERING AND LAND SURVEYING, PC

#### LEGEND OF IMPROVEMENTS

FACE OF CURB

FACE OF CURB

SUBJECT PARCEL PROPERTY LINE

SETBACK LINE

PROPOSED BUILDING

TRANSFORMER PAD

CONCRETE SIDEWALK/PAD

(REFER TO DETAILS)

HEAVY DUTY PAVEMENT (REFER TO DETAIL)

PEDESTRIAN CROSSWALK (REFER TO DETAIL)

LIGHT POLES

SITE SIGN, PAINTED STOP BAR & "STOP" LETTERING

В		
С		
D		
Е		
F		
G		
Н		
	Revisions:	Date:
1	Revised per Town Comments	02/18/22
2		
3		
4		
4 5		

Issued:



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385,627,727

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Burger King

Burger King Store #:

Erie County (Town of West Seneca)

S.B.L. No. 143.06-1-11, 12, & 13 1997, 2003, & 2007 Ridge Road

1777, 2000, & 2007 Mage

West Seneca, NY 14224

Project Name & Location:

Site Plan


Drawing Name:

Date: 04/19/21 21-0239
Type:

Drawn By: SAS

1"=20' Drawing No.

Project No.

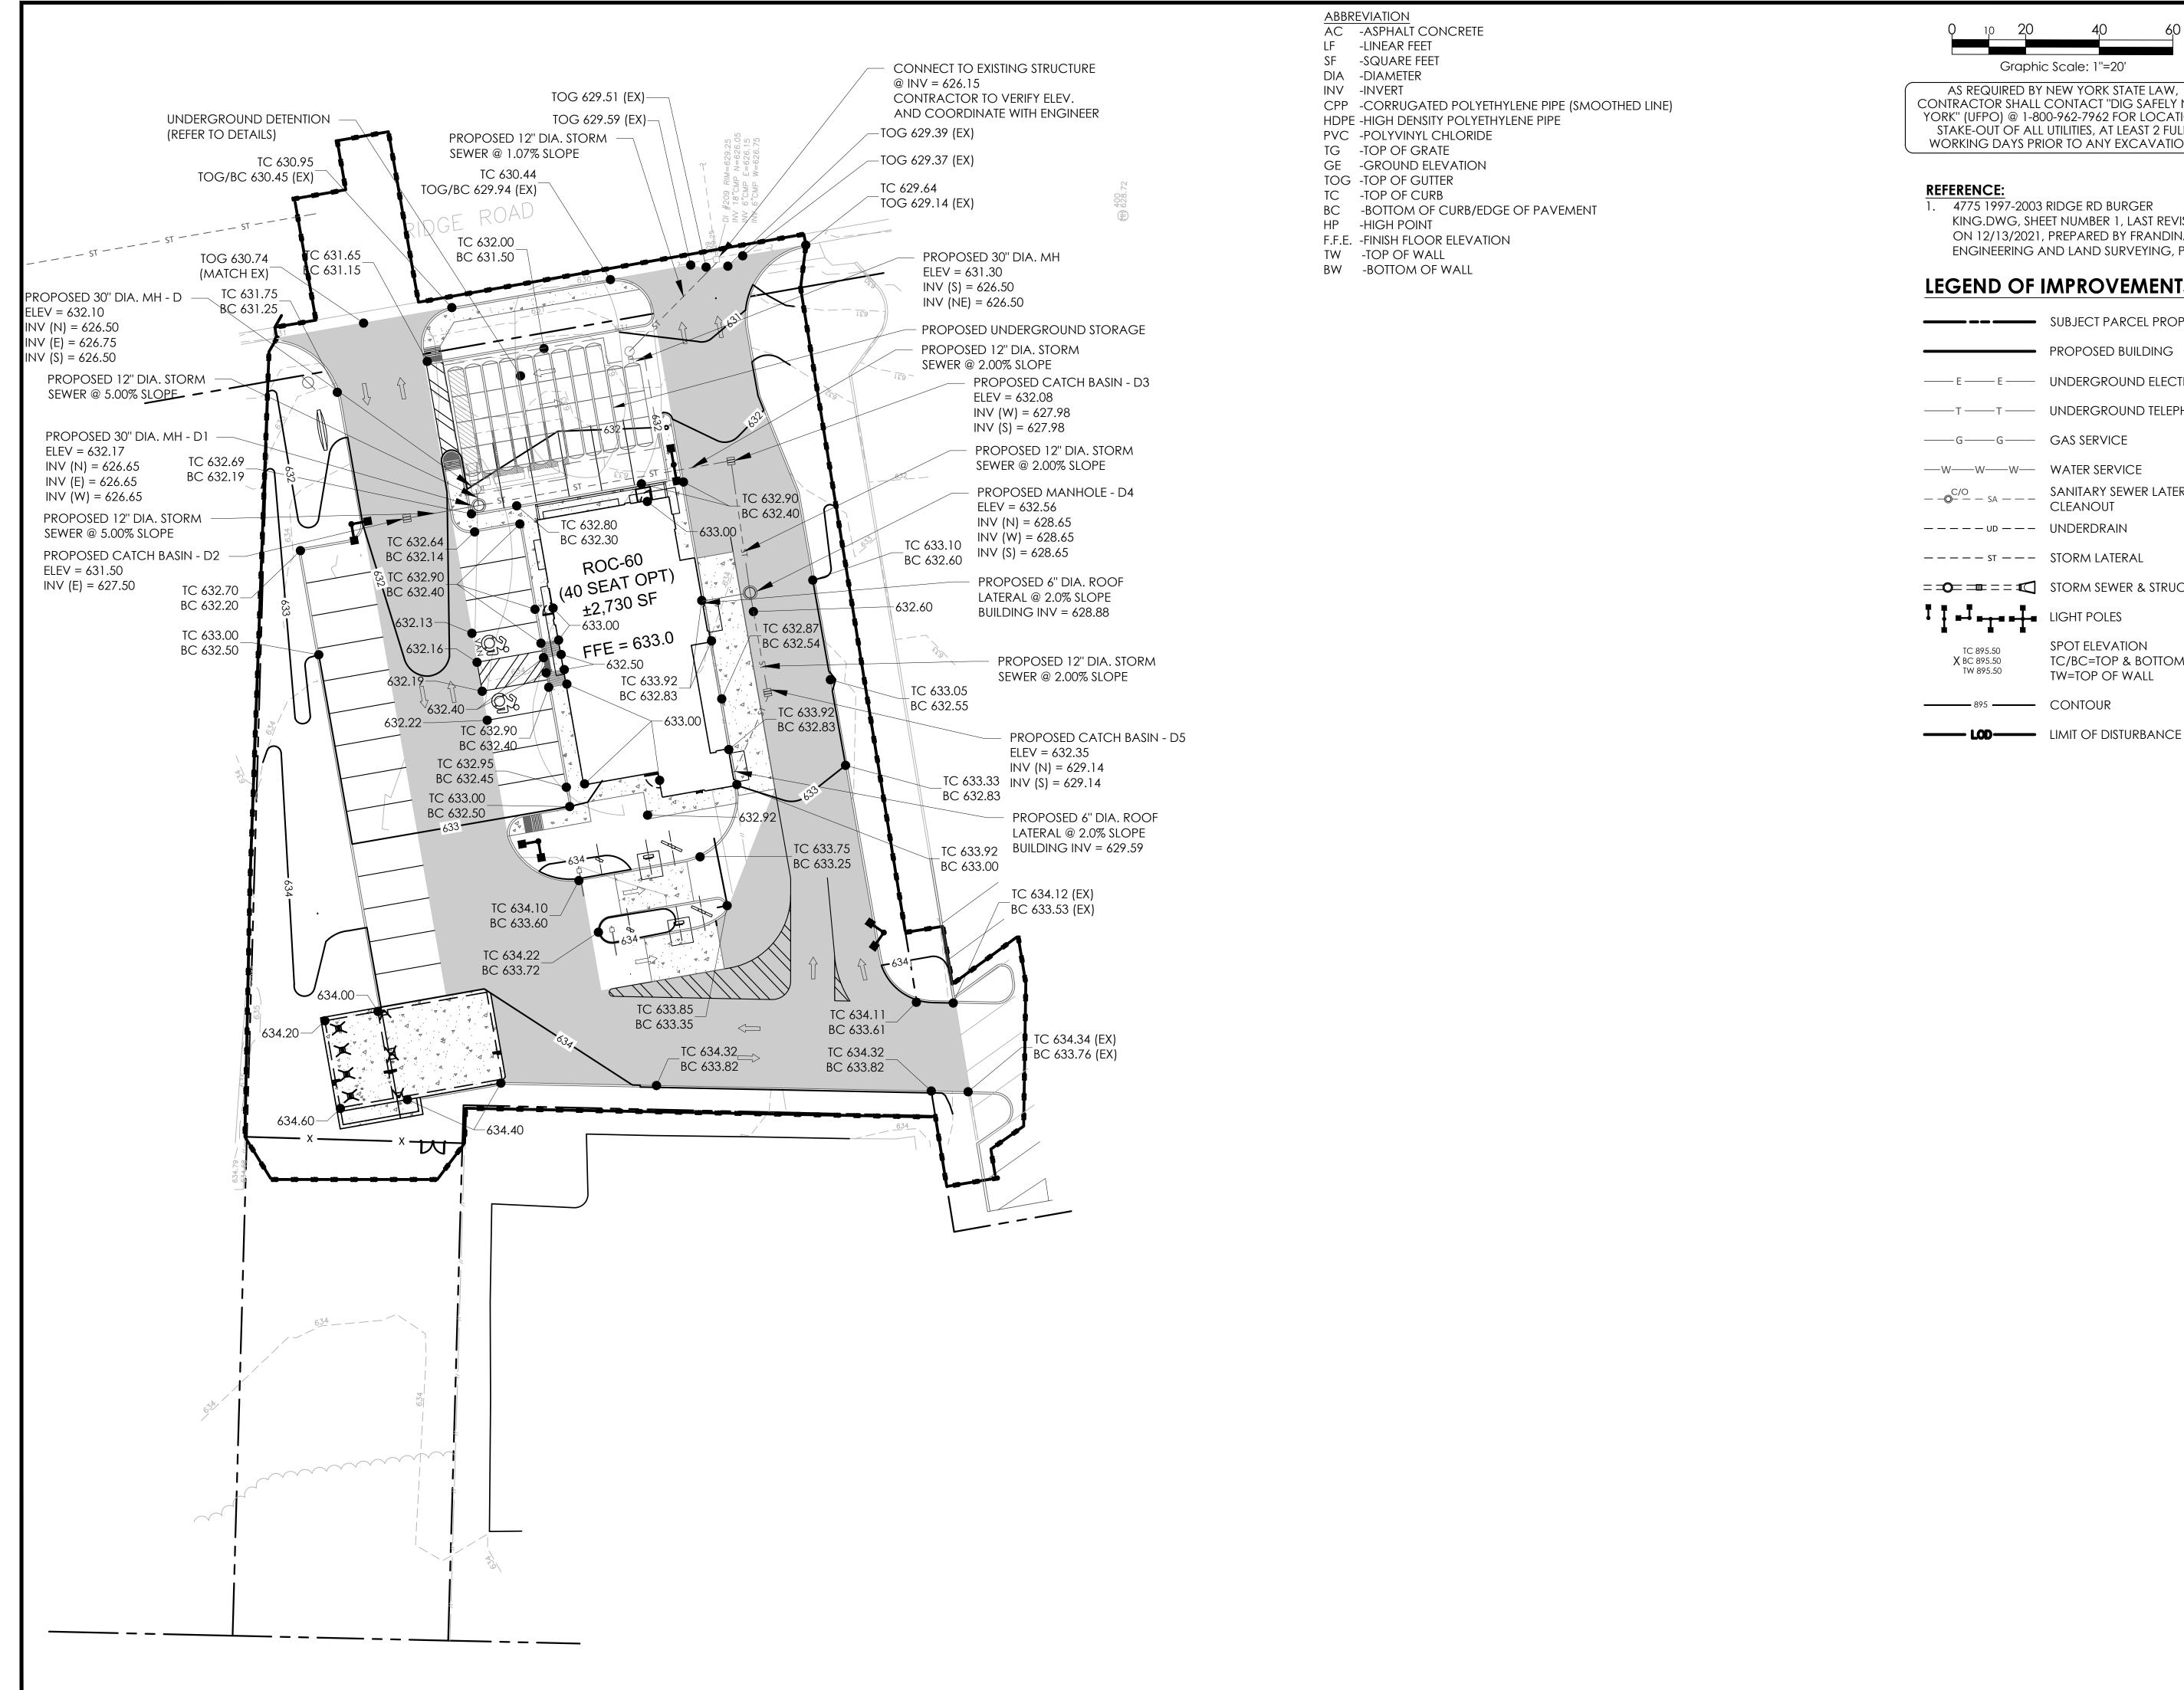




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## LEGEND OF IMPROVEMENTS

	SUBJECT PARCEL PROPERTY LINE
	PROPOSED BUILDING
—— E —— E ——	UNDERGROUND ELECTRIC
—т—т—	UNDERGROUND TELEPHONE
———G———G——	GAS SERVICE
	WATER SERVICE
— — C/O — SA — — —	SANITARY SEWER LATERAL & CLEANOUT
	UNDERDRAIN
st	STORM LATERAL
=	STORM SEWER & STRUCTURES
<sup>┇</sup> ┇╍┸╍┰╍┰╸	LIGHT POLES
TC 895.50 X BC 895.50 TW 895.50	SPOT ELEVATION TC/BC=TOP & BOTTOM OF CURB TW=TOP OF WALL



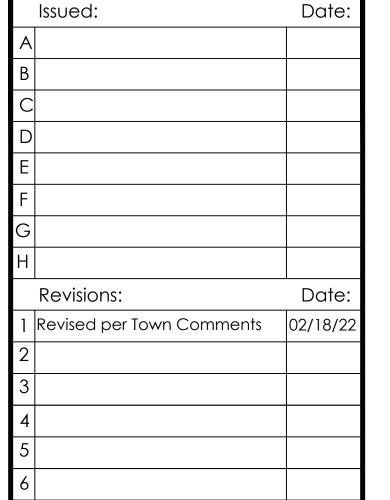

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**Burger King** 

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Store #: Burger King S.B.L. No. 143.06-1-11, 12, & 13

1997, 2003, & 2007 Ridge Road

West Seneca, NY 14224


Erie County (Town of West Seneca)


Project Name & Location:

Grading & Drainage Plan Drawing Name:

Project No. Date: 04/19/21 21-0239 Type:


Drawn By: SAS 1''=20' Drawing No.

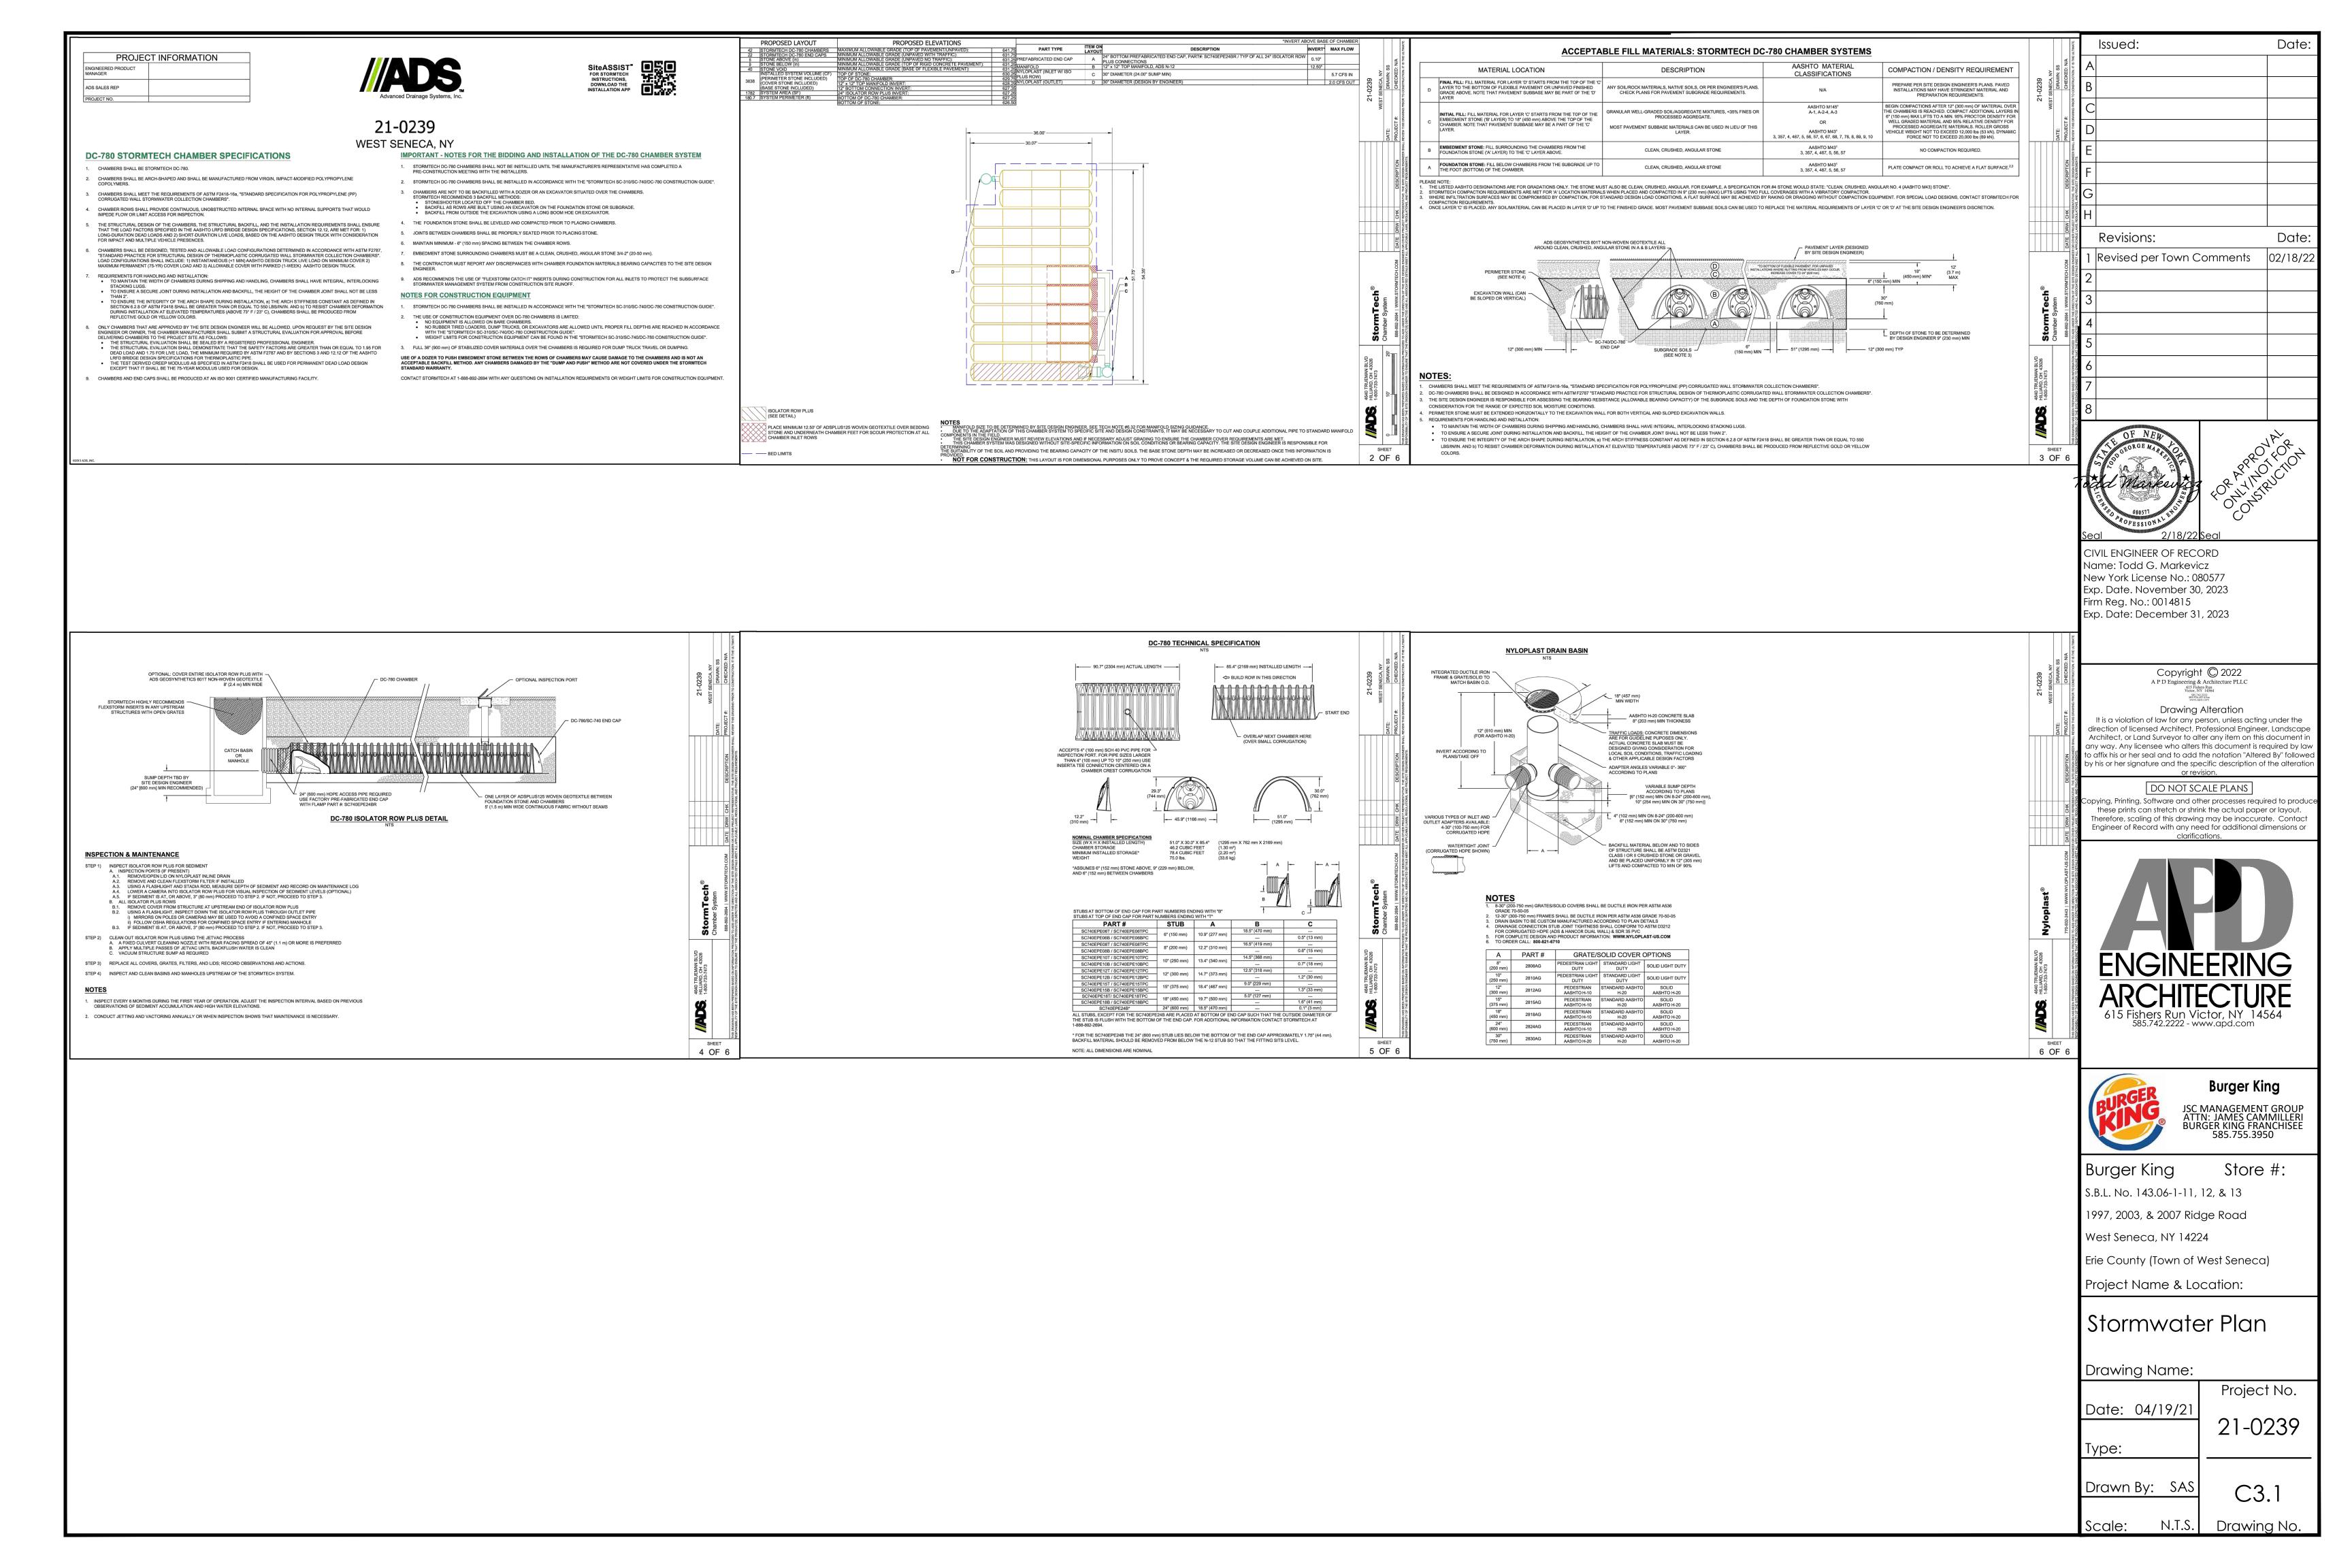

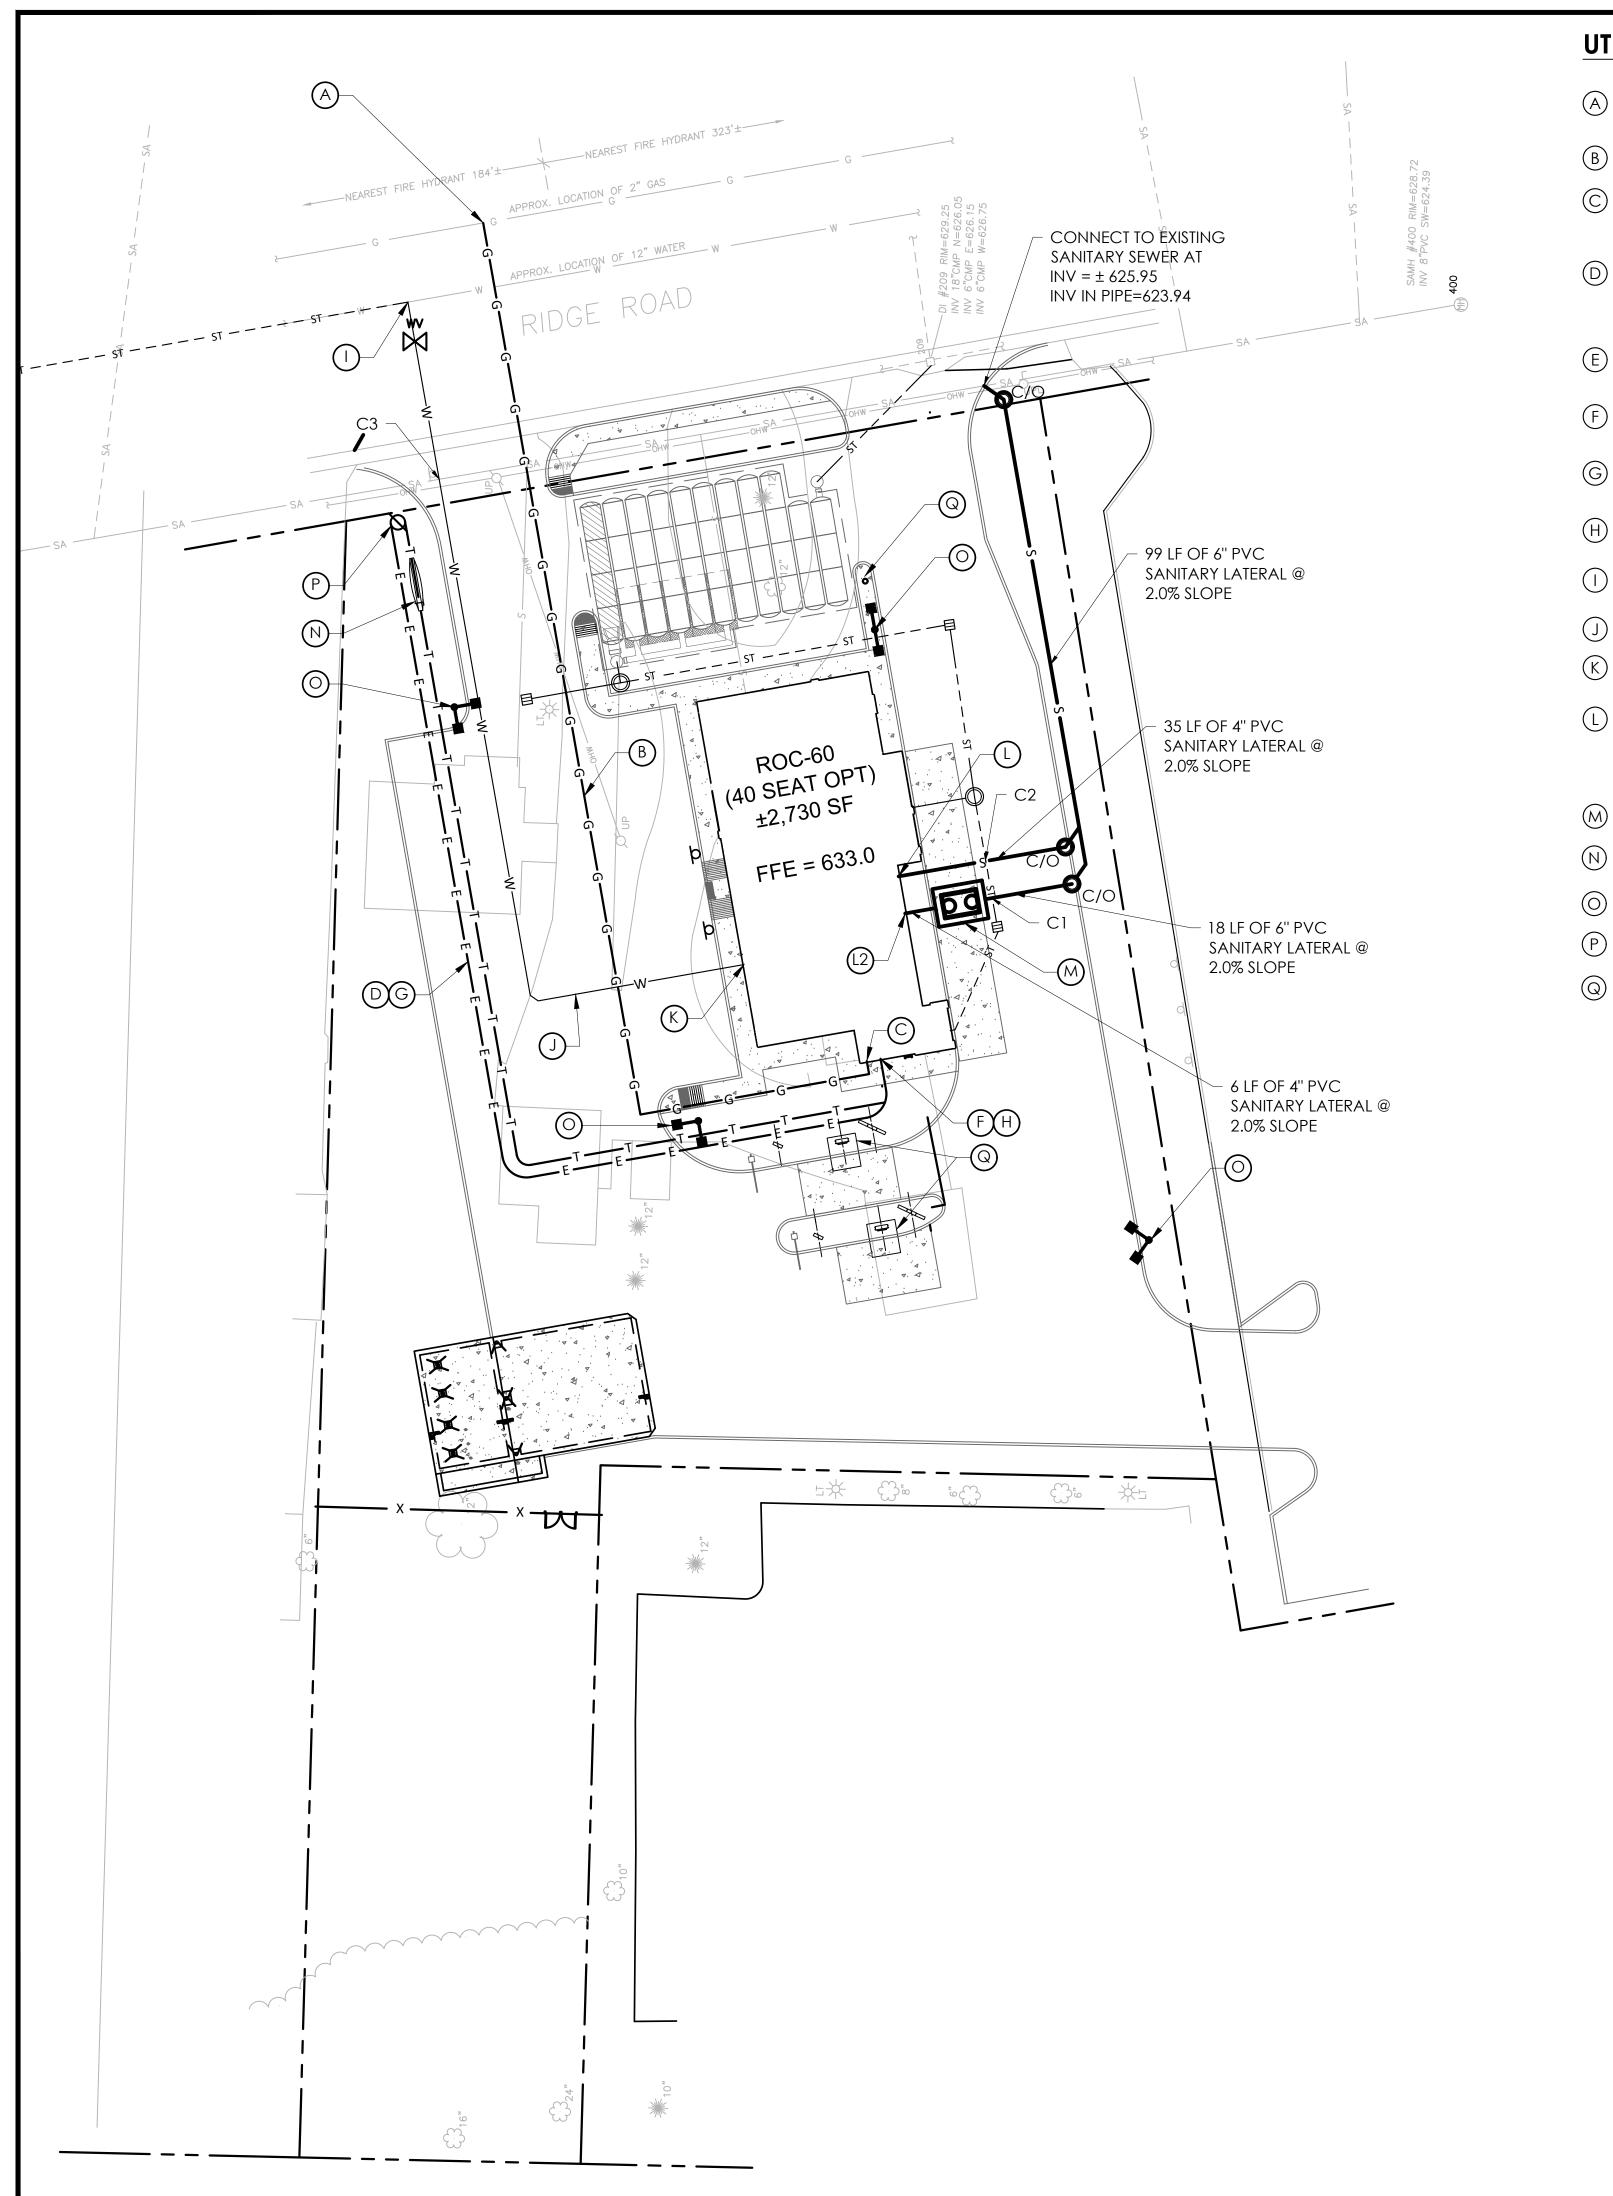

# **UTILITY LEGEND:**

- CONNECTION TO EXISTING GAS MAIN. CONTRACTOR TO (A) COORDINATE WITH GAS COMPANY FOR INSTALLATION AND FINAL CONNECTION
- (B) 2" UNDERGROUND GAS SERVICE
- (C) GAS METER AND SERVICE ENTRY
- UNDERGROUND ELECTRIC SERVICE. CONTRACTOR SHALL COORDINATE WITH ELECTRIC COMPANY FOR FINAL CONNECTION AND INSTALL CONDUIT AND REQUIRED PULL BOXES PER THEIR
- PAD-MOUNTED ELECTRIC TRANSFORMER. CONTRACTOR SHALL (E) COORDINATE EXACT LOCATION, SIZE, INSTALLATION, AND PROTECTION OF TRANSFORMER WITH ELECTRIC COMPANY.
- (F) ELECTRIC METER AND SERVICE ENTRY.
- UNDERGROUND TELEPHONE LINE. CONTRACTOR SHALL (G) COORDINATE WITH TELEPHONE COMPANY AND INSTALL CONDUIT AND REQUIRED PULL BOXES PER THEIR REQUIREMENTS
- (H) TELEPHONE SERVICE ENTRY
- SLEEVE AND VALVE CONNECT TO EXISTING 12" CAST IRON WATER MAIN WITH TAPPING
- (J) 2" TYPE K DOMESTIC WATER SERVICE
- (K) DOMESTIC WATER SERVICE ENTRY
- 4" SANITARY SERVICE ENTRY @ INV = 628.50 WITH CLEAN-OUT, REFER TO BUILDING PLANS
  - 4" SANITARY SERVICE ENTRY @ INV = 628.83 WITH CLEAN-OUT, REFER TO BUILDING PLANS
- M 1200 GALLON GREASE INTERCEPTOR (REFER TO DETAIL) INV. IN = 628.71, INV. OUT = 628.50
- (N) PROVIDE ELECTRIC TO ILLUMINATED SIGN
- (i) LIGHT POLE (REFER TO SITE PLAN)
- (P) PROPOSED UTILITY POLE, COORDINATE WITH ELECTRIC COMPANY
- SEE BUILDING ELECTRICAL PLAN FOR CONDUIT ROUTING AND WIRING TO FLAG POLE, DRIVE-THRU EQUIPMENT, ETC.

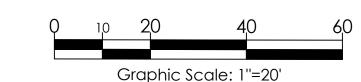



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#### REFERENCE:


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# LEGEND OF IMPROVEMENTS



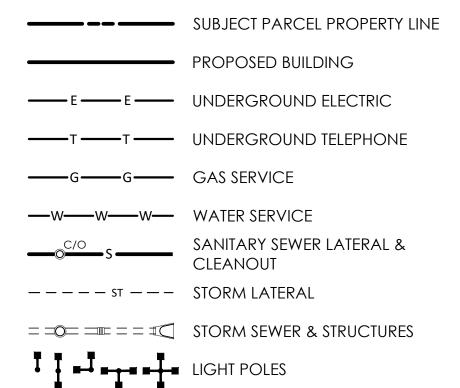

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**Burger King** 
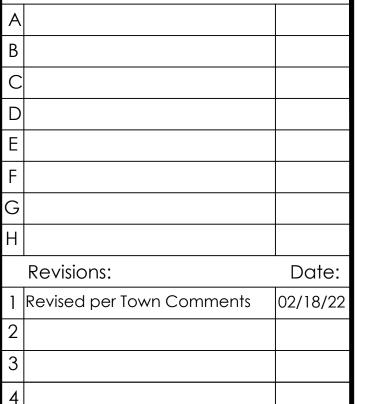
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Burger King Store #:

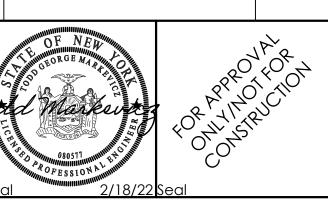S.B.L. No. 143.06-1-11, 12, & 13 1997, 2003, & 2007 Ridge Road

West Seneca, NY 14224

Erie County (Town of West Seneca)


Project Name & Location:


Utility Plan

Drawing Name: Project No. Date: 04/19/21 21-0239 Type:

Drawn By: SAS

Drawing No. 1''=20'

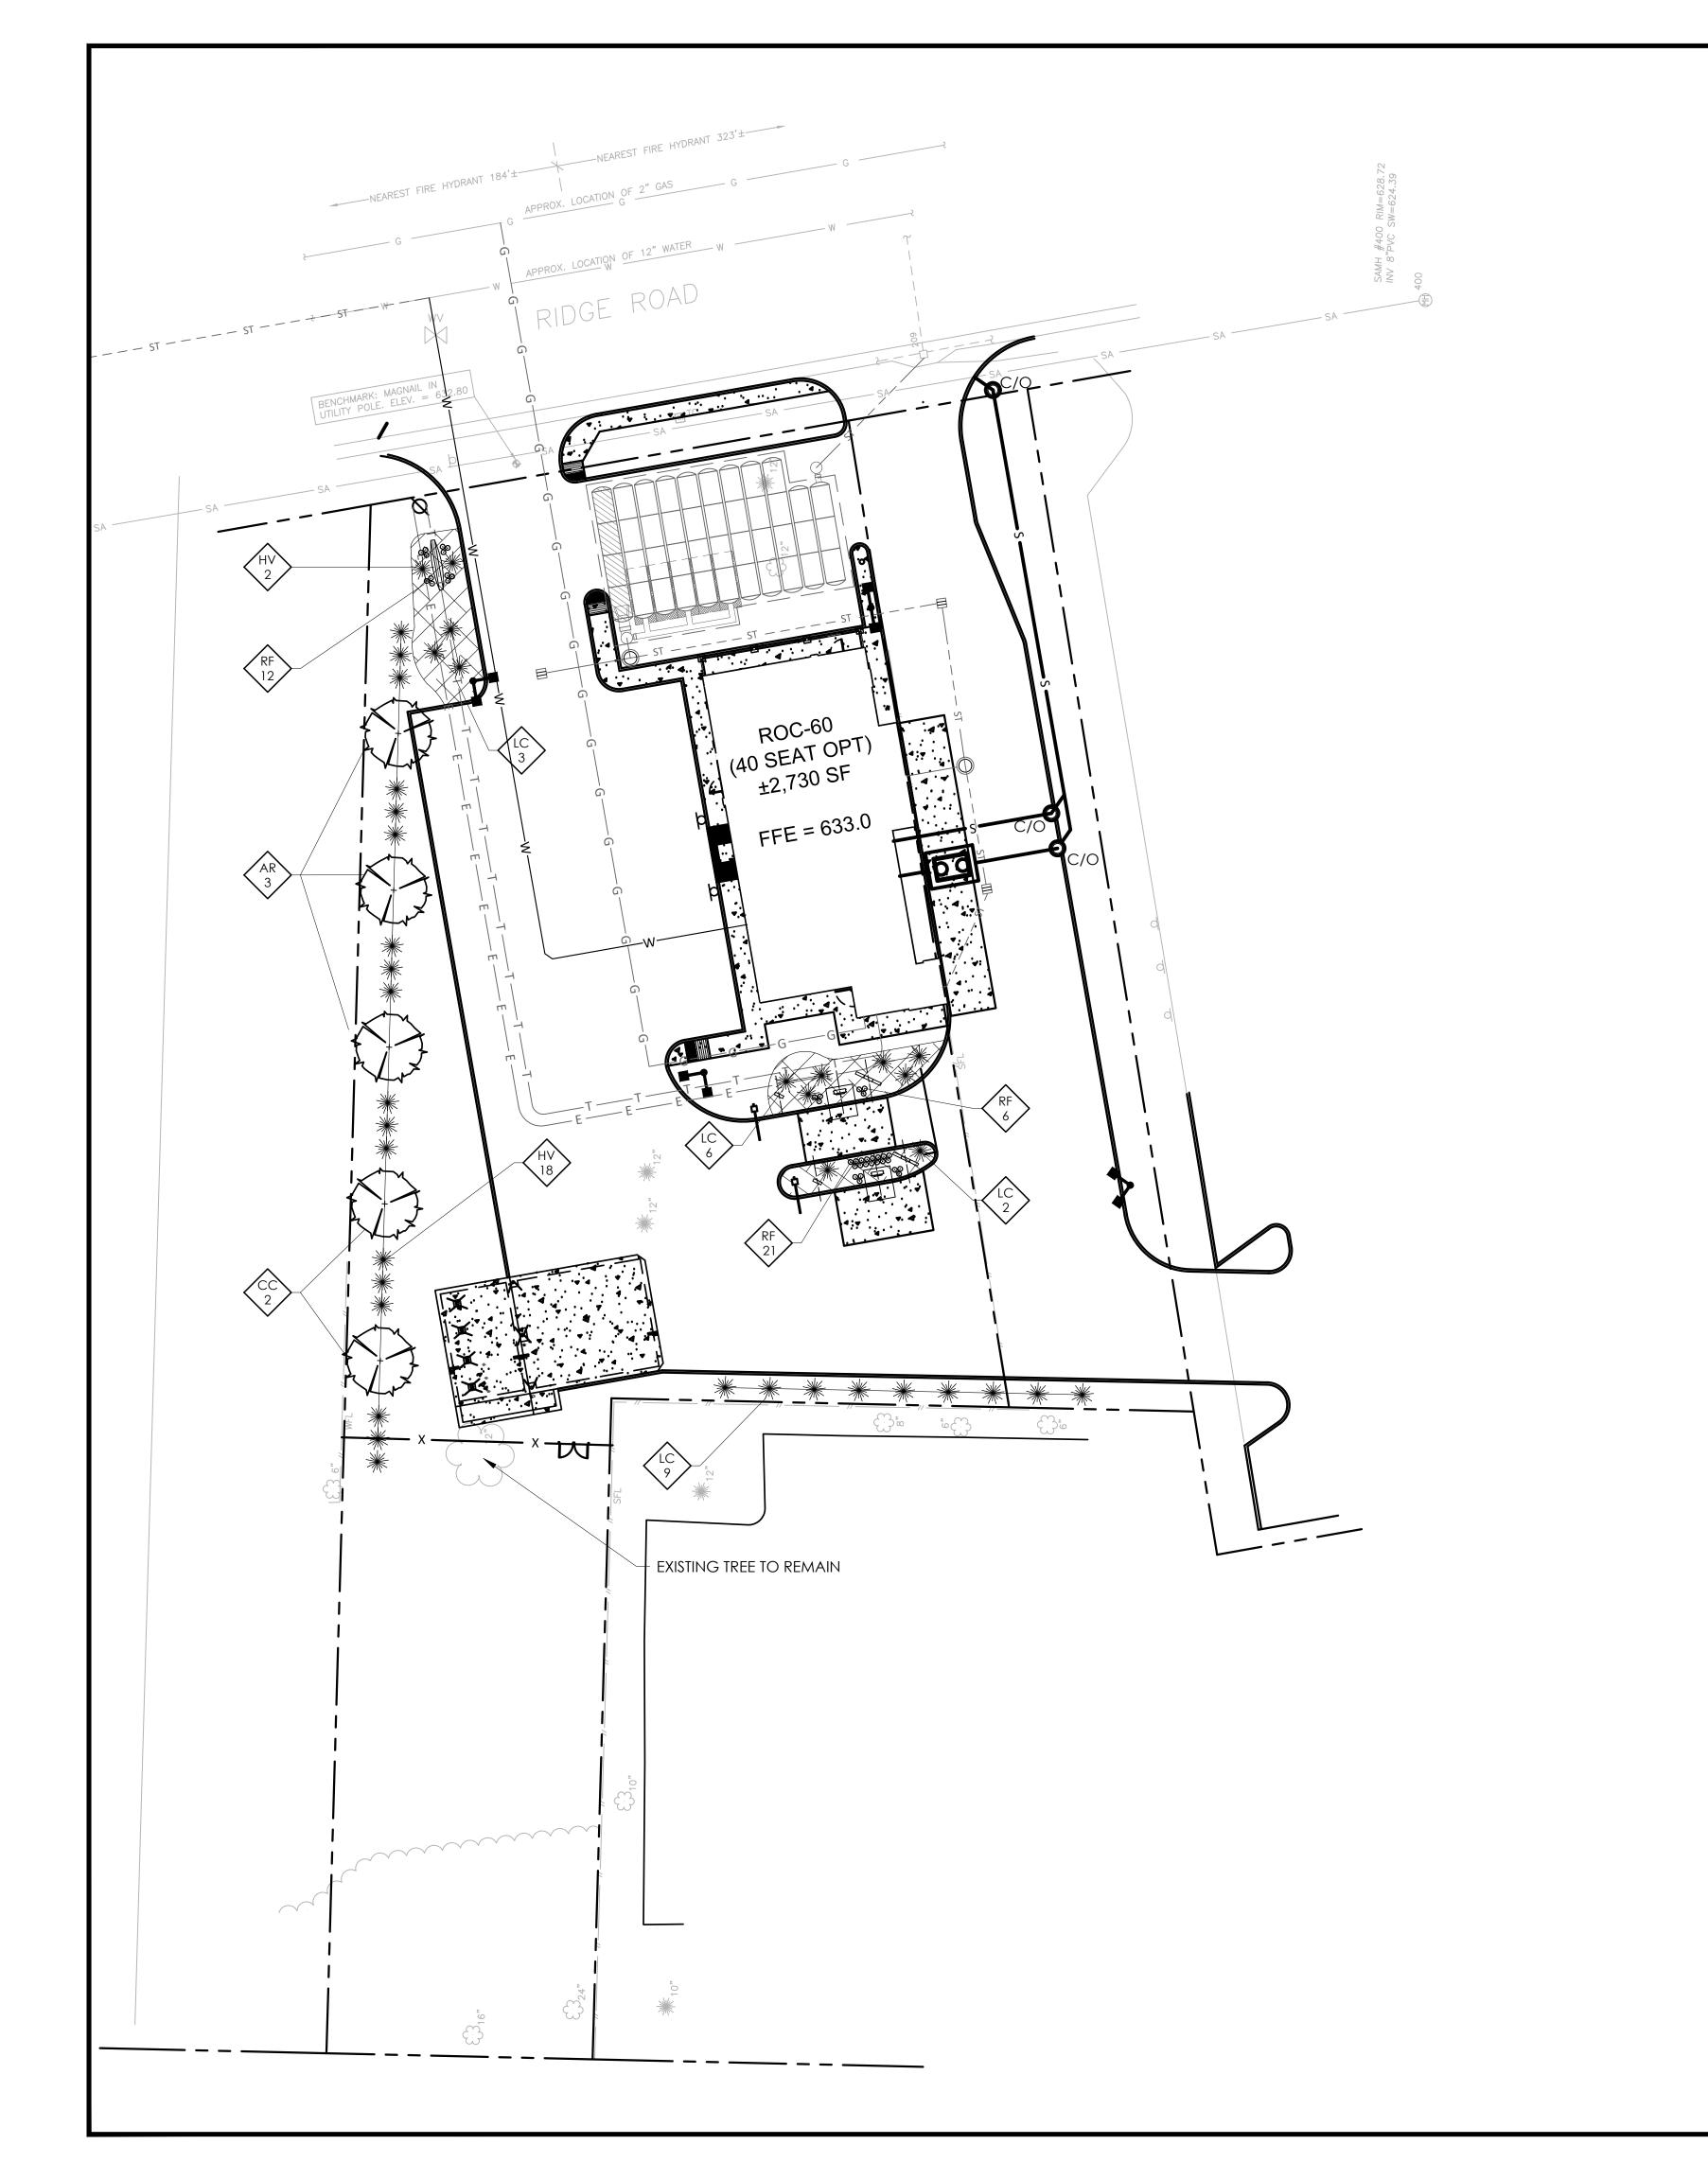

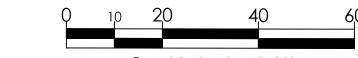

Graphic Scale: 1"=20'

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### LEGEND OF IMPROVEMENTS

SUBJECT PARCEL PROPERTY LINE

PROPOSED BUILDING

UNDERGROUND ELECTRIC

T T UNDERGROUND TELEPHONE

GGGGGGAS SERVICE

WATER SERVICE

WATER SERVICE

SANITARY SEWER LATERAL & CLEANOUT

STORM LATERAL

STORM SEWER & STRUCTURES


LIGHT POLES

SHRUBS/BUSHES

DECIDUOUS TREE

Α		
В		
С		
D		
Е		
F		
G		
Н		
	Revisions:	Date:
1	Revised per Town Comments	02/18/22
2		
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4		

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**Burger King** 
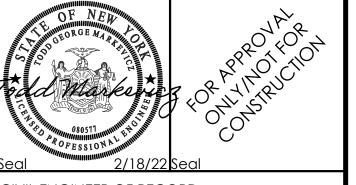
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S.B.L. No. 143.06-1-11, 12, & 13

1997, 2003, & 2007 Ridge Road

West Seneca, NY 14224

Erie County (Town of West Seneca)

Project Name & Location:

Planting and Lighting Plan Drawing Name:

Project No.


Date: 04/19/21

21-0239

Type:

Drawn By: SAS C5
Scale: 1"=20' Drawing No.

PLANT LIST						
QUANT.	KEY	LATIN NAME	COMMON NAME	CAL.	ROOTS	HT. OR. SP
20	HV	HAMAMELIS VIRGINIANA	COMMON WITCH HAZEL		#5 CONT.	18" SP, 5' O.C.
20	LC	LOBELIA CARDINALIS (ZONES 4, 5, 6)	CARDINAL FLOWER		#2 CONT.	6' SP, 24" O.C.
2	СС	CARPINUS CAROLINIANA	AMERICAN HORNBEAM	2.5"	B&B	20' HT, 20' O.C.
3	AR	ACER RUBRUM	RED MAPLE	2.5"	B&B	15' HT, 10' O.C.
39	RF	RUDBECKIA FULGIDA 'GOLDSTURM'	BLACK EYED SUSAN		#2 CONT.	24" O.C.

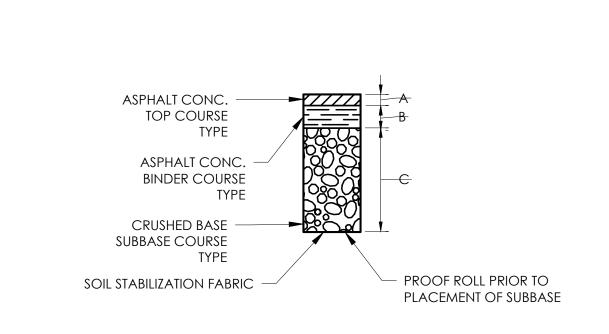


		REGULAR DUTY	HEAVY DUTY
	Α	TBD	TBD
Γ	В	TBD	TBD
	С	TBD	TBD

NOTES:


1. PAVEMENT SECTIONS ARE PROVIDED BASED ON THE GEOTECHNICAL ENGINEERING REPORT PROVIDED BY PENDING.


# **PAVING SECTION DETAIL** N.T.S

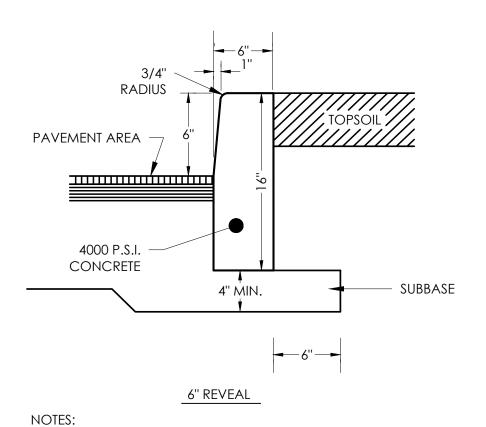


1. CONTROL JOINTS 10 FEET ON CENTER TO DEPTH OF  $\frac{1}{3}$  THE CURB 2. EXPANSION JOINTS WITH PREMOLDED FILLER 50 FEET ON CENTER

# CONCRETE CURB DETAIL N.T.S

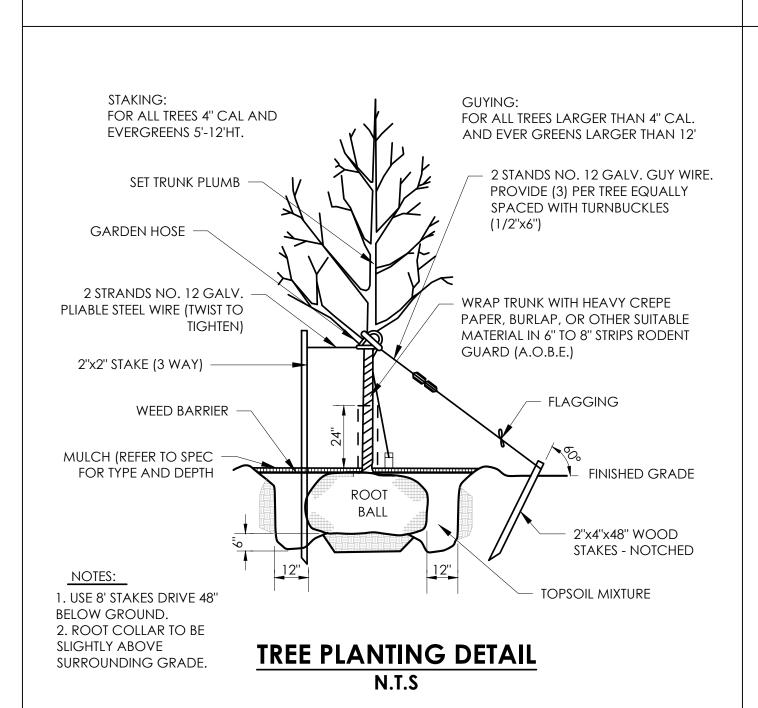

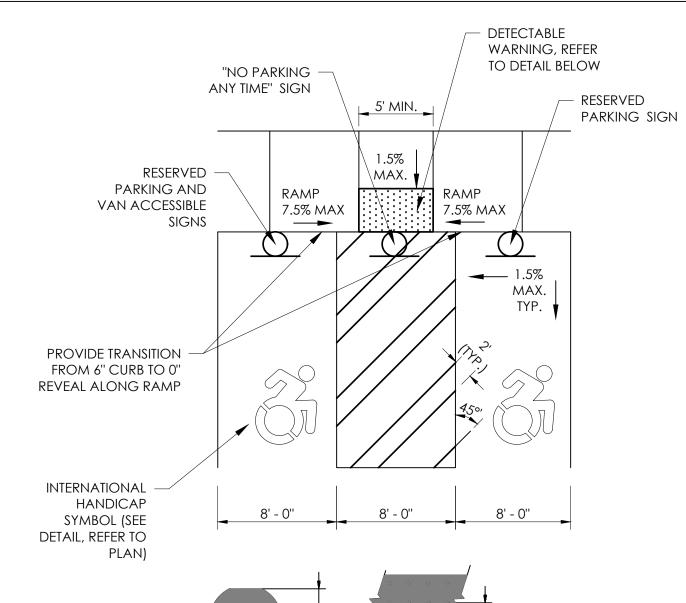

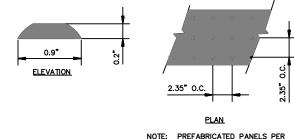

- REFER TO SITE PLAN FOR ACCESSIBLE PARKING STRIPING LAYOUT. ALL SIDEWALK, RAMPS, LANDING AREAS, DETECTABLE WARNING, ETC. ALONG THE ACCESSIBLE PATH SHALL BE CONSTRUCTED IN ACCORDANCE WITH ADA STANDARDS.
- 3. CONTRACTOR TO REFER TO THE GRADING AND DRAINAGE PLAN FOR SLOPES.
- CROSS SLOPES FOR SIDEWALKS AND RAMPS SHALL BE 1.5% AT A MAXIMUM
- RUNNING SLOPES FOR SIDEWALKS SHALL BE 4.5% AT A MAXIMUM RUNNING SLOPES FOR RAMPS SHALL BE AT 7.5% MAXIMUM SLOPES FOR ADA PARKING STALLS AND UNLOADING BAYS SHALL BE 1.5% AT A MAXIMUM
- SIGNS TO BE PLACED IN CENTER OF PARKING STALL OR UNLOADING BAY (IF APPLICABLE) WHENEVER POSSIBLE. SHIFT "NO PARKING ANYTIME" SIGN SLIGHTLY OFF CENTER TO MAINTAIN THE MINIMUM OF 32" CLEAR SPACE REQUIRED IN ACCORDANCE WITH ADA REQUIREMENTS

# **ACCESSIBLE PARKING DETAIL**



MULCH (REFER TO SPEC FOR TYPE AND

UNDISTURBED SUBSOIL

SHRUB PLANTING DETAIL

N.T.S

ROPE FROM TOP  $\frac{1}{3}$  OF BALL


BACKFILL MIX (REFER TO SPEC)

ACCESSIBLE PARKING STRIPING DETAIL (NYS)


- BLUE PAINT

WHITE PAINT


(TYP.)

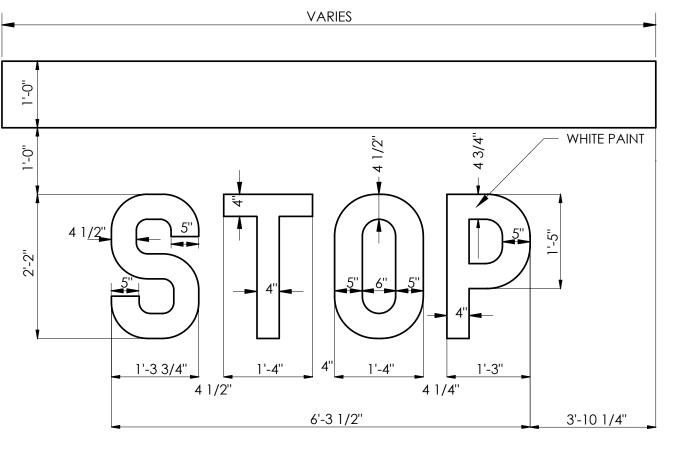


OTES:
CONTRACTOR SHALL REVIEW ALL
FEDERAL, STATE, AND LOCAL CODE
AND PROVIDE SIGNAGE IN
ACCORDANCE WITH ALL ADA
REQUIREMENTS. THIS DETAIL IS
PROVIDED FOR GENERAL
GUIDANCE ONLY.
ANY REQUIRED "FINE" SIGNS SHALL
BE PROVIDED ON POST AS
REQUIRED BY ANY STATE AND/OR
LOCAL REGULATIONS. **PARKING** RESERVED PARKING SIGN MOUNTED FACING PARKING SPACE OR NO PARKING ANYTIME SIGN MOUNTED FACING LOADING ZONE - VAN ACCESSIBLE SIGN, MOUNTED FACING PARKING SPACE (WHERE APPLICABLE) ACCESSIBLE PIPE BOLLARD -USE 6" SCHEDULE 40 STEEL PIPE WITH TOP ROUNDED FILLED W/ CONCRETE AND PAINTED TRAFFIC YELLOW **SLOPE TOP OF** CONCRETE GROUND/PAVING SURFACE 4000 P.S.I. P.C. CONCRETE #6 - 14" LONG REBAR EACH WAY THROUGH **ACCESSIBLE SIGN POST INSTALLATION DETAIL** 

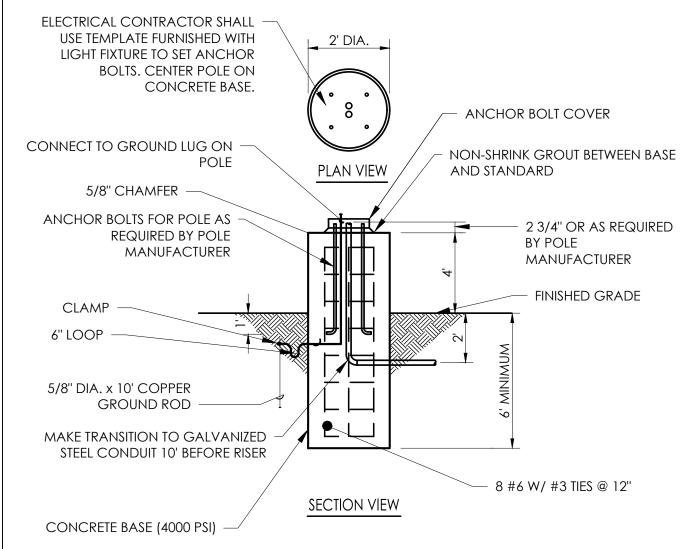

LIGHTING STANDARD DETAIL N.T.S.

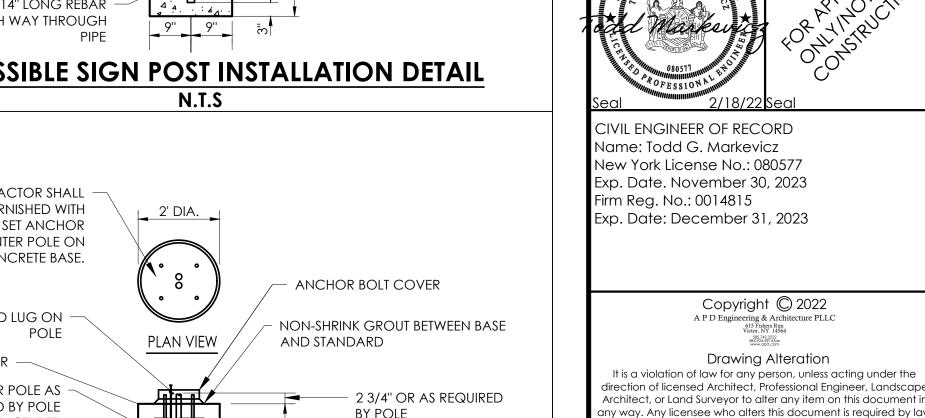

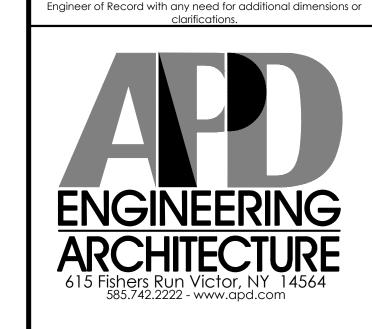

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Burger King Store #:

S.B.L. No. 143.06-1-11, 12, & 13

1997, 2003, & 2007 Ridge Road

West Seneca, NY 14224

Erie County (Town of West Seneca)

Project Name & Location:

# Details Sheet

Drawing Name: Project No. Date: 04/19/21 21-0239


Type: Drawn By: SAS

Drawing No.

N.T.S.

IF SHRUB IS B&B, THEN REMOVE BURLAP &

PARKING LOT DRIVE AISLE **STOP BAR DETAIL** 

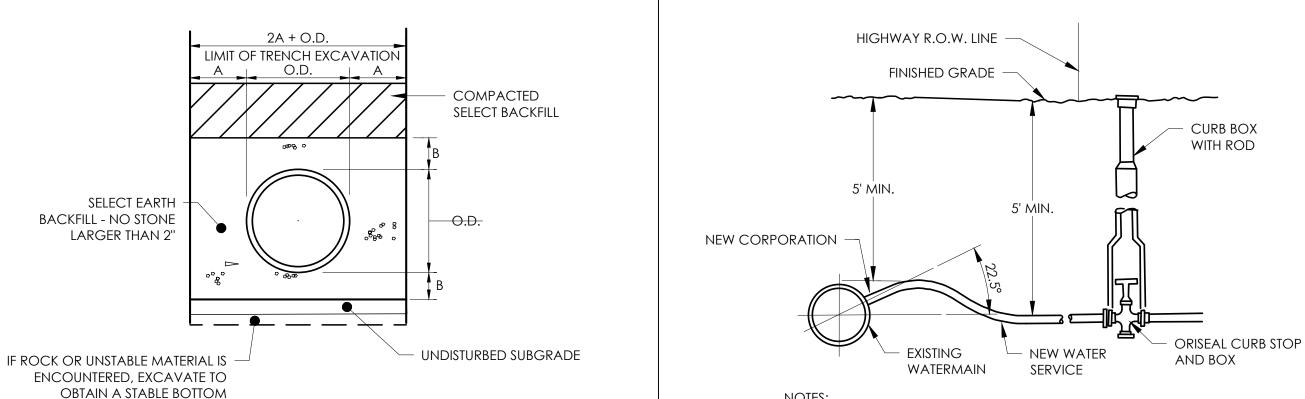

COMPACTED SELECT

FILTER FABRIC, REFER

TO SPECIFICATIONS

OVERLAP FABRIC ON TOP

BENTONITE CLAY OR

200 PSI FLOWABLE

FILL SHALL BE 2 FEET

THICK

BACKFILL

UNDISTURBED SUBGRADE

IF ROCK OR UNSTABLE MATERIAL IS ENCOUNTERED,

EXCAVATE TO OBTAIN A STABLE BOTTOM

MIN. DIMENSIONS FOR PIPE BEDDING (INCHES) (INCHES) (INCHES) UP TO 18 21 TO 36 9 OVER 36

> WATER TRENCH DETAIL N.T.S.

> > LIMIT OF TRENCH EXCAVATION

PERFORATED STORM ENCASEMENT

2. IF CLEAN STONE BEDDING IS USED THE BEDDING SHALL BE ENCIRCLED WITH FILTER FABRIC TO PREVENT SOILS FROM ENTERING THE VOIDS OF THE

[REVIEW/UPDATE ON PROJECT SPECIFIC BASIS] ANTI-SEEPAGE COLLARS SHALL BE PROVIDED AT PROJECT LIMIT/PROPERTY LINE AND EVERY 1 FOOT ELEVATION DIFFERENCE ALONG SANITARY PIPE AND AT LEAST TWO ALONG STORM OUTLET PIPES THAT ARE PLACED IN DIKES OR BASIN RETAINMENT AREAS.

UNIFORM MIX OF

100% PASSING 2" SIEVE

0-10% PASSING 1/4" SIEVE

0-1% PASSING 200 SIEVE

# 1. TYPE K VIRGIN COPPER-ASTM SPEC. B88 (LATEST REVISION) OR

- PE 3408 SDR-9-ASTM D2737 -200 PSI WITH #10 SOLID COPPPER TRACING WIRE. 2. NEW WATER SERVICE LATERAL TO BE A SIZE AND TYPE AS APPROVED BY THE
- LOCAL WATER SUPPLIER. 3. TRACING WIRE TO BE WRAPPED AROUND CURB STOP AND CORPORATION FOR
- POLYETHLENE SERVICE ONLY. 4. ALL WATER TAPS SHALL BE COORDINATED WITH OR PERFORMED BY THE LOCAL WATER AUTHORITY.

# WATER SERVICE INSTALLATION DETAIL N.T.S.

ANTI-SEEPAGE COLLAR

UNDISTURBED SUBGRADE


IF ROCK OR UNSTABLE MATERIAL IS ENCOUNTERED,

EXCAVATE TO OBTAIN A STABLE BOTTOM

OPTIONAL STORM AND SANITARY ENCASEMENT

<u> VHEN USING CLEAN STÔNE</u>


MUST BE PLACED WHEN HOLE

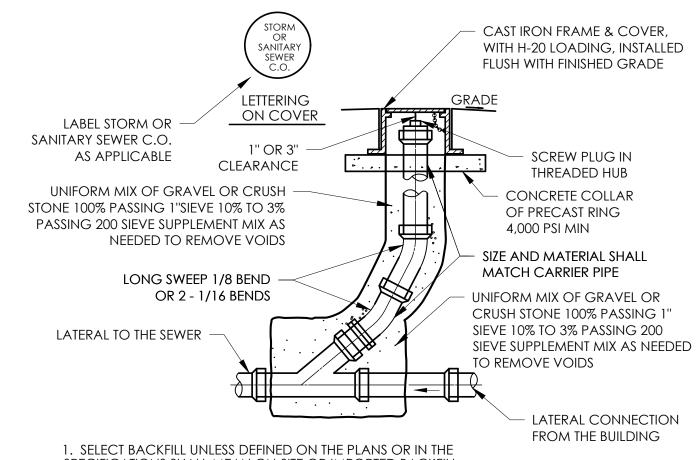

SPECIFICATIONS SHALL MEAN ON-SITE OR IMPORTED BACKFILL MEETING THE REQUIRED SPECIFICATIONS, ASTM 2321 WITH THE ADDED REQUIREMENT OF NO MATERIAL HAVING A DIMENSION EXCEEDING 4 INCHES.


- 2. IF CLEAN STONE BEDDING IS USED THE BEDDING SHALL BE ENCIRCLED WITH FILTER FABRIC TO PREVENT SOILS FROM ENTERING THE VOIDS OF THE STONE.
- 3. THIS DETAIL APPLIES TO BOTH SANITARY AND STORM.
- 4. CLEANOUTS SHALL BE SPACED NO MORE THAN 90' APART.

# **SEWER CLEANOUT DETAIL**

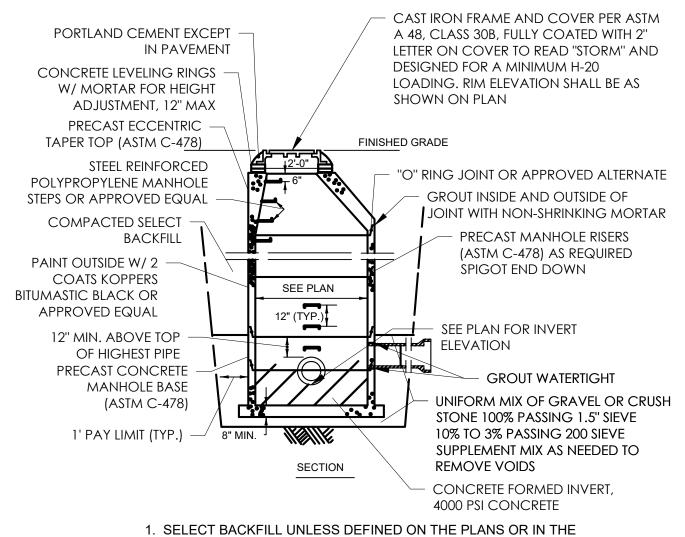

SPECIFICATIONS SHALLMEAN ON-SITE OR IMPORTED BACKFILL MEETING THE REQUIRED SPECIFICATIONS, ASTM 2321 FOR WELL GRADED MATERIALWITH THE ADDED REQUIREMENT OF NO MATERIAL HAVING A DIMENSION EXCEEDING 3 INCHES.


# STORM MANHOLE DETAIL

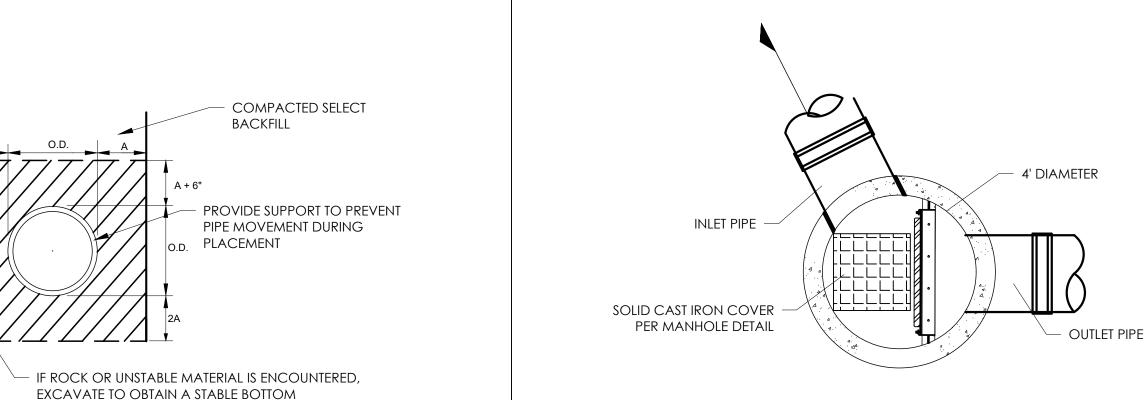

## GENERAL NOTES


- ) STORMGATE BY CONTECH STORMWATER SOLUTIONS; PORTLAND, OR (800) 548-4667; SCARBOROUGH, ME (877) 907-8676; LINTHICUM, MD (866) 740-3318.
- PRECAST MANHOLE TO BE CONSTRUCTED IN ACCORDANCE WITH ASTM C478. DETAIL DRAWING REFLECTS DESIGN INTENT ONLY. ACTUAL DIMENSIONS AND CONFIGURATION OF STRUCTURE WILL BE SHOWN ON PRODUCTION SHOP DRAWING.
- ) STRUCTURE AND ACCESS COVERS TO MEET AASHTO H-20 LOAD RATING
- 4) INLET AND OUTLET PIPING TO BE SPECIFIED BY ENGINEER AND PROVIDED BY CONTRACTOR. PRECAST STORMGATE MANHOLE EQUIPPED WITH EITHER CORED OPENINGS OR KNOCKOUTS AT INLET AND OUTLET LOCATIONS.
- ) CONTRACTOR TO ADJUST WEIR TO DESIGN ELEVATION SPECIFIED IN DATA TABLE BELOW. DO NOT EXCEED 5.0 FT-LBS TORQUE WHEN TIGHTENING SCREWS ON WEIR FRAME. SEAL WEIR TO FRAME WITH RTV SILICONE SEALANT AFTER FINAL ADJUSTMENT.

# **OUTLET STRUCTURE - PLAN VIEW**

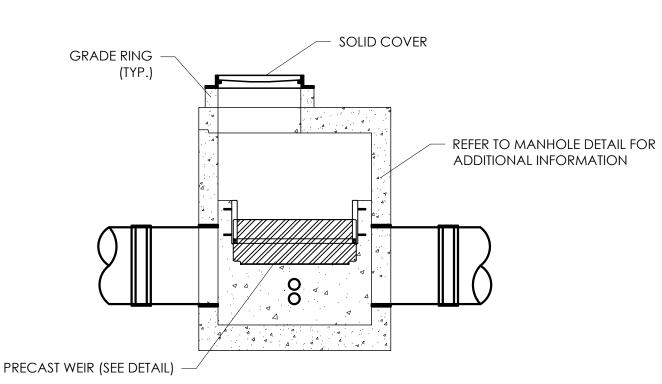


# **OUTLET STRUCTURE - SECTION VIEW**

	OUTLET STRUCTURE	
TOP OF RIM ELEVATION	631.30	
LOW FLOW ORIFICE (SIZE/INVERT)	3" / 626.50	
HIGH FLOW ORIFICE (SIZE/INVERT)	5" / 627.50	
INLET PIPE (SIZE/INVERT)	12" / 626.50	
OUTLET PIPE (SIZE/INVERT)	12" / 626.50	
WEIR INVERT	628.75	

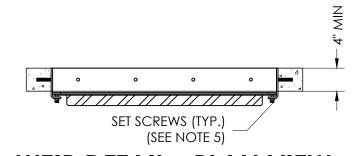

# **WEIR DETAIL - PLAN VIEW**

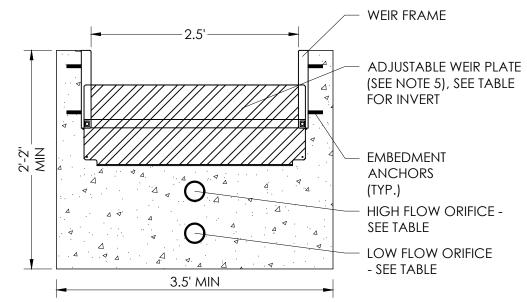

**WEIR DETAIL - SECTION VIEW** 

# **OUTLET STRUCTURE DETAIL**

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Issued:

Date

CIVIL ENGINEER OF RECORD Name: Todd G. Markevicz New York License No.: 080577 Exp. Date. November 30, 2023 Firm Reg. No.: 0014815 Exp. Date: December 31, 2023

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DO NOT SCALE PLANS |

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Burger King Store #:

S.B.L. No. 143.06-1-11, 12, & 13

1997, 2003, & 2007 Ridge Road

West Seneca, NY 14224

Erie County (Town of West Seneca)


Project Name & Location:

# Details Sheet


Drawing Name: Project No. Date: 04/19/21 21-0239 Type:


Drawn By: SAS

Drawing No.

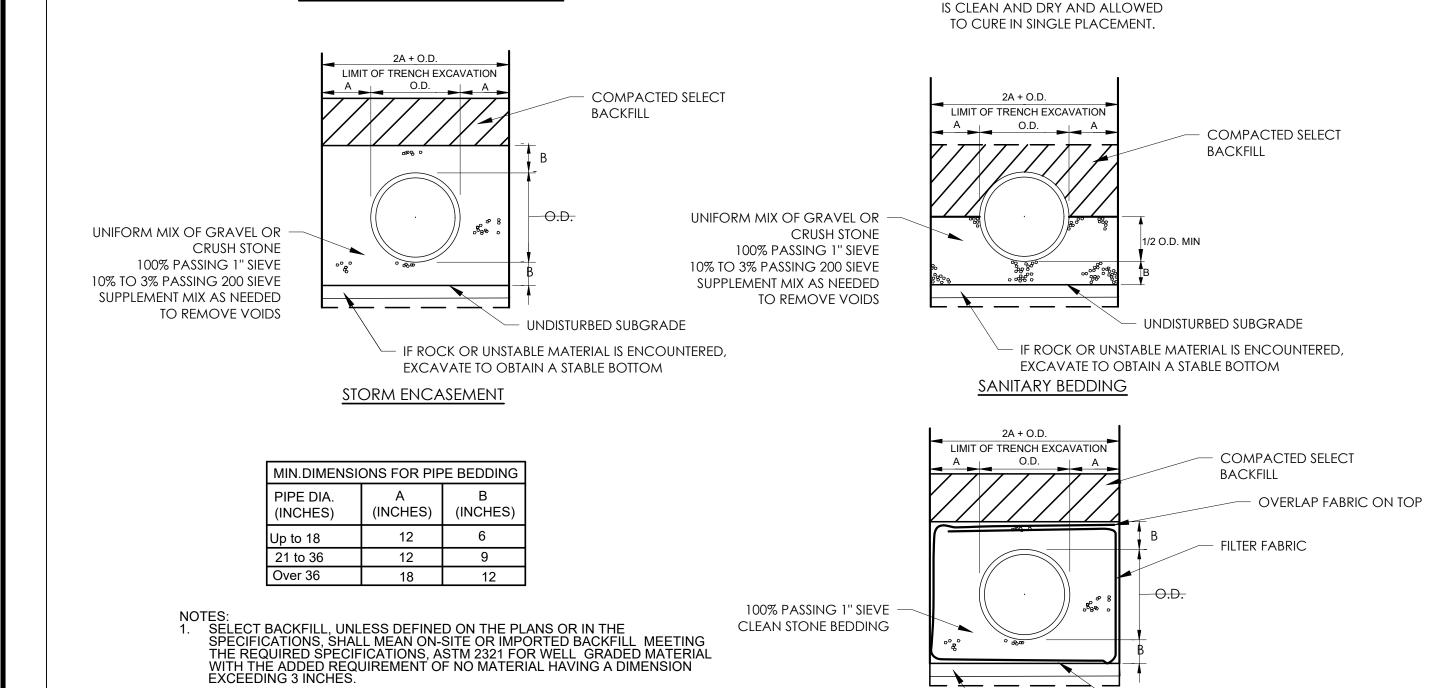

PIPE BEDDING DETAILS

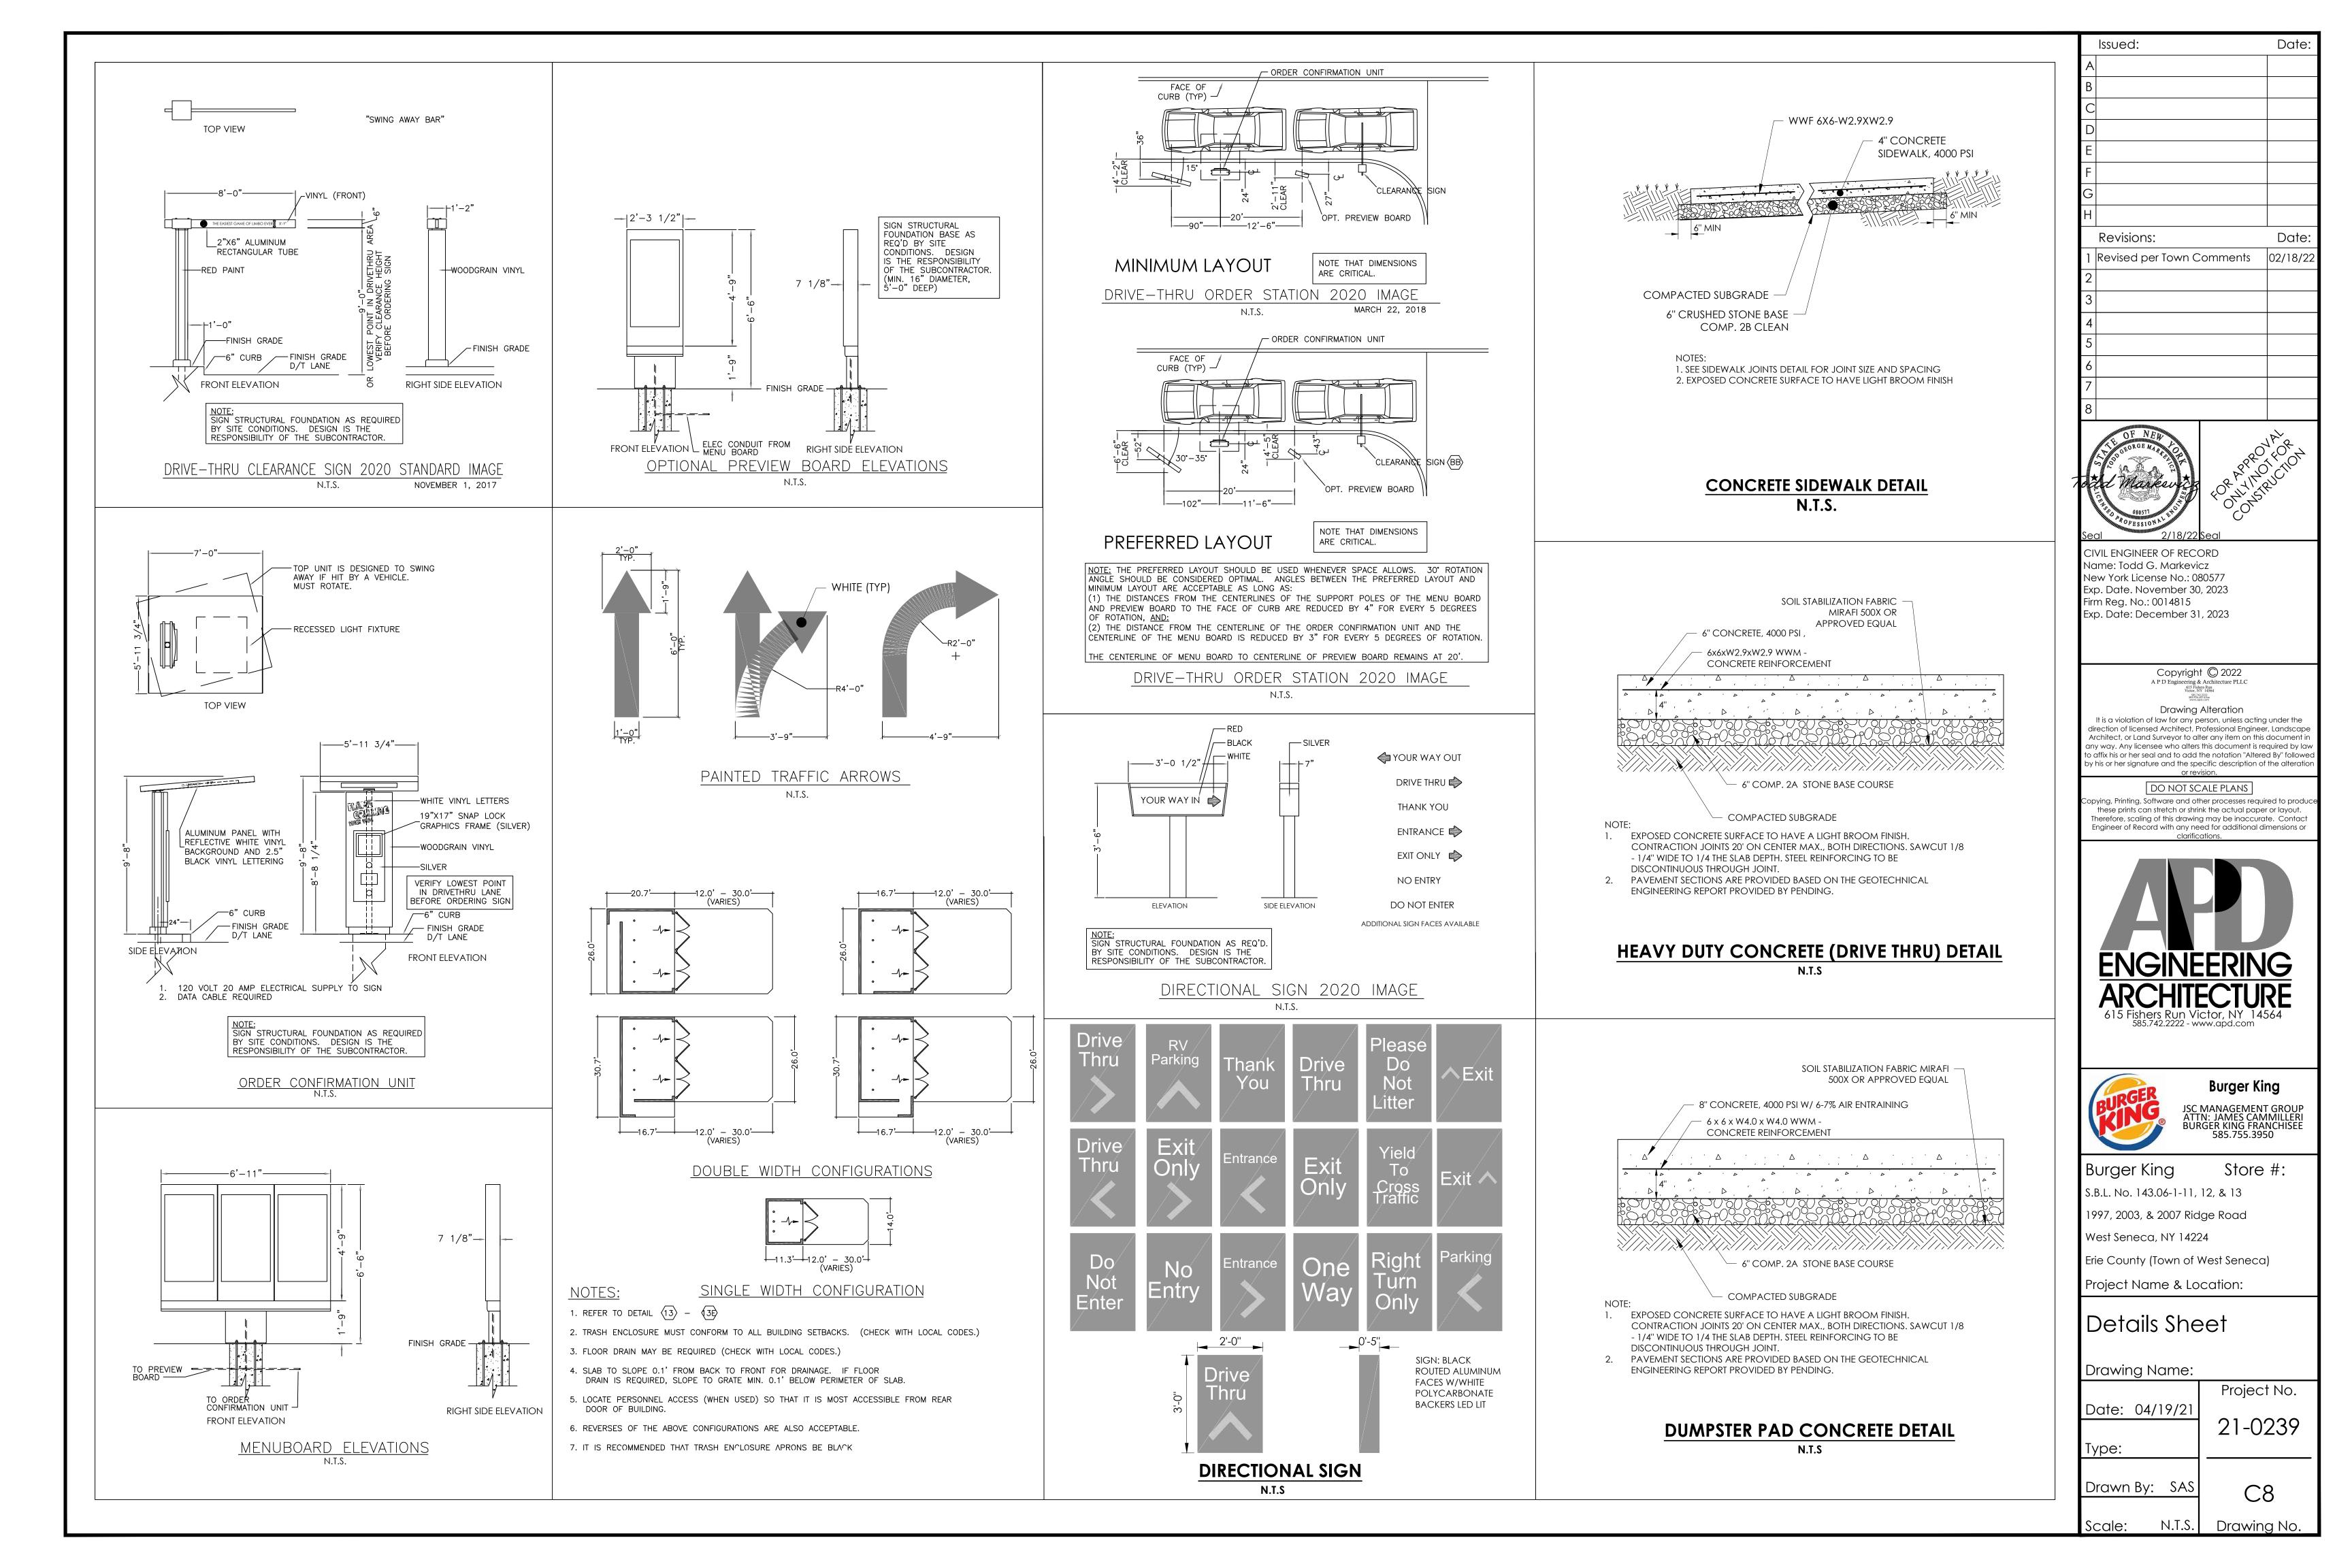

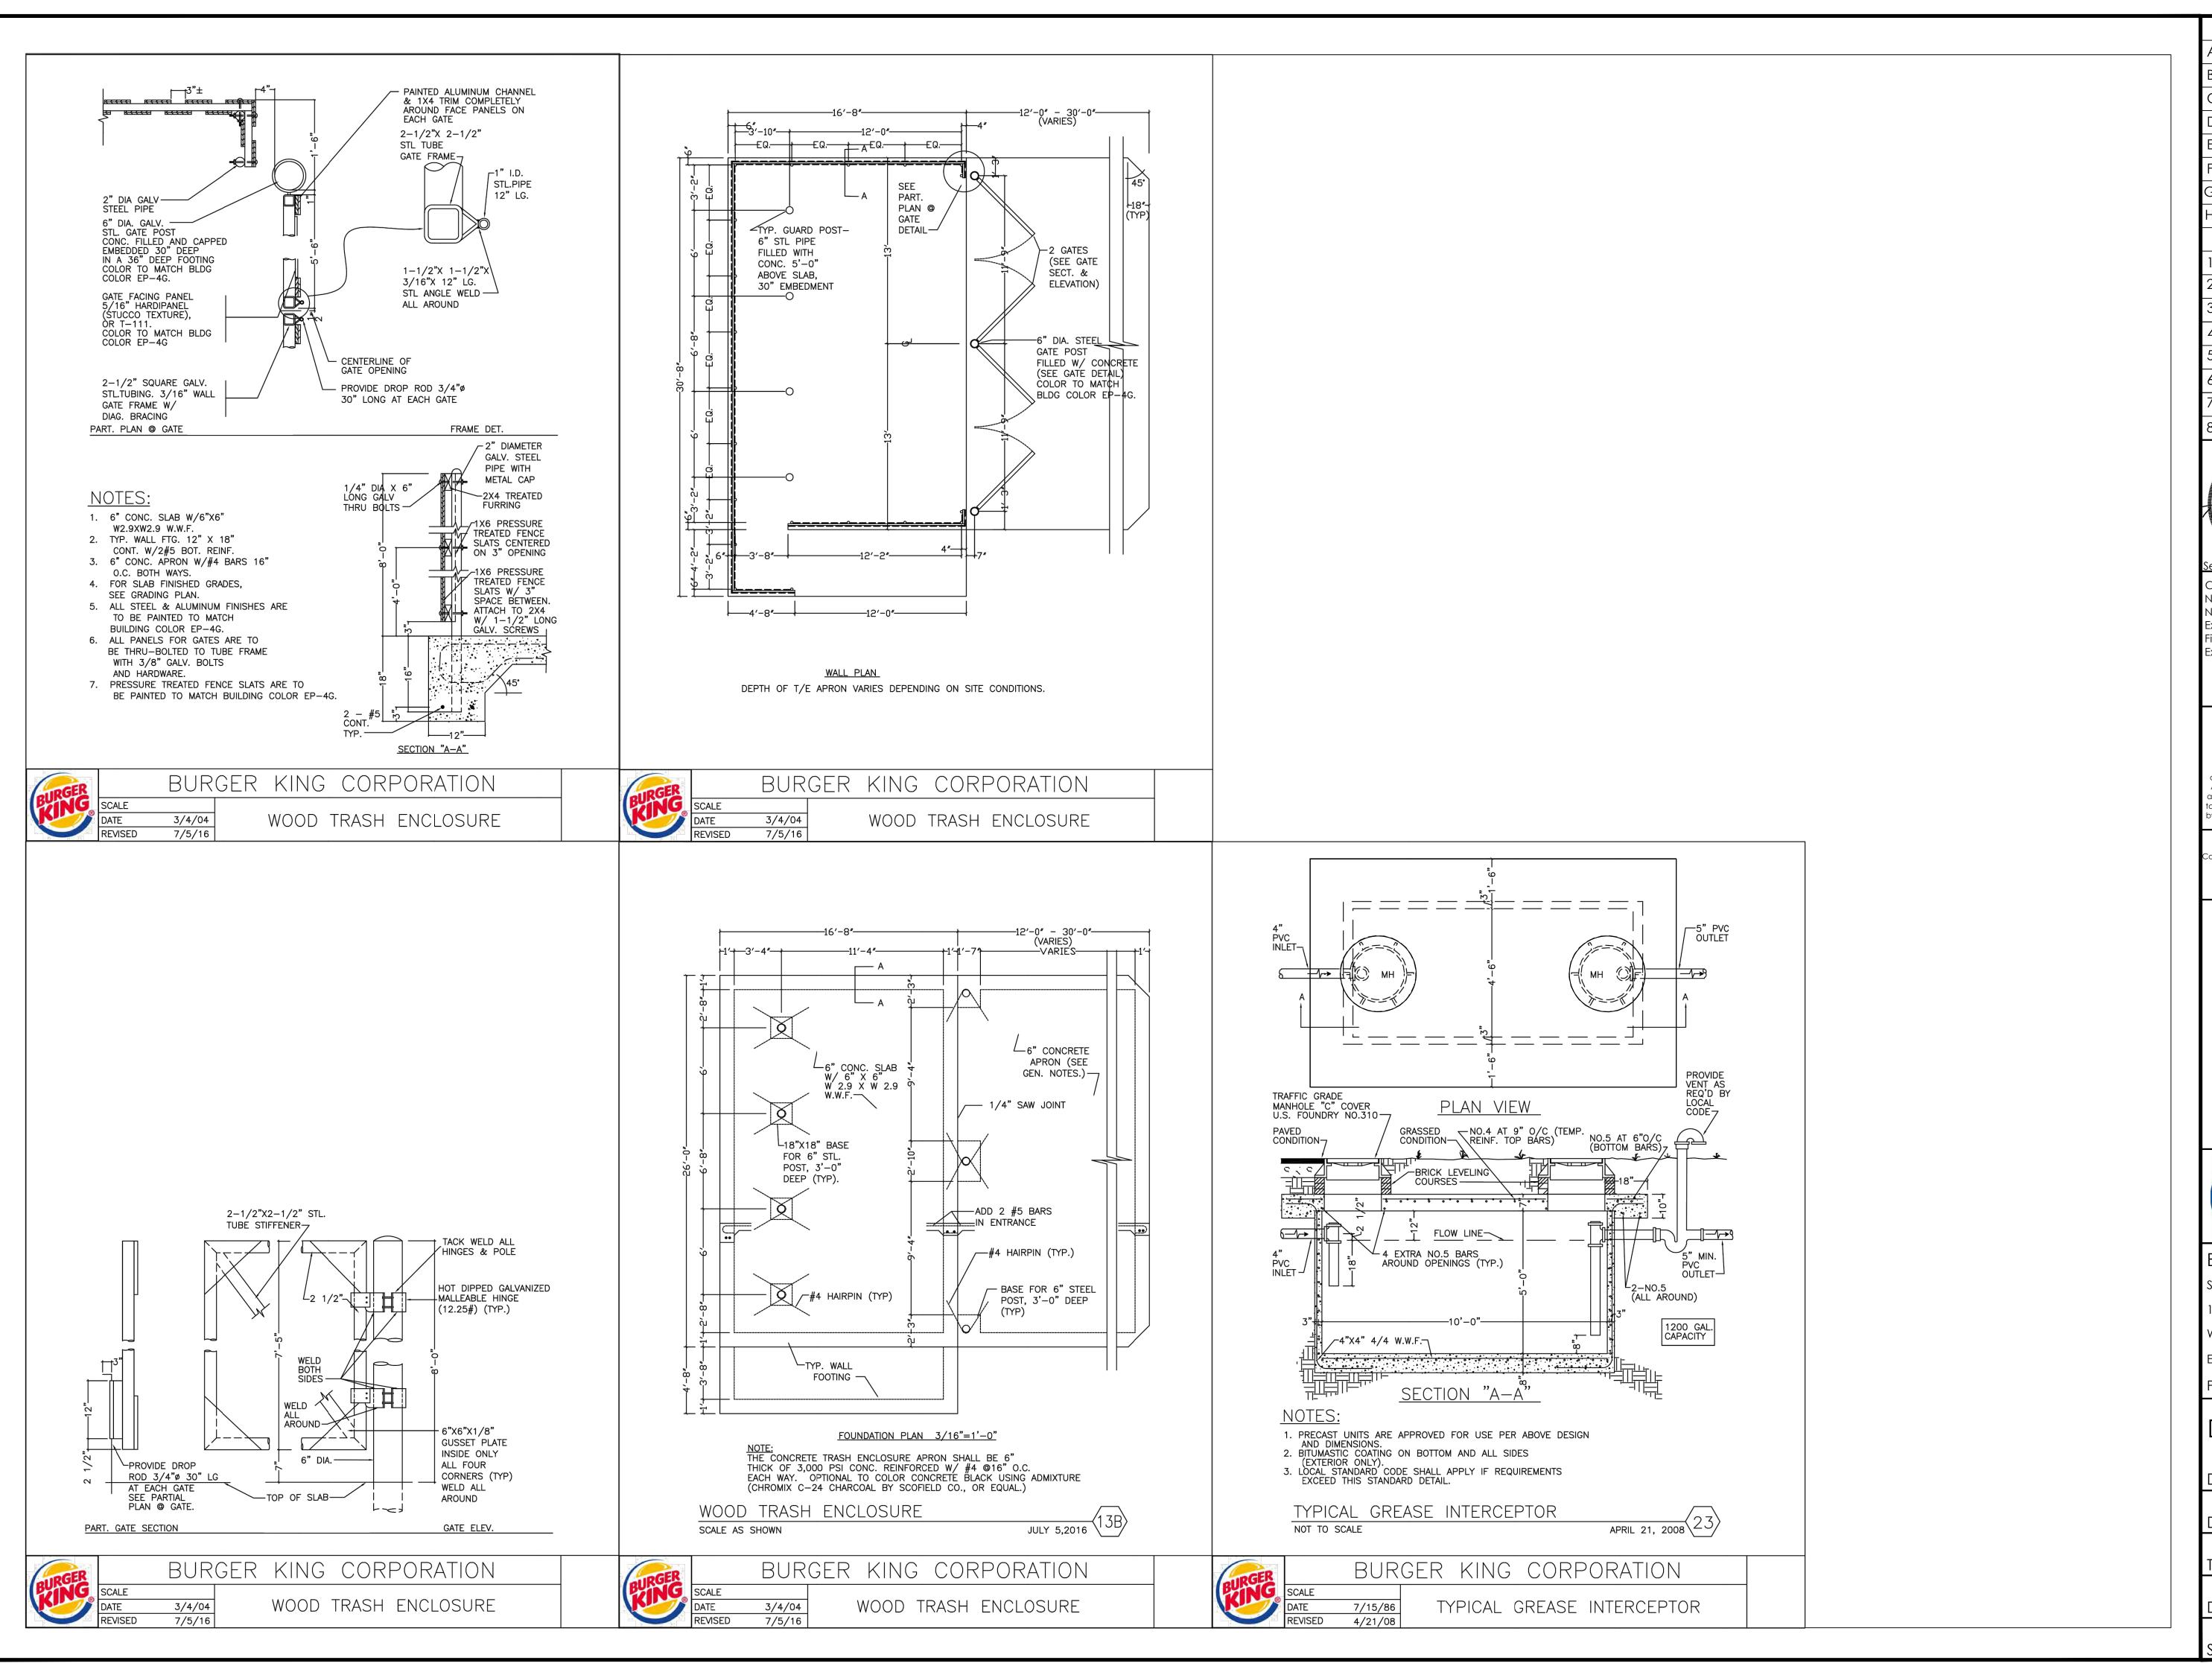

Date: Issued: Date: Revisions: 02/18/22 Revised per Town Comments CIVIL ENGINEER OF RECORD Name: Todd G. Markevicz New York License No.: 080577 Exp. Date. November 30, 2023 Firm Reg. No.: 0014815 Exp. Date: December 31, 2023 Copyright © 2022 A P D Engineering & Architecture PLLC 615 Fishers Run Victor, NY 14564 Drawing Alteration It is a violation of law for any person, unless acting under the direction of licensed Architect, Professional Engineer, Landscape Architect, or Land Surveyor to alter any item on this document in any way. Any licensee who alters this document is required by law to affix his or her seal and to add the notation "Altered By" followe by his or her signature and the specific description of the alteration

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JSC MANAGEMENT GROUP ATTN: JAMES CAMMILLERI BURGER KING FRANCHISEE 585.755.3950

Burger King

Store #: Burger King

S.B.L. No. 143.06-1-11, 12, & 13

1997, 2003, & 2007 Ridge Road

West Seneca, NY 14224

Erie County (Town of West Seneca)

Project Name & Location:

# Details Sheet

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Date:	04/19/21		

	Project No.
Date: 04/19/21	
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Drawing No. N.T.S.

#### THE SPECIFICATIONS ARE NOT PROVIDED AS AN INDICATION OF WORK, BUT PROVIDE REQUIREMENTS AND STANDARDS OF WORK REQUIREMENTS AND STANDARDS OF WORK REQUIRED, DUE TO UNFORESEEN CONDITIONS. ALL WORK SHALL BE PERFORMED IN ACCORDANCE WITH AUTHORITY HAVING JURISDICTIONS REQUIREMENTS. WHEN THESE SPECIFICATIONS ARE IN CONFLICT WITH THE REQUIREMENTS OF THE AUTHORITY HAVING JURISDICTION THE MORE STRINGENT SHALL BE REQUIRED AS DETERMINED BY THE ENGINEER AND AUTHORITY HAVING JURISDICTION.

#### SENERAL CONSTRUCTION CONDITIONS

- The term of Owner as used in these specifications and notes shall include the owner of the property, the company or party that hired the Contractor, the company or party that signed the contract for this work, and the agents of each. The Owner's representative shall be the individual or party assigned by the Owner to be the Owner's representative. Owners of adjacent properties shall include the property owner, lessee, legal occupier, and operator of any business on that property.
- All work and materials shall comply with all local, state, and federal regulations, codes, and O.S.H.A. standards and be constructed to meet or
- The Contractor shall be responsible for all temporary permits, connection permits, fees, inspections and record keeping required by all municipal, utility, health, environmental, state, or federal agencies that may have jurisdiction. Furthermore, the Contractor shall be responsible to meet or exceed all requirements of the agencies or authorities having jurisdiction over his work. All conflicts in requirements of different agencies, authorities, and/or the design shall be brought to the attention of the owner's representative before proceeding.
- The Contractor shall be responsible to locate and maintain the property and project limits throughout the project. All conflicts between the design and the project/property limits shall be brought to the attention of the owner's representative before proceeding. Unless described in the contract documents or shown on the drawings the Owner has not secured any right of ways, easements or agreements with other property owners or property users. Therefore, it shall be the Contractor's responsibility to secure and maintain any temporary right of ways, easements, permits, or agreements he may need to perform his work. All such agreements shall hold the Owner, Engineer of Record, and his agents harmless and the responsibility of the Contractor to bear all costs. The Contractor shall copy the Owner on releases of all agreements prior to final payment by the Owner to the Contractor. The Contractor shall not interfere with operations of adjacent businesses and work shall be completed off-hours, as necessary. Coordinate with Municipality for any restrictions on allowable working hours.
- Unless otherwise noted on the drawings or in the contract documents the Contractor shall be responsible for all construction survey, layout, and record drawings for this contract. Any conflicts in survey/layout and the design or agencies requirements shall be brought to the attention of the owner's representative prior to proceeding with the work. The Contractor shall protect and safeguard all existing survey corners, monuments, control and tie-downs. The Contractor shall pay all costs to repair or replace damaged survey monuments, control and tie-downs. Record drawings shall be provided in accordance with any requirements of the authorities having jurisdiction including the required information to be provided, and signatures, seals, and certifications that may be required.
- No changes to the design or materials specified may be made without written authorization by the Engineer of Record or in the case of utilities or road work to be dedicated, the authority receiving dedication. At the end of the contract, the Contractor shall provide to the Owner a record set of drawings reflecting all changes made by the Contractor during construction.
- Erosion control is necessary whenever sediment, dust, erosion, or contaminated run-off may occur. The Contractor shall be responsible to place and maintain whatever erosion control or run-off protection is required to protect his work, the work of others, the project, adjacent properties and the health and well being of the workers, public and surrounding natural resources. This shall include additional measures beyond the project
- SWPPP and ES plans, as necessary. They shall be familiar with all federal, state and local requirements regarding erosion and run-off control. The Contractor shall be familiar with the project site and all adjacent pedestrian, traffic, and business uses. The Contractor shall take whatever precautions and steps necessary to maintain safety and operation of these uses in accordance with federal, state, county, and local requirements. The Contractor shall be responsible for costs and damages caused from his failure to take proper and adequate precautions. The Contractor shall be familiar with all federal, state, and local requirements regarding these uses.
- The Contractor shall be responsible for costs and delays associated with weather, groundwater, and other occurrences that could be expected or are common with this type of work. The Contractor shall review all pertinent documents including soils reports, soils borings, and other soil or
- The Contractor shall be responsible to save and protect his work throughout the contract. Any damages requiring repairs or replacement shall be corrected by the Contractor at his expense.
- When work is done within a road, utility or private easement, right of way, or other property agreement, the Contractor shall do all work within that area per the authority having jurisdiction.
- When separate site and building contracts are performed, the site Contractor shall be responsible to bring utilities to within 5 feet of building face unless noted otherwise on drawings or contract documents.
- All utilities are shown per surface surveys and/or record maps and may vary from actual in-field locations. The Contractor is responsible for all utility stake outs and locating utilities prior to commencing work. Any damage to utilities due to improper stake out, lack of stake out or the failure to verify differences between drawings and actual field conditions will be the responsibility of the Contractor to repair, replace, or pay
- Contractor shall comply to the fullest extent with the latest standards of OSHA directives or any other agency having jurisdiction for excavation and trenching procedures. The Contractor shall use support systems, sloping, benching, and other means of protection. This includes, but is not limited to, access and egress from all excavation and trenching. Contractor is responsible to comply with performance criteria for OSHA. Trench excavation requiring sheeting, shoring or other stabilizing devices shall be designed by a Professional Engineer and meet all O.S.H.A. requirements. All excavations shall maintain safe side slopes in accordance with local, state and O. S. H. A. requirements. No stocking of material close to an open cut or steep slope will be permitted in an effort to prevent cave—ins.
- The contractor shall select the means and methods for providing support of excavations in accordance with safety requirements, plans, and project specifications. The contractor must evaluate soil conditions during excavations since variations in the soil can occur across the site. The excavations should be monitored continuously for signs of deterioration such as seepage of water or sloughing of soil into the excavation. The contractor is ultimately responsible for excavation safety.
- The Contractor shall notify the Owner immediately and stop all work in areas where hazardous materials are discovered. When required, the Contractor shall notify the appropriate environmental and health agencies.
- The Contractor shall coordinate with the Authority having jurisdiction for all required inspections and be responsible to hire any required third party inspectors.
- For any testing, inspections, and/or certifications requiring a Professional Engineer, the Contractor shall be responsible to hire a third party engineer. A copy of all tests shall be provided to the Engineer of Record.
- Any discrepancies between plans, details, and specifications shall be immediately brought to the attention of the Engineer of Record.
- Stabilizing fabric (woven geotextiles), if required, shall meet the following requirements "modulus (load at 10% elongation) =115lb per ASTM D1682-64", "Grab tensile strength 200lb per ASTM D 1682-64", "mullen burst strength = 400psi per ASTM D 3786-87", "trapezoid tear strength when applicable = 115lb per ASTM D1117-80", "coefficient of permeability K CM/SEC = .015 per ASTM D 4491-85", "water flow rate GPM/SF= 60 per ASTM D 4491-85". When stabilization fabric is used it shall be pulled tight and all wrinkles removed. Overlaps shall be in accordance with manufacturer's recommendations. Refer to Geotechnical Engineers report, if available, for additional information.
- Filter fabric (non-woven geotextile), if required, shall meet the following requirements "grab tensile elongation =50% per ASTM D1682-64", "Grab tensile strength 70lb per ASTM D 1682-64", "mullen burst strength = 200psi per ASTM D 3786-87", "trapezoid tear strength when applicable = 35lb per ASTM D1117- 80", "coefficient of permeability K CM/SEC = .2 per ASTM D 4491-85", "water flow rate GPM/SF= 180 per ASTM D 4491-85". When filter fabric is used it shall be pulled tight and all wrinkles removed. Overlaps shall be in accordance with manufacturer's

#### DEMOLITION

recommendations.

- The Contractor shall inspect all structures, facilities and areas slated for demolition to gain a full understanding of the work required. The Contractor shall take whatever measures necessary to protect the safety of the public, his employees and agents during the inspections and subsequent work. The Owner, Client, and Engineer of Record are not responsible for the condition of the buildings, facilities, or other areas slated for demolition.
- All materials not slated for reuse must be disposed of off site in a legal manner. The Contractor may salvage any equipment or materials not designated by the Owner to be saved. All salvaged material or items shall be removed from the site immediately upon removal. No such materials shall be stored on the site. Absolutely no sales of salvaged materials will be allowed on the project site. All salvaged material must be removed, transported, and disposed of in a legal manner.
- Upon approval by Owner, the Contractor shall be responsible to remove and store safely all materials slated to be saved or reused. The Contractor shall document existing conditions using photographs prior to start of work and notify Owner of any existing damage prior to construction start. The Contractor shall be responsible for all costs to repair or replace existing features to remain (including but not limited to fencing, lighting, curbing, pavement, utilities, storm structures, landscaping, etc.) that are damaged due to his work or failure to protect
- No burning, explosives, or other potentially dangerous methods of demotion will be allowed unless written permission is granted by the Owner and all appropriate permits are granted.
- The Contractor will provide whatever safety equipment and devices are necessary to protect the adjacent properties, structures and other areas slated to remain. This will also include erosion control, dust control, and settlement.
- All areas shall be brought back to their original grade or that of the surrounding area, which ever is closer to the final grades of the project for that area. All areas requiring fill shall be compacted to the requirements of the area but in no case less than 90% of modified proctor (ASTM D 1557).
- All demolition within the proposed building footprint shall be coordinated with the building drawings.
- Light pole removal shall include complete removal, backfill of concrete base, and capping of any conduit/wiring in to be abandoned in place.

#### CLEAR AND GRUE

throughout the duration of his contract.

- Clearing and grubbing shall not commence until erosion control plans, including applicable BMP's, are in place, in accordance with the project
- The Contractor shall review plans and identify and safely mark all plants and trees to be saved. The Contractor shall protect all plants and trees to be saved throughout the contract. This shall include prohibiting any work within the drip line of the tree, except under the supervision of a licensed Landscape Architect.
- All areas to be cleared and grubbed shall be surveyed in the field to establish the appropriate limits of work.
- The Contractor shall take whatever measures necessary to locate and protect existing utilities, structures, wetlands, and other facilities to remain.
- All trees, shrubs, stumps, roots, and other debris shall be removed from site and disposed of in a legal manner No burning will be allowed on site.

#### PAVEMENT AND STRUCTURAL SUBBASE

- The type of subbase required for each use shall be called out on the drawings. If no reference is made on the drawings or details to the type of subbase required the following shall be used:
- The source of the material shall be one approved for use by the State Department of Transportation.
- The material shall be a crushed stone conforming to AASHTO M 147-65 (1980 or latest revision), grade A 1.b. 1.c.
- Cravel or other materials can only be substituted for crushed stone when approved in writing by the Owner and Engineer of Record. 1.d. Material supplied for use as subbase shall have 100% passing the 2 inch sieve, 30% to 65% passing the 3/8 inch sieve, 25% to 55% passing the No. 4 sieve, 15% to 40% passing the No. 40 sieve and 2% to 10% passing the No. 200 sieve.
- Subbase shall be placed in lifts not to exceed 8 inches and compacted to the requirements stated in the soils report. If not stated, the compaction requirement shall be 95% of maximum dry density per ASTM D1557 (modified proctor).
- The Contractor will be responsible for all costs in preparing the subgrade to receive subbase. This shall include fine grading and compacting as necessary to meet the requirements stated here and under Earthwork.
- The amount of testing required to verify the compaction shall be the same as stated under Earthwork. Refer to General Construction Conditions for filter fabric requirements, if applicable.

#### EARTHWORK

- Earthwork shall not commence until erosion control plans, including applicable BMP's, are in place, in accordance with the project SMPPP.
- Refer to Project Geotechnical Report for full project recommendations. Where Geotechnical Report is not clear or does not give requirements, the following may be used.
- operations are complete and all erosion control devices are in place in that area. Topsoil shall be stockpiled in areas designated on the plans or approved by the owner's representative. The Contractor shall review the soils reports, boring logs, and, when necessary, his own field verification so as to be familiar with the depth of topsoil. The Contractor shall take all reasonable precautions to prevent over and under removal.

Prior to starting any cuts or fills the Contractor shall strip and stockpile all topsoil. Stripping of topsoil can only commence after the clear and grub

- Unless otherwise noted, the grades shown on the plans are finished grades. Therefore, pavement, floors, subbase, and other improvements must be subtracted to calculate subgrade elevations.
- The Contractor shall maintain a survey grid of not less than 100' x 100' or other means acceptable to the Owner's representative that will indicate location and amount of cut or fills remaining. At subgrade this grid shall be 50' x 50' with location and final grade marked clearly or survey shall be completed demonstrating that the subgrade is  $\pm$ 0.1 feet of required subgrade.
- Unless otherwise noted on the drawings or in the contract documents, the Contractor shall retain and pay all cost for soil compaction testing to be performed by an independent testing laboratory. For each lift placed, compaction testing shall be done every 2000 sq. ft. In trenches, compaction testing shall be done every other lift with at least 1 test every 50 LF.
- Structural fill placed 2 feet or deeper below the finished subgrade elevation or finished grade of graded areas shall have a moximum particle size of 6 inches. Structural fill placed within the upper 2 feet of proposed subgrade or finished grade of graded areas shall have a moximum particle size of 3
- Compaction requirements shall be those outlined in the soils report, if provided. If the soils report is not clear or does not give requirements, the following will be used:
- Under and to 20 feet outside the building envelope the soils shall be compacted to a minimum of 95% maximum dry density per ASTM D 1557 (modified proctor).
- Under proposed or future pavement areas, including 10 feet outside such areas, the soil shall be compacted to a minimum of 93% maximum dry density per ASTM D 1557 (modified proctor).
- All landscape and lawn areas shall be compacted to 90% maximum dry density per ASTM D 1557 (modified proctor).
- The testing lab shall test soils in accordance with ASTM D 2922 (nuclear method) with proctors for each soil type. Constructed berms shall be compacted to 95% maximum dry density per ASTM D1557.
- All material to be used for fill shall be free of organics, frozen material, contaminated material, debris, and any rocks larger than 4 inches. For fill placement within 1 foot of subgrade, no rock shall be greater than 2 inches in diameter. The Contractor shall bear all cost associated with drying, segregating, or required methods to treat soils to meet compaction and other requirements.
- All fill placed within berms that detain/retain water shall be a minimum of 20 percent by weight of material passing the No. 200 sieve, and a maximum particle size of 6 inches. The limit of the berm areas shall include both the upstream and downstream slopes. Any on-site cut areas could be utilized as fill material for the berm, as long as all construction requirements and specifications were met (placement, compaction, gradation, permeability, etc.). Inclusion of vegetation, organic material, or frozen soil in the embankment, as well as placing of embankment material on a frozen surface is prohibited. Bedding material for all pipes and conduits within berm area shall be placed in layers not thicker than 4 inches before compaction with particle size limited to 3 inches in the greatest dimension, and compacted to required density of fill material for berm. Anti-seep collars are required for all pipes/utilities within the berm area.
- The Contractor shall take all necessary precautions to protect earthwork operations from weather and ground water including keeping positive drainage, divert drainage, dewatering, and sealing disturbed areas with a steel drum roller prior to inclement weather.
- 12. If imported material is required, the source and a random composite sample shall be reviewed by the testing laboratory prior to being brought to site. The testing laboratory shall test for percent passing the 200 sieve that does not exceed the existing on site material or in no case greater than 10% They shall also verify consistency with existing on site materials and all other requirements. Waivers to these requirements can only be given jointly by Engineer of Record and the Geotechnical Engineer that prepared the soils report.
- 13. The testing lab may restrict some on site materials from being used as fill in building or pavement areas when it is their opinion that the material will not meet requirements stated here. If such conditions do exist and other material is not available on site, the owner's representative must authorize in writing the use of import material unless there will be no additional cost to the contract.
- Fills shall be placed in lifts not to exceed 8 inches in mass fills and 6 inches in trench or restricted areas. All subgrades shall be thoroughly proofrolled using a smooth drum roller with a minimum static drum weight of 20 tons, operated in static mode. A minimum of 2 overlapping passes in one direction, followed by 2 overlapping passes in a direction perpendicular to the first 2 passes. Areas which are unsuitable and which cannot be stabilized with repeated compactive effort shall be overexcavated to a suitable subgrade. The undercut should be of adequate depth such that, after backfilling is complete the resulting subgrade surface is firm and stable under proofrolling. Onsite structural fill may be used to attain proposed subgrade elevation to replace the removed unsuitable material. If imported structural fill, base, or subbase course materials are used to backfill the undercuts within the building or pavement areas, a woven geotextile should be placed at the bottom of the undercut area prior to placement of the fill.
- Contractor is to remove any debris or surficial organic soils (ie. topsoil, organic subsoil, reworked soil) which may be encountered within the proposed
- building footprint, floor slabs, and pavement areas prior to the placement of any fill. 16. All final subgrade under proposed povement, building, or other structure shall be proof ralled as described above for the identifying of soft areas. Areas found to be unacceptable shall be scarified, dried, and re- compacted. Retest by proof roll as necessary.
- 17. All fill material is to be in place and compacted prior to installation of proposed utilities. Refer to pipe bedding details for trench dimensions. Additional width will only be allowed when compaction equipment limitations require and only after approval of the Engineer of Record. No more trench shall be open in one day than can be properly backfilled in that same day to minimize weather and safety concerns. When backfilling around pipes, provide uniform support at invert and proper compaction under, along, and over the pipe. Care shall be given while backfilling arcund pipes to prevent damage to the pipes including: placing backfill/bedding by hand, using hand operated plate tamps or jumping jacks, and other load restrictive techniques until fills are a minimum of 2 feet or manufactures recommend depth, which ever is greater, above the top of the pipe. Compaction requirements are not relieved in these areas and will remain as stated on the drawings or above. If clean stone is used as a bedding or encasement, filter fabric shall be placed between the natural soils and backfill and the stone to prevent migration of fines. Anti-seep collars shall be provided in accordance with the details. The Contractor is cautioned against the migration of fines from soils adjacent to voids. Where such conditions exist the Contractor shall install or wrap those areas with filter fabric to prevents fines from migrating into voids.
- 18. If rock is encountered that was not indicated on the plans or soils report, the area for removal should be measured and reviewed with the owner's representative prior to rock removal. Rock will be defined as the natural earth materials that can not be removed with conventional earth working
- Where rock is adjacent to a structure or utility, the rock shall be removed to a minimum of 6 inches below and 1 times the diameter, but not less than 1 foot or greater than 3 feet on any side.
- 20. No explosives will be allowed until all permits are granted and the Owner has signed off. Pre and post blast reports must be kept and recorded. All structures within the area of the blast must receive a pre- blast survey. All blasting must be performed by a licensed blaster.
- 21. Unless otherwise noted on the drawings, the Contractor shall remove all excess topsoil, cut material, or waste material from site and dispose of in a

#### TRAFFIC SIGNAGE AND PAVEMENT MARKINGS

- Pavement markings shall be the type, color, size, and locations shown on the plans. Contractor shall provide two (2) coats of paint for all pavement markings. If the information on the plans and details is not complete and the authority having jurisdiction does not have requirements regarding this, use the following:
- Paint shall be supplied in accordance with AASHTO: M 248 latest addition.
- Colors shall be as follows:
- 1.b.1. YELLOW- parking stalls, parking islands, and fire lanes
- 1.b.2. WHITE — stop bars and lettering, pedestrian crossings, handicap parking symbol and characters, and traffic control lettering and characters
- 1.b.3. BLUE — background of handicap parking symbol
- The pavement shall be clean and free of dirt, dust, moisture, oils, and other foreign materials. Any old pavement markings shall be removed unless paints are compatible and overlay identically. The surface of the povement prior to application shall be 45 degrees F and rising unless manufacturer's recommendations are greater. All painting shall be applied in appropriate weather conditions (e.g. temperature, wind, precipitation), and in accordance with manufacturer's recommendations.
- The signage and pavement markings shall be the type and at the general location shown on the drawings. The signage and pavement markings shall be provided and located in accordance with the Local Highway, County Highway, and State Department of Transportation. If local, county or state codes do not exist use MUTCD.
- Posts, brackets, and frames shall be steel per ASTM A-36, A-242, A-441, A-572, A588, Grade 50, and hot dip galvanized in accordance with ASTM A123. All cutting, or other pole modifications shall be painted with galvanizing paint. All bolts, nuts, and washers shall be stainless
- Post holes in pavement shall be a minimum of four feet deep and 12 inches in diameter unless poor soils or frost conditions require greater depth. Sign posts shall be kept plumb, 6 inches off bottom and centered as 4000 psi concrete is placed around the post. The overall sign and post system should be able to withstand 33 pounds per square foot.
- 6. Contractor can place signs on posts after concrete has cured for seven days or 3/4 strength is achieved.
- All handicap striping and signage, including spaces, crosswalk, accessible path, and curb ramps, shall meet Americans with Disabilities Act (ADA) requirements. Fire lane striping and signage shall meet the requirements of the local building inspector and fire department.

#### SITE CONCRETE - INCLUDING CURB, SIDEWALKS AND GUTTERS

- The dimensions shall be those shown on the drawings. The Concrete mix shall be 4000 psi at 28 days made with type I or type II cement per ASTM C 150 and aggregates meeting State Department of Transportation requirements, unless otherwise noted. Slump for slip forming shall be 1 inch  $\pm -1/2$  inch and for formed concrete the slump shall be 3 inch  $\pm -1/2$  inch. Air entraining mixture shall meet the requirements of ASTM C 260 4% +/- 1 1/2% for slip form work and 6% +/- 1 1/2% for formed and placed concrete. Water reducing agent shall conform to ASTM C 494, type A. Ouring compounds shall conform with ASTM C309, type I, class A moisture loss of not more than .055 gr/sq cm when applied at 200 sq ft per gallon.
- Sidewalks, gutters and curbs shall be placed on compacted subbase consistent with the pavement subbase as shown on the drawings. When subbase details are missing and no agency has jurisdiction use the following: sidewalks and gutters shall be placed on a minimum of 6 inches of compacted subbase and curbs shall be placed on a minimum of 4 inches of compacted subbase
- 3. All forming, placement, materials and curing shall conform to the latest addition of ACI 318 "Building code requirements for reinforced concrete" and all similar State Department of Transportation requirements.
- Reinforcing shall be in accordance with that specified on the drawings and the Concrete Reinforcing Steel Institute (CRSI) "manual of standard practices". Reinforcing steel shall be ASTM A 615, grade 60, deformed. Welded wire fabric shall be ASTM A 185, welded wire steel fabric. Sidewalks, and gutters shall have a broom finish perpendicular to flow with a picture frame edge joint all the way around. Curbs shall have a smooth finish or light rub finish but consistent throughout the project.
- 6. Expansion joints shall be placed as per details and at adjoining structures such as walls, manholes and vaults. Expansion joint material shall be premolded, 1/2 inch material with 23/64 inch cap in accordance with ASTM D1751. After concrete has set the cap should be removed and void filled with waterproof joint filler. Curb and gutter shall be cut or tool jointed to 1/3 the depth every 10 feet. Sidewalks should have tooled or cut joints to 1/3 the depth in squares or as close to square as possible not exceeding 5ft x5ft.

#### WATER SYSTEMS AND SERVICES

- The water systems and services shall be supplied and placed in accordance with all local, state and federal requirements. When the requirements of the authority having jurisdiction differ from those shown on this plan, Contractor shall adhere to the more stringent standards.
- Refer to Pipe Bedding Detail for pipe bedding requirements.
- All water piping, fittings and appurtenances shall be placed a minimum of 6 inches below frostline or with a minimum 5 feet of cover, whichever is greater. Pipe sizes 4 inches and up shall be ductile iron or polyvinyl chloride as indicated on the drawings (if not shown use ductile iron). Pipe sizes below 4 inches shall be copper or polyethylene as indicated on the drawings (if not shown use copper).
- The minimum separation between water services and sewer lines shall be 18 inches measured vertically from outside to outside of pipe at the crossing. A standard length of water pipe shall be centered at the crossing to maximize the distance between the crossing and the nearest water service pipe joint. The sanitary line shall be ductile iron pipe with mechanical joints at least 10 feet on both sides of crossing, the waterline shall have mechanical joints with appropriate thrust blocking as required to provide a minimum of 18" dearance meeting requirements of ANSI A21.10 or ANSI 21.11 (AWWA C-151) (Class 50). Contractor shall adjust elevation of water as needed to maintain adequate separation and burial depth. When the water service runs under the sewer line, a gravel or crushed stone backfill meeting the requirements of subbase shall be placed and compacted around the water pipe up half the diameter of the sewer pipe to provide adequate support to the sewer line. Ductile iron pipe shall be provided in accordance with AWWA C151. (6 inch diameter and greater shall be Class 50 and 6 inches and smaller shall be Class 51). Ductile iron pipe shall be lined with a cement mortar and seal coated in accordance with AWWA C104. Caskets shall be provided in accordance with AWWA C111. Fittings shall be ductile iron in accordance with AWWA C153 compact fittings with a pressure rating of 350 psi. Water services and sewer lines running parallel shall have a minimum separation of 10 feet measured from outside of pipe to outside of pipe. At crossings, one full length of water pipe shall be located so both joints will be as far from the sewer as possible. Special structural support for the water and sewer pipes may be required.
- All pipes shall be installed per manufacturer's recommendations. Ten gauge copper tracer wire shall be placed with all plastic pipe. Pipe material shall be as follows: PVC (Polyvinyl Chloride) pipe shall be furnished in accordance with AWWA C900 for pipe 4 inches or greater and ASTM D 1785, schedule 40, gaskets per ASTM F 477- elastomeric seal, solvent cement per ASTM D 2564 for pipes smaller than 4 inches.
- PE (Polyethylene) pipe shall be furnished in accordance with AWWA C901 and ASTM D2737. Ten gauge copper tracer wire will be placed with all plastic
- DIP (Ductile iron pipe) shall be provided and installed in accordance with AWWA C151 and C600 (6 inches and greater shall be Class 50, smaller than 6 inches shall be Class 51). Ductile iron pipe shall be lined with a cement mortar and seal coated in accordance with AWWA C104. Gaskets shall be provided in accordance with AWWA C111, Fittings shall be ductile iron in accordance with AWWA C153 compact fittings with a pressure rating of 350 psi. Standard ductile iron or cast iron fittings shall be supplied in accordance with AWWA C110 with a pressure rating of 250 psi. The lining and gaskets for the fitting shall meet the same requirements as the pipe. If recommended in the soils report, ductile iron pipes shall be encased in polyethylene in accordance with
- AWWA C105 and tar coat all fitting bolts whenever soils are primarily day or not pH balanced. Copper water pipe shall be supplied in accordance with ASTM B 88- type K, seamless with fittings per AWWA C800.
- Cate Valves shall be nonrising stem, double disc, bronze disc Resilient seated, cast iron or ductile iron body and bonnet in accordance with AWWA C509 and pressure rated for 250 psi. Ten gauge copper tracer wire will be placed with all pipes.
- Valve box shall be cast iron with a base compatible with valve, 5 inches in diameter, screw type extension at top and a cover that reads "WATER".
- Authority so requires, the taps and/or connections shall be done by the Authority themselves and paid for by the Contractor. Thrust restraints shall be used at all fittings, plugs and appurtenances that cause a change in direction, flow or are subject to thrust or hammering by water flow. Thrust restraints will include concrete thrust blocks (3000 psi), anchoring joints and tie rods. Concrete thrust blocks shall be used unless space, access or

All top and/or connection material and work shall be done in accordance with and coordinated with the local Water Authority and Health Department. When the

- Ourb stops shall have a bronze body, ground key plug or ball with wide tee head. The curb stop shall be compatible with adjoining pipes. The service box shall have a telescoping top section with a length that will place the adjustment centered when buried to the appropriate depth. The service box shall be of a size and type that is compatible with the curb stop. The cover shall have the lettering "WATER".
- All meters, vaults and backflow shall meet the requirements of the health department and other agencies having jurisdiction.
- Fire hydrants shall conform to the requirements of the local water authority, fire department and AWWA C502. Drain stone shall have 100% passing the 1 1/2 inch sieve, 90 - 100% passing the 1 inch sieve, 35 - 95% passing the 1/2 inch sieve and 0 - 15% passing the 3/8 inch sieve. All hydrants will include a gate valve
- and box located at the hydrant branch to shut off the hydrant line. 13. All bedding and encasements shall be compacted with care to achieve proper compaction without damaging the pipe, fittings, or appurtenances.
- If clean stone is required by the local authority having jurisdiction and is approved by Owner and/or Engineer of Record, then the bedding material shall be wrapped in filter fabric and anti-seep collars shall be provided to prevent the migration of fines.
- All water mains fittings and valves shall be tested for pressure and leakage in accordance with AWWA C600. Test water shall be potable. Test pressures shall not be less than 1.25 times the working pressure at the highest point and 1.5 times the working pressure at the testing point. The pressure may not drop more than 5 psi during the 2 hour test. Leakage will not exceed more than (L=SD(P)1/2 /133,200) where "L = allowable leakage, in gallons per hour" "S= length of pipe tested, in feet" "D= nominal diameter of pipe, in inches" "P= average test pressure during test, in pounds per square inch (gauge) during the same 2 hour
- 16. Other fitting and appurtenances not part of the main line testing shall be tested by visual inspection for leakage under normal working pressures.
- All main lines and appropriate appurtenances shall be flushed and disinfected in accordance with AWWA C651 and the requirements of the appropriate health The Contractor will coordinate all testing and disinfecting with the water authority and health department.

19. Any testing failure shall require the Contractor to repair or replace the failed section at no additional expense to the contract.

- STORM WATER SYSTEM The storm water system shall be supplied and placed in accordance with all local, state and federal requirements.
- Storm design includes many variables, such as pipe roughness coefficient, that can affect the actual final run-off. If no alternative materials are listed on the utility drawings, no substitutions may be made by the Contractor unless first reviewed and accepted by the Engineer of Record.
- 3. Refer to Pipe Bedding Detail for pipe bedding and anti-seep collar requirements.
- 4. Storm pipe material shall be as follows: 12 inches and up shall be corrugated polyethylene pipe (OPP) with smooth interior, in accordance with AASHTO M252 & M294 and ASTM F405 & F667,
- with a manning friction number (n) of 0.013 or less. Install in accordance with ASTM F449 and the manufacturer's recommendations. Smaller than 12 inches shall be CPP, as per requirements above, or Polyvinyl Chloride (PVC) per ASTM D 3034, SDR 35 with gaskets per ASTM D
- 3212. elastomeric seal. End sections shall be the same material as the preceding pipe and appropriate collar.
- Increase size of manhole if in the same horizontal plane there is two areas where the area between two pipes is less than 8 inches or ½ of the circumference is supported by less than ½ of the diameter of the manhole. Inverts shall be smooth cast in place concrete. Caskets between risers shall be rubber per ASTM C 443. Adjustment rings shall be precast concrete 4000 psi and 5 to 8% air entrainment.
- Inlets shall meet the same requirements as those listed for manholes, except sumps shall be provided as per details, rather than a smooth invert. Grates shall be galvanized per ASTM A123. Minimum grate opening size will be 24 inches x 24 inches and design for a minimum of H-20 loading. Refer to
- 9. Dry wells shall meet the same requirements as those listed for manholes with the addition of openings of approximately 15% of the rings interior surface. The openings shall be 1 x 3 inch slots or 1 inch diameter on the inside surface. Dry wells shall be backfilled with a minimum of 1 foot of clean stone sized between 3 and 4 inches. Outside the stone, the entire structure shall be wrapped in filter fabric to prevent outside soils from entering the stone and dry
- 10. Unless otherwise noted, underdrains and trench drains shall be made with 4 inch perforated corrugated polyethylene pipe encased in clean stone sized between 2 inch and ¼ inch and then wrapped in filter fabric. Outside dimensions of the trench drain will not be less than 1 foot.

11. All storm pipe entering structures shall be grouted to ensure connection at structure is watertight and structurally sound. All storm sewer pipes entering and

- exiting structures shall be flush with the inside of the structure wall. 12. All pipe shall be placed in accordance with the manufacturer's recommendation and to the lines and grades shown on the drawings. Care shall be given during backfill operations not to move or damage pipe or appurtenances while achieving the appropriate compaction requirements.
- 13. All systems shall be visually inspected for alignment and workmanship. All debris, dirt or other foreign objects shall be removed from system by a method of than flushing and material removed shall be disposed of properly. 14. Any pipes found with diameter deflections greater than 5% of the specified pipe diameter will be repaired or replaced. Any diagnment differentials greater than
- 5% of the diameter of the pipe will be corrected or replaced. 15. Any cleaning, repairs, or replacement required due to failure of testing or poor workmanship shall be done by the Contractor at no additional expense to the

#### ASPHALT PAVEMENT

be removed and replaced prior to application of the top course.

eaud to that of the proposed or existing which ever is greater

- Asphalt shall be the type or types specified on the drawings. If no type is indicated the Contractor shall use a mix specified by the State Department of Transportation for top and binder. In New York State that would be type Asphalt Concrete Binder Course Type 19 and Asphalt Concrete Surface Course Type 12.5. All asphalt shall be produced in state approved plants with state approved products.
- Asphalt will only be placed when the outside temperature is 45 degrees F and rising. Asphalt will never be placed on frozen material, during medium or heavy precipitation or when preceding precipitation has saturated the subbase and/or subgrade.
- 3. Surfaces that will abut the new asphalt shall be tack coated prior placement of asphalt including curbs, gutter, existing asphalt and structures. Tack coat shall be applied neatly to match the lines and grades of the proposed abutting asphalt at a rate of .05 to .15 gallons per square yard. When binder is used as a working surface during construction, or there is a prolonged time period between binder and top placement, the surface must be
- Asphalt shall be placed in layers equal to those specified on the plans. Thickness of each layer or the thickness of all layers combined shall not vary more than 1/4 inch for thickness of 0 to 4 inches and 1/2 inch for thickness of 4 inches or greater, from those specified on the drawings. The asphalt shall also be tested for smoothness by laying a 16 foot straight edge on the pavement and verifying that there are no gaps greater than 1/4" in any direction. 6. Placement and compaction requirements shall be the same as those specified by the State Department of Transportation of which the project is located. The

power washed, not just swept, and a tack coat should be applied prior to installation of top course. In addition, any yielding area of pavernent binder should

- rolling shall be done in such a manner that will match joints and leave a smooth uniform surface while providing the proper compaction which will be 95% of laboratory density. When matching into existing pavement, all match joints shall be saw cut to provide a straight smooth joint. The asphalt depth at the match point shall be
- Paving equipment shall be of good condition and quality. Asphalt shall be placed by mechanical equipment except in small areas that are inaccessible to a power. The binder joints and the top joints shall be offset. The top course shall be placed parallel to the direction of travel. Asphalt shall be transported in covered trucks and scheduled in such a manner that will maintain asphalt temperature. Asphalt shall be rejected when temperatures fall below 250 degrees F or the minimum temperatures specified by the State Department of Transportation.
- All sub-base, asphalt, curb or other work performed in a State, County or Municipal right-of-way shall be furnished, installed, inspected and completed in accordance with their specifications, details and other requirements.

#### SEEDING AND LANDSCAPING

- Topsoil shall be removed from stockpiles and spread in the areas shown on the plans. The depth of topsoil shall be a minimum of 4 inches in lawn areas and a minimum of 12 inches in landscape planting areas. If enough topsoil is not available onsite, the Contractor is required to import as necessary. All disturbed lawn areas are to receive topsoil, seed, mulching, and water until a healthy stand of grass is established.
- Topsoil shall consist of fertile, natural agricultural soil substantially free of subsoil, stumps, roots, brush, stone, day lumps, or similar objects larger than 2 inches in the greatest diameter. Topsoil for reuse shall be screened if required to meet size and debris removal. Topsoil shall be approved by the owner at its source prior to transporting. The topsoil shall be fine graded to the lines and grades shown on the plans. The Contractor is responsible for keeping topsoil, seed, fertilizer, etc. off structures, pavements, and other site amenities; and will clean up unwanted
- Mow all areas to be cleared & seeded to 6" height maximum prior to beginning any new lawn work.
- Loosen and till subgrade of lawn areas to a minimum depth of four inches, remove stones measuring 1.5 inches in any dimension, remove sticks, sod, rubbish, and other extraneous matter. Limit preparation to areas which will be planted promptly after preparation.
- Preparation of unchanged grades: where lawns are to be planted in areas that have not been altered of disturbed by excavating, grading, or stripping operations, prepare soil for lawn planting as follows: till to a depth of six inches, apply soil amendments and initial fertilizers as specified. till soil to a homogenous mixture and fine texture and complete fine grading.
- Clean all new lawn areas to be seeded of all debris, branches, stumps, brush, logs, metal, sticks, stones, etc. larger than two inches in
- Roll, rake, and/or arag lawn areas to remove ridges and fill depressions to meet finish grades and to create a smooth, mowable lawn surface. Lime: natural dolomitic limestone containing at least 85% of total carbonates, and 30% magnesium carbonates; ground so that at least 90% passes a ten mesh sieve, and at least 50% passes a 100 mesh sieve.
- The topsoil shall have a pH of 6.0 to 6.8 and an organic content of 3 to 20%. The gradation of the topsoil shall be 100% passing 2 inch sieve, 85 to 100% passing the 1 inch sieve, 65 to 100% passing the 1/4 inch sieve and 20 to 80% passing the No. 200 sieve.
- 10. Lawn fertilizer shall be 55% nitrogen, 10% phosphorus and 10% potash where 50% of the nitrogen is derived from ureaform source. Work into soil at a rate of 100 lbs per acre before seeding.
- Lawn seed shall be "50% by weight, 85% purity, 85% germination of Pennfine Perennial Rye", "30% by weight, 97% purity, 85% germination of Pennlawn Red Fescue", "20% by weight, 85% purity, 80% germination of Common Kentucky Bluegrass" at a rate of 200 lbs per acre. Mulch all seeded areas with approved straw at rate of 4000 lbs per acre. Maintain mulch as necessary and clean up upon satisfactory germination.
- 12. Steep slope mix (Type B unmowed 1V:3H or steeper) apply at a rate of 100 lbs. per acre using the following proportions by weight: 15% Creeping Red Fescue, 35% Chemung Crownvetch, 25% Kentucky 31 Tall Fescue, and 25% Empire Birdsfoot Trefoil.
- acre, water at 500 gallons per acre, and seed at a minimum of 220 pounds per acre. Inoculate at 4x manufacturer's rate. A non-harmful color additive which colors the hydroseed mixture green shall be added to the mixture to allow visual metering of its application. The hydroseed mixture shall be sprayed upgrade and uniformly on the surface of the soil to form an absorbent cover, allowing percolation of water to the

Hydroseeding shall be applied in accordance with the following; fertilizer shall be placed at 80 pounds per acre, hydromulch at 1,200 pounds per

- The Contractor will be responsible to water, reseed, or any other means necessary to ensure the growth of the lawn until a complete and uniform stand of grass has grown and been cut at least three times. Water by approved means immediately after mulching and thereafter a minimum of two times each week, or more when weather conditions require to a depth of one inch soil saturation. Mow all seeded areas to two inch height until find acceptance. In the event grass becomes too long, resulting in excessive dippings that could damage the lawn, the contractor shall remove all dippings at his expense. Lawn shall be presented to Owner in a condition that it may be maintained with standard mowing equipment.
- Where substantial lawn remains (but is thin), mow, rake, aerate (if compacted), fill low spots, remove bumps, and scarify soil, fertilize, and seed. Remove weeds before seeding, if extensive. Apply selective chemical weed killers as required. Apply mulch if required to maintain moist condition. 16. Plantings shall be supplied in accordance with the plans and ANSI 260.1 "American Standard for Nursery Stock" in good health, vigorous, and
- free of insects, larvae, eggs, defects and disease. Plants shall be located per the plans. The holes shall be excavated per the details on the drawings with the center slightly higher to promote drainage. Use a topsoil backfill mix of 4 parts topsoil, 1 part peat moss, 1/2 part well rotted manure, 2 pounds 5–10–5 planting fertilizer
- 18. Two layers of weed barrier made from fiberglass and ultraviolet light resistant shall be placed under all planting beds prior to mulching. 19. All trees and shrubs shall be staked as detailed on the drawings. Tree wrapping will be provided at the base of all trees as detailed.

properly mixed per cubic yard. Berm around plants to form a bowl shape.

- 20. Mulch all beds with 3 inch river rock graded gravel, 1" to 2" size range on fiber mat week barrier Verify with JSC Management prior to placement. Mulch shall be 50% shredded bark and 50% wood chips, 3/4 to 2 inch in size, uniformly mixed and free of elm wood. Mulch shall be placed uniformly over the planting bed allowing no weed barrier to be seen to a minimum depth of 3". Color to be chosen by Owner. 21. All landscaping shall be guaranteed for ane year after final acceptance. Any plantings needing replacement will be guaranteed from the time of replacement if after final acceptance. Contractor shall maintain plants until completion and final acceptance of the entire project. Maintenance
- shall include pruning, cultivating, edging, remulching, fertilizing, weeding, watering as required for healthy growth, and application of appropriate insecticides and fungicides necessary to maintain plants free of insect and disease. Repair all washouts, gullies, and areas of unsatisfactory germination by replacing topsoil, restaking, and reseeding, as required. Reset settled plants to proper grade and position. Restore planting saucer and remove dead material. Tighten and repair auide wires and deficiencies within the first 24 hours of initial planting, and not less than twice per week until final acceptance. Contractor shall request an inspection by the Owner upon establishment of the uniformly germinated lawn. Following the final acceptance, the Owner shall be responsible for maintenance of all landscaping on the premises.
- 22. Antidesiccont: protective film emulsion, providing a protective film over plant surfaces, but permeable to permit transpiration. Mixed and applied in accordance with manufacturer's instructions. Apply to all broadleaf evergreen shrubs per manufacturer's recommendations.

#### SANITARY SEWER SYSTEMS

structures shall receive bitumastic coating.

- The sanitary sewer system shall be supplied and placed in accordance with all local, state and federal requirements.
- 2. Refer to pipe bedding detail for bedding and anti-seep collar requirements. Unless otherwise noted, sanitary pipe and fittings shall be Polyvinyl Chloride (PVC) per ASTM D 3034, SDR 35, with gaskets per ASTM D 3212,
- elastomeric seal. Forcemain pipe shall be Polyvinyl Chloride (PVC) per ASTM D 2241, SDR 21 (or lower if pressures are high in system) with gaskets per ASTM D 3139, and elastomeric sed. The pipe shall be encased in a run of crush stone or gravel material with 100% passing the 1.0" sieve and 10% to 3%
- water silts or sands are encountered. 5. All pipe shall be placed in accordance with the manufacturer's recommendation and to the lines and grades shown on the drawings. Care shall be

given during backfill operations not to move or damage pipe or appurtenances while achieving the appropriate compaction requirements.

passing the 200 sieve. The mix shall be supplemented as needed to remove voids. Incorporate filter fabric around bedding or cradle stone if ground


- All systems shall be visually inspected for diignment and workmanship. All debris, dirt or other foreign objects shall be removed from the system. All taps to main lines shall be made with saddles when the tap is 1/2 the diameter or less of the existing pipe, but made with a sleeve when the tap is greater than 1/2 the diameter or equal to the existing pipe. If connections are required to equal size pipes of 8 inches or greater, a manhole should be installed over the connection point and inverts formed. When connecting to an existing manhole, the connecting pipe hole shall
- be cored and a press wedge installed. The connection shall be mortared up with waterproof/plug mortar. Inside the existing manhole, the existing invert shall be broke out in a manner that protects from debris entering the live system, while a new invert is formed. Sanitary manholes shall be visually lamped after backfill to verify diignment, deanliness and there is no damage to the system. After the system
- has been backfilled for 30 days, the system shall be relamped and tested with a mandrel sized at 95% of the intended inside diameter. 9. Gravity systems shall be air tested between manholes to 3.5 psi for 5 minutes per ASTM F 1417 for plastic pipes.
- 10. Manholes shall be tested separately for leakage or infiltration using ASTM C 969. The allowed leakage = 0.1 gallons/(feet of diameter)(feet of head)(# of hours) and the test shall run for 24 hours. 11. The sanitary sewer system shall be tested for infiltration and exfiltration using ASTM C 969. The system shall be broken up into sections when
- necessary to consider groundwater depth, length and elevation differences. The allowable leakage shall be 100 gal/inch of pipe diameter/mile/day. 12. Any testing failure shall require the Contractor to repair or replace the failed section at no additional expense to the contract.

After all testing is complete, and before the system is turned over to the authority having jurisdiction, the system shall be checked to verify it is

- dean and free of dirt, debris and other foreign matter. The Contractor shall clean any sections required at no additional expense to the contract. 14. Grease traps, if required, shall have cast iron lids and shall be installed per manufacturer's requirements. 15. The pipe slope shall always meet the minimum, as listed in Section 33.4 of the Recommended Standards for Wastewater Facilities (Ten State
- 16. Increase size of manhole if in the same horizontal plane there is two areas where the area between two pipes is less than 8 inches or ½ of the circumference is supported by less than ½ of the diameter of the manhole. Inverts shall be smooth cast in place concrete. Caskets between risers shall be rubber per ASTM C 443. Adjustment rings shall be precast concrete 4000 psi and 5 to 8% air entrainment. Inside and outside of

Date: Revisions: Revised per Town Comments 02/18/22

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Store #: Burger King

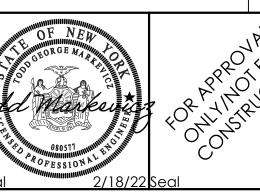1997, 2003, & 2007 Ridge Road

West Seneca, NY 14224

5.B.L. No. 143.06-1-11, 12, & 13

Project Name & Location:

Specifications

Erie County (Town of West Seneca)

Drawing Name: Project No. 21-0239

Date: 04/19/21

Type: Drawn By: SAS

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