

RIM: 636.05 NW 10"INV=626.87 SE 10"INV=626.90 OVAL CMP INV: 631.57 EX. ASPHALT AND STONE PAVEMENT TO BE REMOVED. COORDINATE WITH— INSTALL PROPOSED DETENTION BASIN DURING INITIAL PHASE OF CONSTRUCTION ADJACENT PROPERTY OWNER — TO ACT AS SEDIMENT BASIN. CLEAN TO DESIGN GRADE FOLLOWING STABILIZATION. INSTALL BIORETENTION SOIL AFTER SITE HAS BEEN STABILIZED PARALLEL TO SOUTH LINE OF BE REMOVED -----EX. STONE PAVEMENT TO BE REMOVED CLEAR AND GRUB EX. WOODED AREA WITHIN SILT FENCE BENCHMARK SEE NOTE 6 — LIMITS AS SHOWN VOLLEYBALL AREA 5.49± ACRES NCLUDING HIGHWAY RAMP BLACKTOP CLEAR AND GRUB EX. _WOODED AREA ્રા£QUIPMENT AND MATERIAL WITHIN SILT FENCE _EX. ASPHALT TO 639 BE REMOVED EX. BUILDING TO 80' OF 18" STEEL 363.66 FOUND FOUND IRON IRON ON 0.40'S LINE REBAR 2.82'S 3.77'S FRAME 1.80'N EX. GARAGE AND AGE CONCRETE DRIVE TO BE DEMOLISHED PPROXIMATE LOCATION OF — PERMANENT EASEMENT FOR DRAINAGE

DEMO & EROSION CONTROL PLAN

SCALE: 1"=40'

LIBER 3665 PAGE 472

EDOCION CONTROL NO

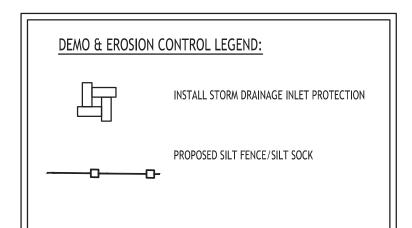
EROSION CONTROL NOTES THE FOLLOWING EROSION CONTROL PROCEDURES SHALL BE ADHERED TO BY THE CONTRACTOR:

- INSTALL TEMPORARY SILT FENCE BARRIERS AS DIRECTED BY THE OWNER AND AT ALL EXISTING STORMWATER CATCH BASINS WITHIN THE WORK AREA TO PREVENT SEDIMENT MIGRATION. ALL SILT FENCE BARRIERS SHALL BE INSTALLED IN ACCORDANCE WITH THE DETAILS
- 2. TOPSOIL TO BE STRIPPED AND STOCKPILED WERE INDICATED TO BE REUSED ON SITE.
- 3. ALL SILT FENCE BARRIERS SHALL BE REPLACED WHEREVER THEY BECOME CLOGGED OR INOPERABLE.
- THE CONTRACTOR SHALL BE RESPONSIBLE FOR MAINTENANCE AND REMOVAL OF TEMPORARY SEDIMENTATION CONTROLS.
- 5. THE CONTRACTOR MUST CONTROL DUST DURING CONSTRUCTION. DURING EARTHWORK OPERATIONS, WATER-SPREADING EQUIPMENT SHALL BE PROVIDED BY THE CONTRACTOR, AND SPREAD WATER AS NECESSARY AND AS DIRECTED BY THE OWNER IN ORDER TO CONTROL
- 6. DIRT OR DEBRIS LEFT ON LOCAL PUBLIC ROADS AS A RESULT OF THIS CONSTRUCTION PROJECT SHALL BE REMOVED AND ROAD SURFACES CLEANED BY THE CONTRACTOR ON A DAILY BASIS.
- 7. ALL DISTURBED AREAS (EXCEPT AREAS TO BE PAVED OR BUILT UPON) SHALL BE TOPSOILED TO A MINIMUM 6" DEPTH AND SEEDED
- IMMEDIATELY AFTER FINE GRADING TAKES PLACE AND AS SOON AS PHYSICALLY POSSIBLE.

 8. THE CONTRACTOR IS RESPONSIBLE FOR THE MAINTENANCE OF DOWNSTREAM STORM SEWERS, DITCHES, AND CULVERTS. SILT BUILDUP FOUND TO BE A RESULT OF THIS SITE CONSTRUCTION WORK SHALL BE REMOVED FROM DOWNSTREAM CULVERTS BY THE CONTRACTOR AT NO ADDITIONAL EXPENSE TO THE OWNER OR THE TOWN/CITY.
- 9. ALL SOIL EROSION AND SEDIMENT CONTROL DEVICES AND MATERIALS SHALL BE IN PLACE PRIOR TO BEGINNING EARTHWORK OPERATIONS AND SHALL BE MAINTAINED UNTIL THE NEW SLOPES ARE STABILIZED WITH SEEDING AND/OR SLOPE PROTECTION, AS DIRECTED BY THE ENGINEER.
- 10. INSTALL TEMPORARY SILT FENCE AROUND THE BASE OF STOCKPILES.
- 11. THE PROFESSIONAL CERTIFYING COMPLIANCE TO NYSDEC PHASE II STORMWATER REGULATION REQUIREMENTS MUST INSPECT AT A MINIMUM WEEKLY AND SHALL PROVIDE THESE INSPECTION REPORT WITH A WRITTEN CERTIFICATION OF CONSTRUCTION COMPLIANCE TO THE TOWN OF WEST SENECA WEEKLY.
- 12. THE ENGINEER OF RECORD FOR THIS PROJECT CERTIFIES THAT THESE DESIGN PLANS MEET THE REQUIREMENTS AND ARE IN COMPLIANCE WITH THE NEW YORK STORMWATER MANAGEMENT DESIGN MANUAL AND NYSDEC PHASE II STORMWATER REGULATION REQUIREMENTS. DUE TO SOIL DISTURBANCE BEING GREATER THAN ONE ACRE, A NYSDEC SPDES PERMIT MUST BE OBTAINED BEFORE ANY ON-SITE DISTURBANCE


<u>NO</u>

- 1. THE CONTRACTOR SHALL TAKE PRECAUTIONS TO PROTECT THOSE ITEMS TO REMAIN, SUCH AS TREES, PROPERTY CORNER PINS, UTILITY POLES, VALVES, HYDRANTS, CURBS, MANHOLES AND CATCH BASINS.
- 2. TEMPORARY SILT FENCE AND STRAW BALES TO BE INSTALLED AS DIRECTED BY THE OWNERS FIELD REPRESENTATIVE. MAINTAIN UNTIL VEGATATION IS ESTABLISHED AND PAVEMENT IS INSTALLED.
- 3. FOR THOSE STRUCTURES TO BE DEMOLISHED, ALL EXISTING UTILITY SERVICES SHALL BE ABANDONED IN ACCORDANCE WITH LOCAL REGULATIONS, ALL METERS SHALL BE RETURNED TO PROPER OWNERS.
- 4. THE CONTRACTOR SHALL INSTALL STABILIZED CONSTRUCTION ENTRANCES WHERE ACCESSING THE SITE FROM PAVED
- 5. THE CONTRACTOR SHALL INSTALL TEMPORARY TRAFFIC CONTROL DEVICES IN ACCORDANCE WITH NYS M.U.T.C.D. STANDARDS PRIOR TO STARTING WORK.



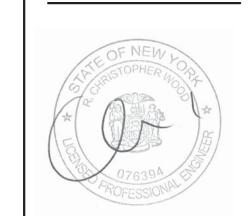NOTE: BOUNDARY AND TOPOGRAPHIC INFORMATION PROVIDED BY OTHERS, CARMINA WOOD DESIGN ASSUMES NO RESPONSIBILITY FOR ITS ACCURACY.

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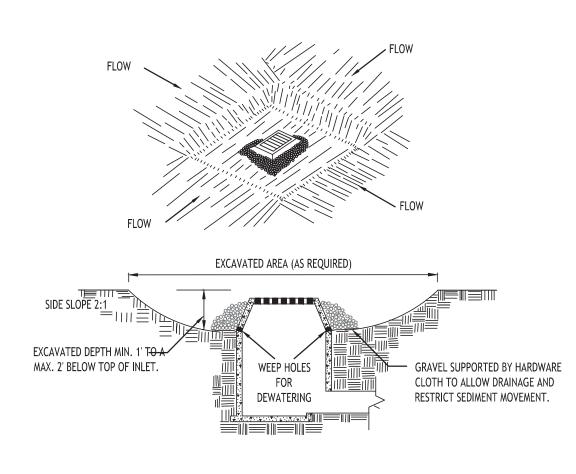
Demo & Erosion
Control Plan

Date:
Drawn By:
Scale:

6/21/23 A. Pandolfe

As Noted

C-001

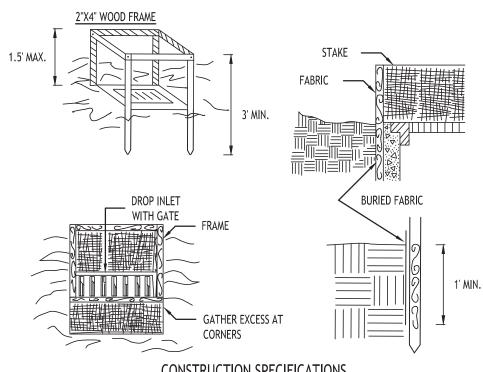


CONSTRUCTION SPECIFICATIONS

- 1. CLEAR THE AREA OF ALL DEBRIS THAT WILL HINDER EXCAVATION.
- 2. GRADE APPROACH TO THE INLET UNIFORMLY AROUND THE BASIN.
- WEEP HOLES SHALL BE PROTECTED BY GRAVEL.
- 4. UPON STABILIZATION OF CONTRIBUTING DRAINAGE AREA, SEAL WEEP HOLES, FILL BASIN WITH STABLE SOIL TO FINAL GRADE, COMPACT IT PROPERLY AND STABILIZE WITH PERMANENT SEEDING.

MAXIMUM DRAINAGE AREA 1 ACRE

INLET PROTECTION DETAIL 1 NOT TO SCALE



CONSTRUCTION SPECIFICATIONS

- 1. FILTER FABRIC SHALL HAVE AN EOS OF 40-85. BURLAP MAY BE USED FOR SHORT TERM APPLICATIONS.
- 2. CUT FABRIC FROM A CONTINUOUS ROLL TO ELIMINATE JOINTS. IF JOINTS ARE NEEDED THEY WILL BE OVERLAPPED TO
- 3. STAKE MATERIALS WILL BE STANDARD 2" x 4" WOOD OR EQUIVALENT. METAL WITH A MINIMUM LENGTH OF 3 FEET.
- 4. SPACE STAKES EVENLY AROUND INLET 3 FEET APART AND DRIVE A MINIMUM 18 INCHES DEEP. SPANS GREATER THAN 3 FEET MAY BE BRIDGED WITH THE USE OF WIRE MESH BEHIND THE FILTER FABRIC FOR SUPPORT.

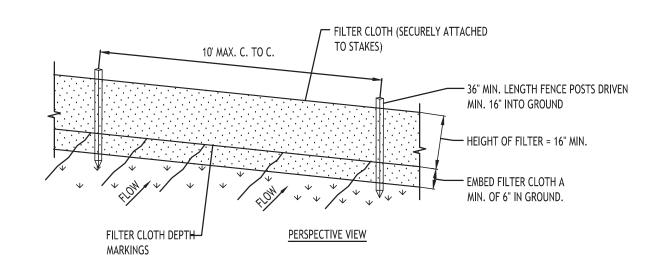
5. FABRIC SHALL BE EMBEDDED 1 FOOT MINIMUM BELOW GROUND AND BACKFILLED. IT SHALL BE SECURELY FASTENED TO

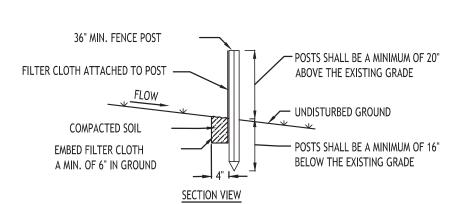
THE STAKES AND FRAME. 6. A 2" x 4" WOOD FRAME SHALL BE COMPLETED AROUND THE CREST OF THE FABRIC FOR OVER FLOW STABILITY.

MAXIMUN DRAINAGE AREA 1 ACRE

INLET PROTECTION DETAIL 2

NOTE: INSTALL ONE OF THE INLET PROTECTION OPTIONS SHOWN PRIOR TO CONSTRUCTION






CONSTRUCTION SPECIFICATIONS

- 1. WOVEN FENCE TO BE FASTENED SECURELY TO FENCE POSTS WITH WIRE TIES OR STAPLES. POSTS SHALL BE STEEL EITHER "T" OR "U" TYPE OR HARDWOOD.
- 2. WHEN TWO SECTIONS OF FILTER CLOTH ADJOIN EACH OTHER THEY SHALL BE OVER-LAPPED BY SIX INCHES AND FOLDED. FILTER CLOTH SHALL BE EITHER FILTER X, MIRAFI 100X, STABILINKA T140N, OR APPROVED EQUIVALENT.
- 3. MAINTENANCE SHALL BE PERFORMED AS NEEDED AND MATERIAL REMOVED WHEN "BULGES" DEVELOP IN THE SILT FENCE.

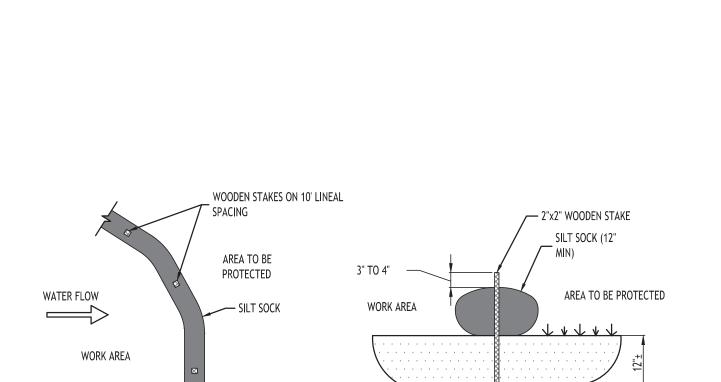SILT FENCE DETAIL NOT TO SCALE



STONE & BLOCK PLAN VIEW

FINE GRAVEL FACE

(1'MIN. THICKNESS)

DRAWINGS.

MAXIMUM DRAINAGE AREA 1 ACRE

TEMPORARY SEDIMENT POOL

TEMPORARY SEDIMENT POOL

INLET AND BLOCKS SHALL BE PLACED AGAINST INLET FOR SUPPORT.

CONSTRUCTION SPECIFICATIONS

2. HARDWARE CLOTH OR 1/2" WIRE MESH SHALL BE PLACED OVER BLOCK OPENINGS TO SUPPORT STONE.

1. LAY ONE BLOCK ON EACH SIDE OF THE STRUCTURE ON ITS SIDE FOR DEWATERING. FOUNDATION SHALL BE 2 INCHES MINIMUM BELOW REST OF

4. FOR STONE STRUCTURES ONLY, A 1 FOOT THICK LAYER OF THE FILTER STONE WILL BE PLACED AGAINST THE 3 INCH STONE AS SHOWN ON THE

3. USE CLEAN STONE OR GRAVEL 1/2-3/4 INCH IN DIAMETER PLACED 2 INCHES BELOW TOP OF THE BLOCK ON A 2:1 SLOPE OR FLATTER.

INLET PROTECTION DETAIL 3

STONE & BLOCK DETAIL

DROP INLET WITH GATE

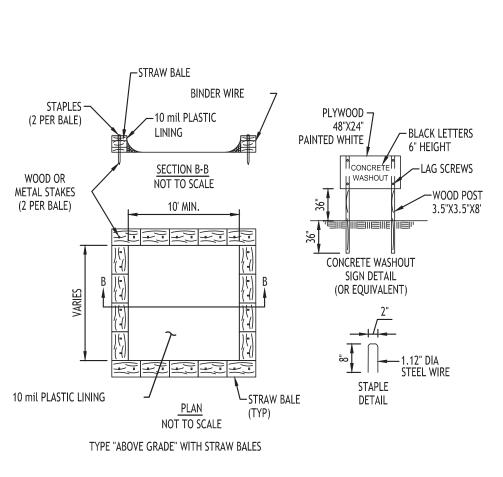
PLAN VIEW

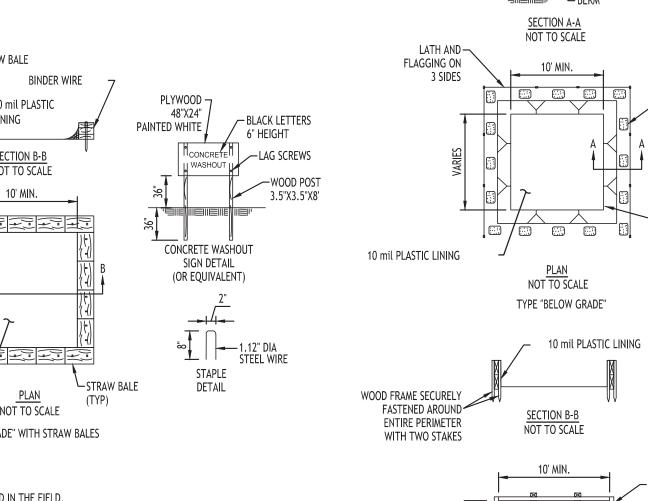
CONTRACTOR SHALL INSPECT AND MAINTAIN SILT SOCK AS NEEDED DURING THE DURATION OF CONSTRUCTION PROJECT.

CONTRACTOR SHALL REMOVE SEDIMENT COLLECTED AT THE BASE OF THE SILT SOCK WHEN IT HAS REACHED $\frac{1}{2}$ OF THE EXPOSED HEIGHT OF THE SILT SOCK. ALTERNATIVELY, RATHER THAN CREATE A SOIL DISTURBING ACTIVITY, THE ENGINEER MAY CALL FOR ADDITIONAL SILT SOCK TO BE ADDED AT AREAS OF HIGH SEDIMENTATION, PLACED IMMEDIATELY ON TOP OF THE EXISTING SEDIMENT LADEN SILT SOCK.

SECTION VIEW


SILT SOCK DETAIL NOT TO SCALE






10 mil PLASTIC LINING

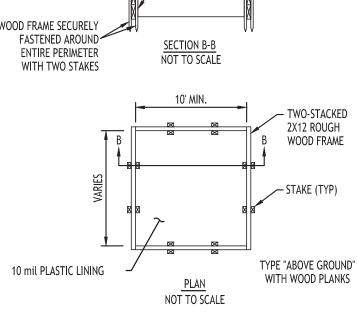- ACTUAL LAYOUT TO BE DETERMINED IN THE FIELD.
- A CONCRETE WASHOUT SIGN SHALL BE INSTALLED WITHIN 30' OF THE TEMPORARY CONCRETE WASHOUT FACILITY.
- 3. MATERIALS USED TO CONSTRUCT TEMPORARY CONCRETE WASHOUT FACILITIES SHALL BE REMOVED FROM THE SITE OF THE WORK AND DISPOSED OF OR RECYCLED.
- 4. HOLES, DEPRESSIONS OR OTHER GROUND DISTURBANCE CAUSED BY THE REMOVAL OF THE TEMPORARY CONCRETE WASHOUT FACILITIES SHALL BE BACKFILLED, REPAIRED, AND STABILIZED TO PREVENT




CONCRETE WASHOUT DETAIL NOT TO SCALE

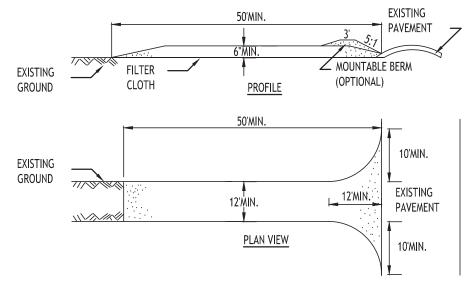

CONSTRUCTION SPECIFICATIONS

- 1. STONE SIZE USE 2" STONE, OR RECLAIMED OR RECYCLED CONCRETE EQUIVALENT.
- 2. LENGTH NOT LESS THAN 50 FEET (EXCEPT ON A SINGLE RESIDENCE LOT WHERE A 30 FOOT MINIMUM LENGTH WOULD
- 3. THICKNESS NOT LESS THAN SIX (6) INCHES.
- 4. WIDTH TWELVE (12) FOOT MINIMUM, BUT NOT LESS THAN THE FULL WIDTH AT POINTS WHERE INGRESS OR EGRESS OCCURS. TWENTY-FOUR (24) FOOT IF SINGLE ENTRANCE TO SITE.
- 5. FILTER CLOTH WILL BE PLACED OVER THE ENTIRE AREA PRIOR TO PLACING OF STONE.
- 6. SURFACE WATER ALL SURFACE WATER FLOWING OR DIVERTED TOWARD CONSTRUCTION ENTRANCES SHALL BE PIPED ACROSS THE ENTRANCE. IF PIPING IS IMPRACTICAL, A MOUNTABLE BERM WITH 5:1 SLOPES WILL BE PERMITTED.
- 7. MAINTENANCE THE ENTRANCE SHALL BE MAINTAINED IN A CONDITION WHICH WILL PREVENT TRACKING OR FLOWING OF SEDIMENT ONTO PUBLIC RIGHTS-OF-WAY, ALL SEDIMENT SPILLED, DROPPED, WASHED OR TRACTED ONTO PUBLIC RIGHTS-OF-WAY MUST BE REMOVED IMMEDIATELY.
- 8. WHEN WASHING IS REQUIRED, IT SHALL BE DONE ON A AREA STABILIZED WITH STONE AND WHICH DRAINS INTO AN APPROVED SEDIMENT TRAPPING DEVICE.
- 9. PERIODIC INSPECTION AND NEEDED MAINTENANCE SHALL BE PROVIDED AFTER EACH RAIN.

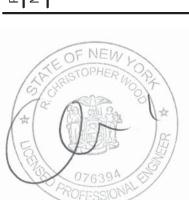STABILIZED CONSTRUCTION ENTRANCE DETAIL NOT TO SCALE




DRAWING NAME: Demo & Erosion **Control Details**

Drawn By: Scale: DRAWING NO.

6/21/23

A. Pandolfe

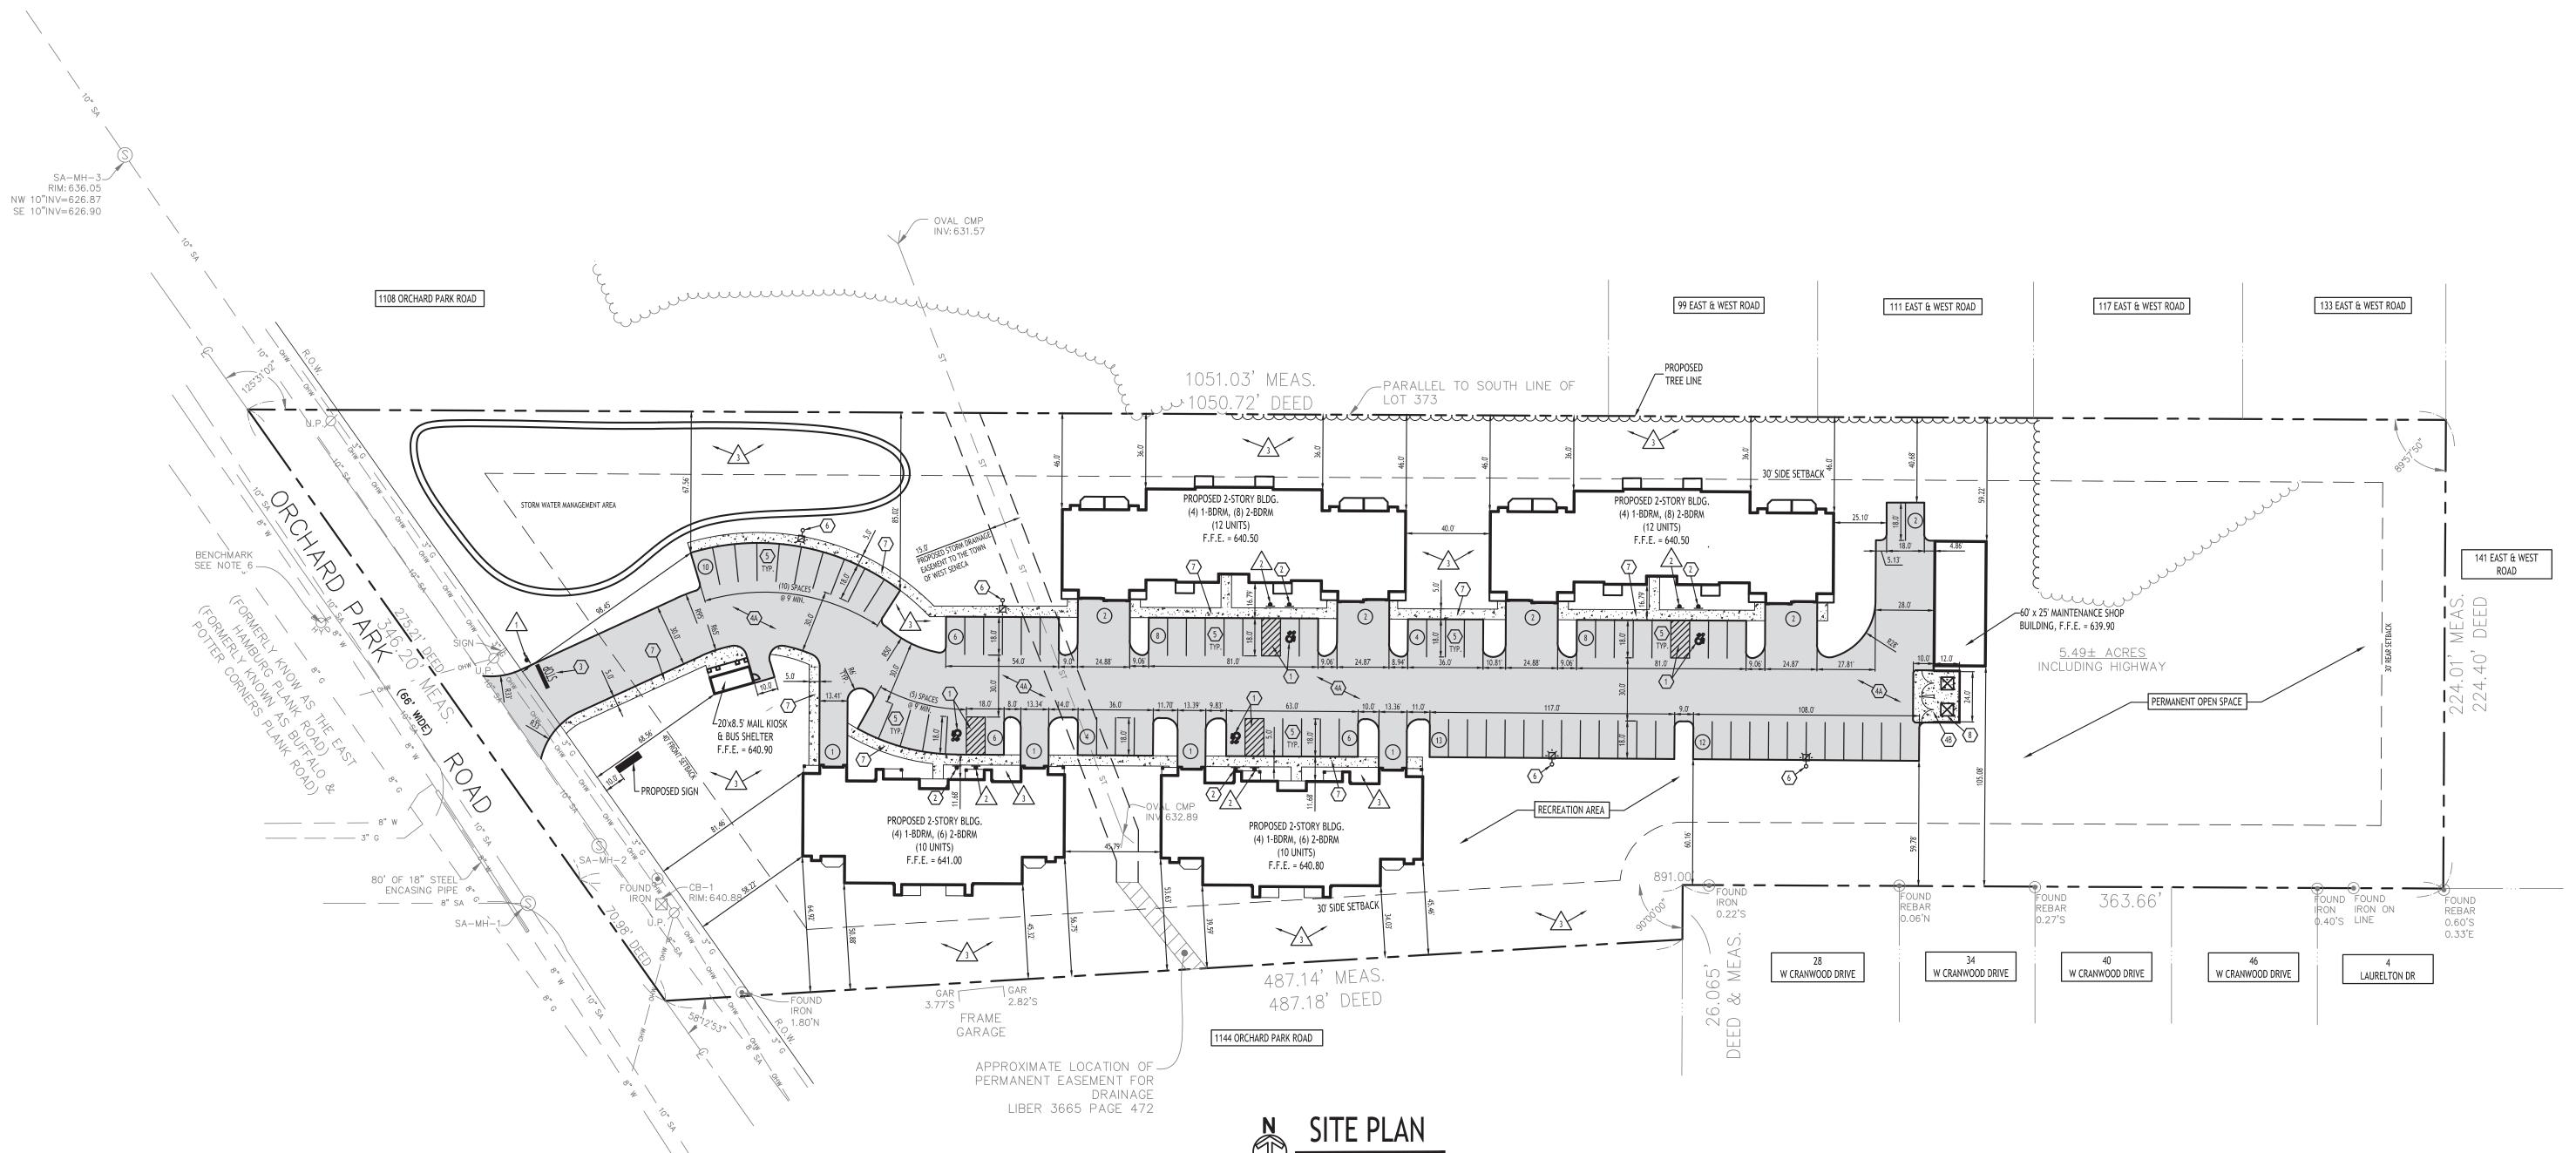As Noted



SITE DATA - ZONED R50 (S) - 1130 & 1140 ORCHARD PARK RD - 5.21 ACRES

MULTI-FAMILY ALLOWED BY SPECIAL PERMIT

MIN. LOT WIDTH = 50 FT FOR FIRST DWELLING UNIT, PLUS 10 FT FOR EACH ADDITIONAL UNIT NEED NOT EXCEED 100 FT

DENSITY CALCULATION

ADDITIONAL DWELLING UNIT

ALLOWED NUMBER OF UNITS:

TOTAL ALLOWED UNITS = 45 UNITS

REQ'D = 8,000 SF FOR FIRST DWELLING UNIT, PLUS 5,000 FOR EACH

1ST UNIT: 227,092 SF - 8,000 SF = 219,092 SF REMAINING

ADDITIONAL UNITS: 219,092 SF / 5,000 SF = 44 UNITS

MIN. LOT AREA = 8,000 SF FOR FIRST DWELLING UNIT, PLUS 5,000 FOR EACH ADDITIONAL DWELLING UNIT

FRONT SETBACK = 40 FT SIDE SETBACK = 30 FT MIN. OR A DISTANCE EQUAL TO $\frac{1}{2}$ HGT. OF SUCH BUILDING, WHICHEVER IS GREATER

REAR SETBACK = 30 FT

MAXIMUM BUILDING HEIGHT = 40 FT (MULTI-FAMILY)

DRIVEWAY: 30 FT WIDE REQUIRED FOR MULTI-FAMILY

DWELLING SIZE: 500 SF EACH MULTI-FAMILY UNIT

GROUP DWELLING: NO BUILDING SHALL BE NEARER ANY OTHER PRINCIPAL STRUCTURE THAN A DISTANCE EQUAL TO THE AVERAGE HEIGHT OF SUCH

PARKING CALCULATION: MULTI-FAMILY:

REQ'D = 2 SPACES PER UNIT + 10 VISITORS (26 to 50 UNITS) REQ'D = 2 SPACES x 44 UNITS + (10) = 98 SPACES

TOTAL PROVIDED = 86 SPACES + 12 GARAGE SPACES = 98 SPACES

DETAIL LEGEND SEE SITE DETAIL SHEET

1 HANDICAPPED PAVEMENT MARKINGS

(2) HANDICAPPED PARKING SIGN

3 STOP BAR

4A STANDARD DUTY ASPHALT

4B EXTERIOR CONCRETE SLAB ON GRADE 5 90° PARKING STALL

6 LIGHT POLE FOUNDATION

7 CONCRETE SIDEWALK

(8) DUMPSTER ENCLOSURE

NOTE LEGEND

1 INSTALL STOP SIGN - M.U.T.C.D. SIGN NO. R1-1B

│ INSTALL "NO PARKING" SIGN, M.U.T.C.D. SIGN NO. P1-1C

/3\ LANDSCAPED AREA - SEE LANDSCAPE PLAN, IF NO PLANTINGS, INSTALL TOPSOIL & SEED

PROPOSED CONCRETE CURB PROPOSED SIDEWALK / CONCRETE PAD INSTALL ALL MATERIALS TO MANUFACTURER'S RECOMMENDATIONS AND BEST STANDARDS OF TRADE INVOLVED. NUMBER OF PARKING SPACES SUBSTITUTIONS SHALL BE MADE ONLY WITH OWNER'S APPROVAL AND BE OF EQUIVALENT QUALITY TO WHAT IS SPECIFIED. WORK SHALL BE COMPLETED IN STRICT ACCORDANCE WITH ALL LOCAL CODES AND OSHA SAFETY RULES AND REGULATIONS. PROPOSED SIGN

SITE LEGEND

PROPERTY LINE

PROPOSED STANDARD DUTY

NOTE: BOUNDARY AND TOPOGRAPHIC INFORMATION PROVIDED BY OTHERS,

CARMINA WOOD DESIGN ASSUMES NO RESPONSIBILITY FOR ITS ACCURACY.

ASPHALT PAVEMENT

PROPOSED LIGHT POLE

4. VERIFY ALL EXISTING CONDITIONS AND DIMENSIONS AT THE SITE. NOTIFY OWNER & ENGINEER OF DISCREPANCIES IN CONDITIONS SHOWN ON DRAWINGS PRIOR TO PROCEEDING WITH THE WORK. 5. CONTRACTOR SHALL BE RESPONSIBLE FOR PROTECTION OF ANY EXISTING STRUCTURES TO REMAIN AND ANY FINISH MATERIAL INSTALLED WHILE

WORKING ON OTHER COMPONENTS. 6. CONTRACTOR SHALL KEEP JOB FREE OF DEBRIS AND MAKE FINAL CLEANUP TO SATISFACTION OF OWNER. 7. CONTRACTOR SHALL ASCERTAIN THE LOCATION OF ALL UTILITIES PRIOR TO CONSTRUCTION SO THAT THIS WORK WILL NOT DISTURB EXISTING LINES AND/OR INSTALLATIONS. COORDINATE ALL WORK WITH THE APPLICABLE UTILITY COMPANIES.

8. CONTRACTOR SHALL OBTAIN AND PAY FOR ALL REQUIRED PERMITS NECESSARY TO PERFORM THE WORK. 9. ALL REASONABLE MEASURES SHALL BE TAKEN TO PROTECT EXISTING TREES WHICH ARE TO BE PRESERVED FROM ALL POSSIBLE TYPES OF ROOT, TRUNK, AND LIMB DAMAGE; INCLUDING BUT NOT LIMITED TO, RETAINING WALLS WHICH PREVENT FILLING ON TOP OF ROOTS OR EXCAVATING TREE ROOTS.

GENERAL NOTES:

1. ALL RADII SHALL BE 3'-0" UNLESS OTHERWISE NOTED.

2. ALL DISTURBED AREAS: SHALL HAVE 4" MIN. OF TOPSOIL & SEED.

3. ALL DIMENSIONS FROM PROPERTY LINES SHALL BE MEASURED PERPENDICULAR TO THE PROPERTY LINE. 4. CENTER ENTRANCE SIDEWALKS ON DOOR OPENINGS.

5. BUILDING DIMENSIONS ARE APPROXIMATE, REFER TO ARCHITECTURAL DRAWINGS FOR LAYOUT DIMENSIONS.



DRAWING NAME Site Plan

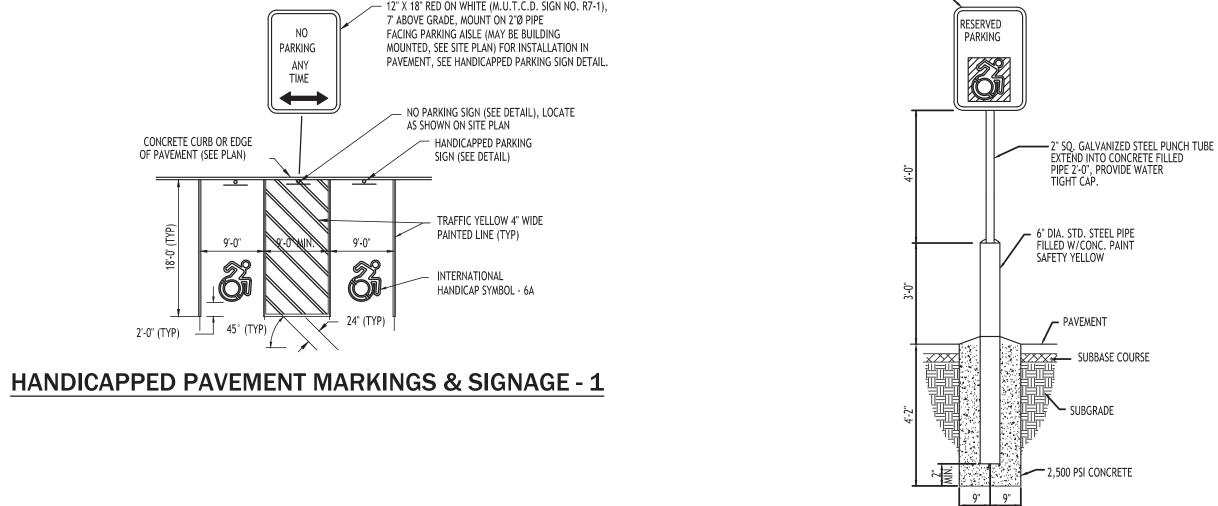
Drawn By:

6/21/23

C. Wood

As Noted

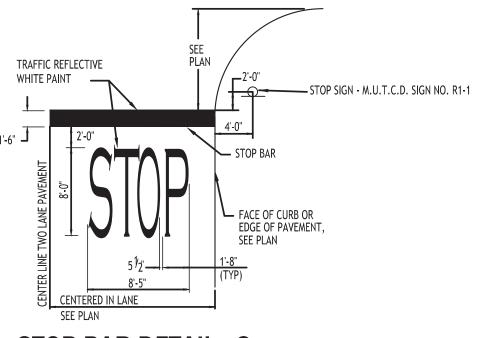
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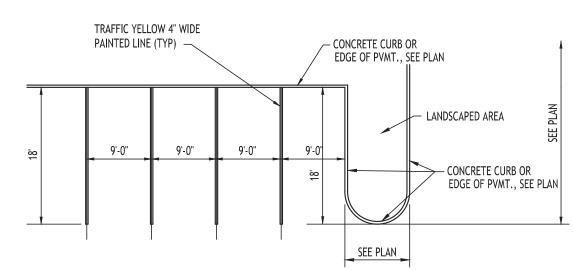
HANDICAPPED PARKING SIGN - 2

INSTALLED IN PAVEMENT

HANDICAPPED PARKING SIGN M.U.T.C.D. SIGN NO. P4-6C







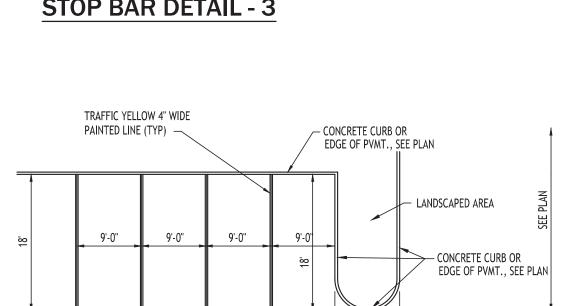
90° PARKING STALL LAYOUT - 5

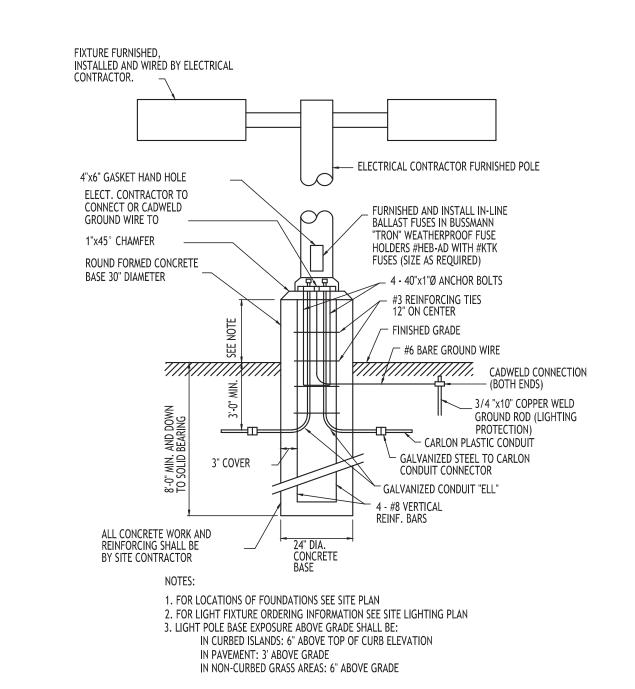
3. CHAIN LINK FENCE FABRIC SHALL BE 2" MESH, 9 GAUGE, ZINC COATED STEEL CORE WIRE. INSTALL MESH WITH HOOK BOLTS

4. DOUBLE GATE LATCH TO BE FORKED TYPE CAPABLE OF RETAINING GATE IN CLOSED POSITION AND HAVE PROVISION FOR PAD

AND TENSION BARS ON ALL 4 SIDES, ATTACH AT 15" MAX.

LOCK. LATCH SHALL BE OPERABLE FROM EITHER SIDE OF GATE.





PAVEMENT WIDTH VARIES SEE SITE PLAN

_1" ASPHALT TOP COURSE, TYPE 7

- 2" ASPHALT BINDER COURSE, TYPE 3

(N.Y.S.D.O.T. ITEM 304.02)

►8" SUBBASE COURSE MATERIAL, TYPE 1

► GRADED AND COMPACTED PAVEMENT SUBGRADE

STANDARD DUTY ASPHALT SECTION - 4A

PAVEMENT WIDTH VARIES SEE SITE PLAN

CONTROL JOINTS @ 10' O.C. BOTH WAYS. SEAL

6"x6" 10/10 WELDED WIRE FABRIC
(3" BELOW TOP OF SLAB)

//>//>//>/ (NYSDOT ITEM 304.02)

GRADED AND COMPACTED PAVEMENT SUBGRADE

EXTERIOR CONCRETE

SLAB-ON-GRADE SECTION - 4B

NOTE: CONCRETE PAVEMENT MATERIAL SHALL CONFORM TO NYSDOT STANDARD SPECIFICATION 501 AND CONSTRUCTION METHODS SHALL CONFORM TO NYSDOT STANDARD SPECIFICATION 502-3.

ALL JOINTS WITH ASPHALT CEMENT, NYSDOT

TO SUBBASE (

✓ NONWOVEN GEOTEXTILE FABRIC

MIRAFI 600X OR APPROVED EQUAL (IF

WARRANTED BY SITE CONDITIONS DURING CONSTRUCTION)

(N.Y.S.D.O.T. ITEM 403.18)

(N.Y.S.D.O.T. ITEM 403.13)

NOTE: CONSTRUCTION METHODS FOR ASPHALT PAVEMENT SHALL

- 6" CONCRETE SLAB (MIN. 4,000 PSI)

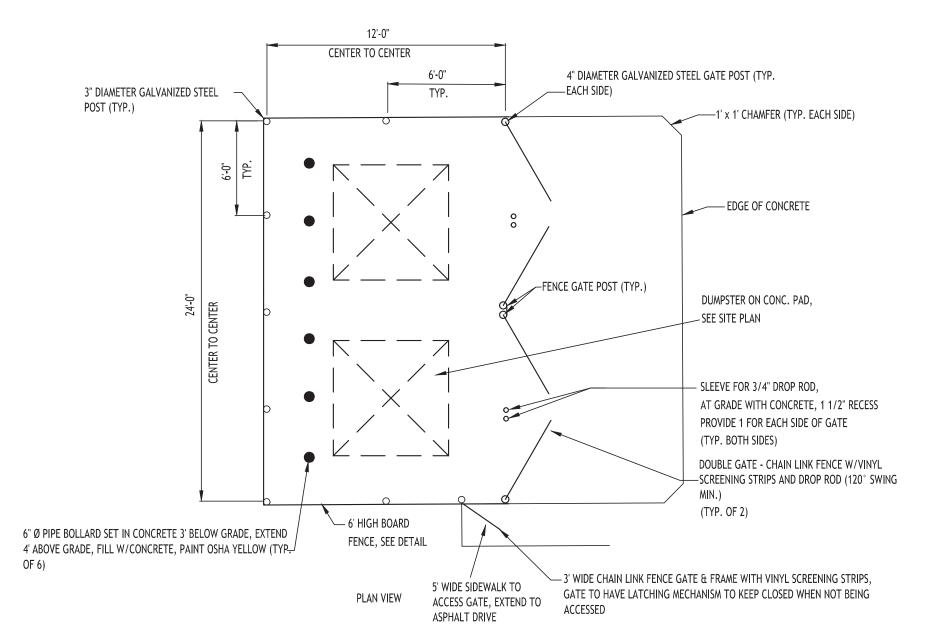
SPECIFICATIONS 702-0700

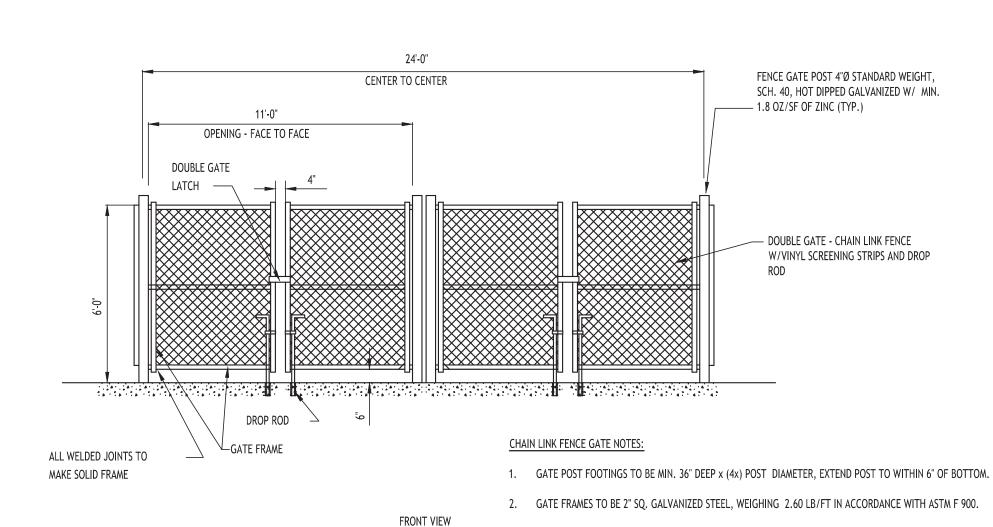
STANDARD SPECIFICATION 304-3.

CONFORM TO NYSDOT STANDARD SPECIFICATION 401-3, WITH


SUBBASE CONSTRUCTION METHODS CONFORMING TO NYSDOT


LIGHT POLE FOUNDATION - 6






DUMPSTER ENCLOSURE - 8

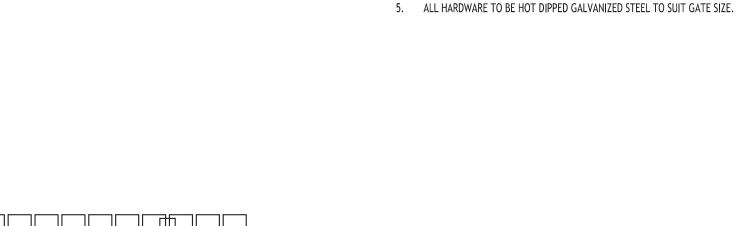

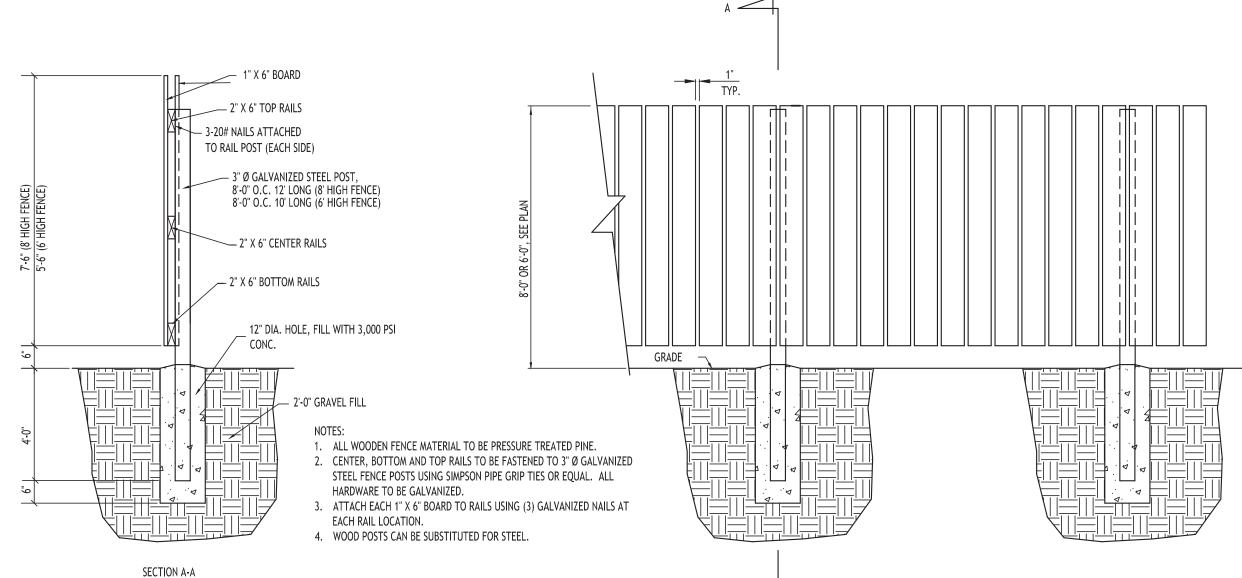



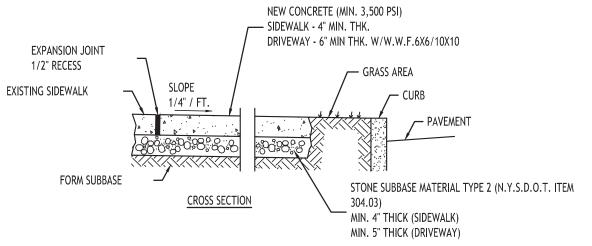

NOTES:

1. CONTROL JOINTS TO BE AT 5'-0" O.C., BOTH WAYS WHERE APPLICABLE. SEE SPECIFICATIONS FOR FURTHER JOINT REQUIREMENTS NYSDOT 702-0700.

- 2. CONCRETE SIDEWALK AND DRIVEWAY MATERIAL SHALL CONFORM TO NYSDOT STANDARD SPECIFICATION 501 AND CONSTRUCTION METHODS SHALL CONFORM TO NYSDOT STANDARD SPECIFICATION 608-3.
- 3. SUBBASE GRADE SHALL FOLLOW THE PROPOSED GRADE OF THE SIDEWALK AND SLOPE AWAY FROM BUILDING WHERE APPLICABLE, PROVIDE CONTINUOUS STONE PATH TO CURB UNDERDRAIN WHERE PROVIDED.
- 4. FULL DEPTH EXPANSION JOINTS SHALL BE INSTALLED EVERY 20' O.C., BOTHWAYS WHERE APPLICABLE. SEE
- SPECIFICATIONS FOR FURTHER JOINT REQUIREMENTS NYSDOT 702-0700.
- 5. SEE CURB DETAIL FOR DOWLING REQUIREMENTS WHERE ABUTTING CURB.
- 6. INSTALL 6" LONG #3 DOWELS @ 12" O.C. WHERE SIDEWALK ABUTS A BUILDING WALL AT AN ENTRANCE, THICKEN SIDEWALK TO 6" AT BUILDING WALL AND INSTALL DOWEL CENTERED IN THE 6" DEPTH. DOWELS AND THICKENING OF SIDEWALK SHALL EXTEND 18" EITHER SIDE OF ENTRANCE.
- 7. INSTALL 1/2" PREMOLDED EXPANSION JOINT WITH BACKER ROD & SEALANT WHERE SIDEWALK ABUTS BUILDING OR OTHER STRUCTURE.

CONCRETE SIDEWALK - 7

DRAWING NAME Site Details

Drawn By: DRAWING NO.

6/21/23

As Noted

A. Pandolfe

DRAWING NAME:
Grading Plan

Date:
Drawn By:
Scale:
DRAWING NO.

6/21/23

A. Pandoilfe

Scale: As Noted

DRAWING NO.

C-200

Project No: 22.128

NOTE: BOUNDARY AND TOPOGRAPHIC INFORMATION PROVIDED BY OTHERS, CARMINA WOOD DESIGN ASSUMES NO RESPONSIBILITY FOR ITS ACCURACY.

40 0 40 80Ft.
40'

——101 **——**

100.80

TC 100.50 BC 100.00

■ CB

PROPOSED GRADING LEGEND

PROPOSED TOP/BOTTOM OF CURB ELEV.

PROPOSED CONTOUR

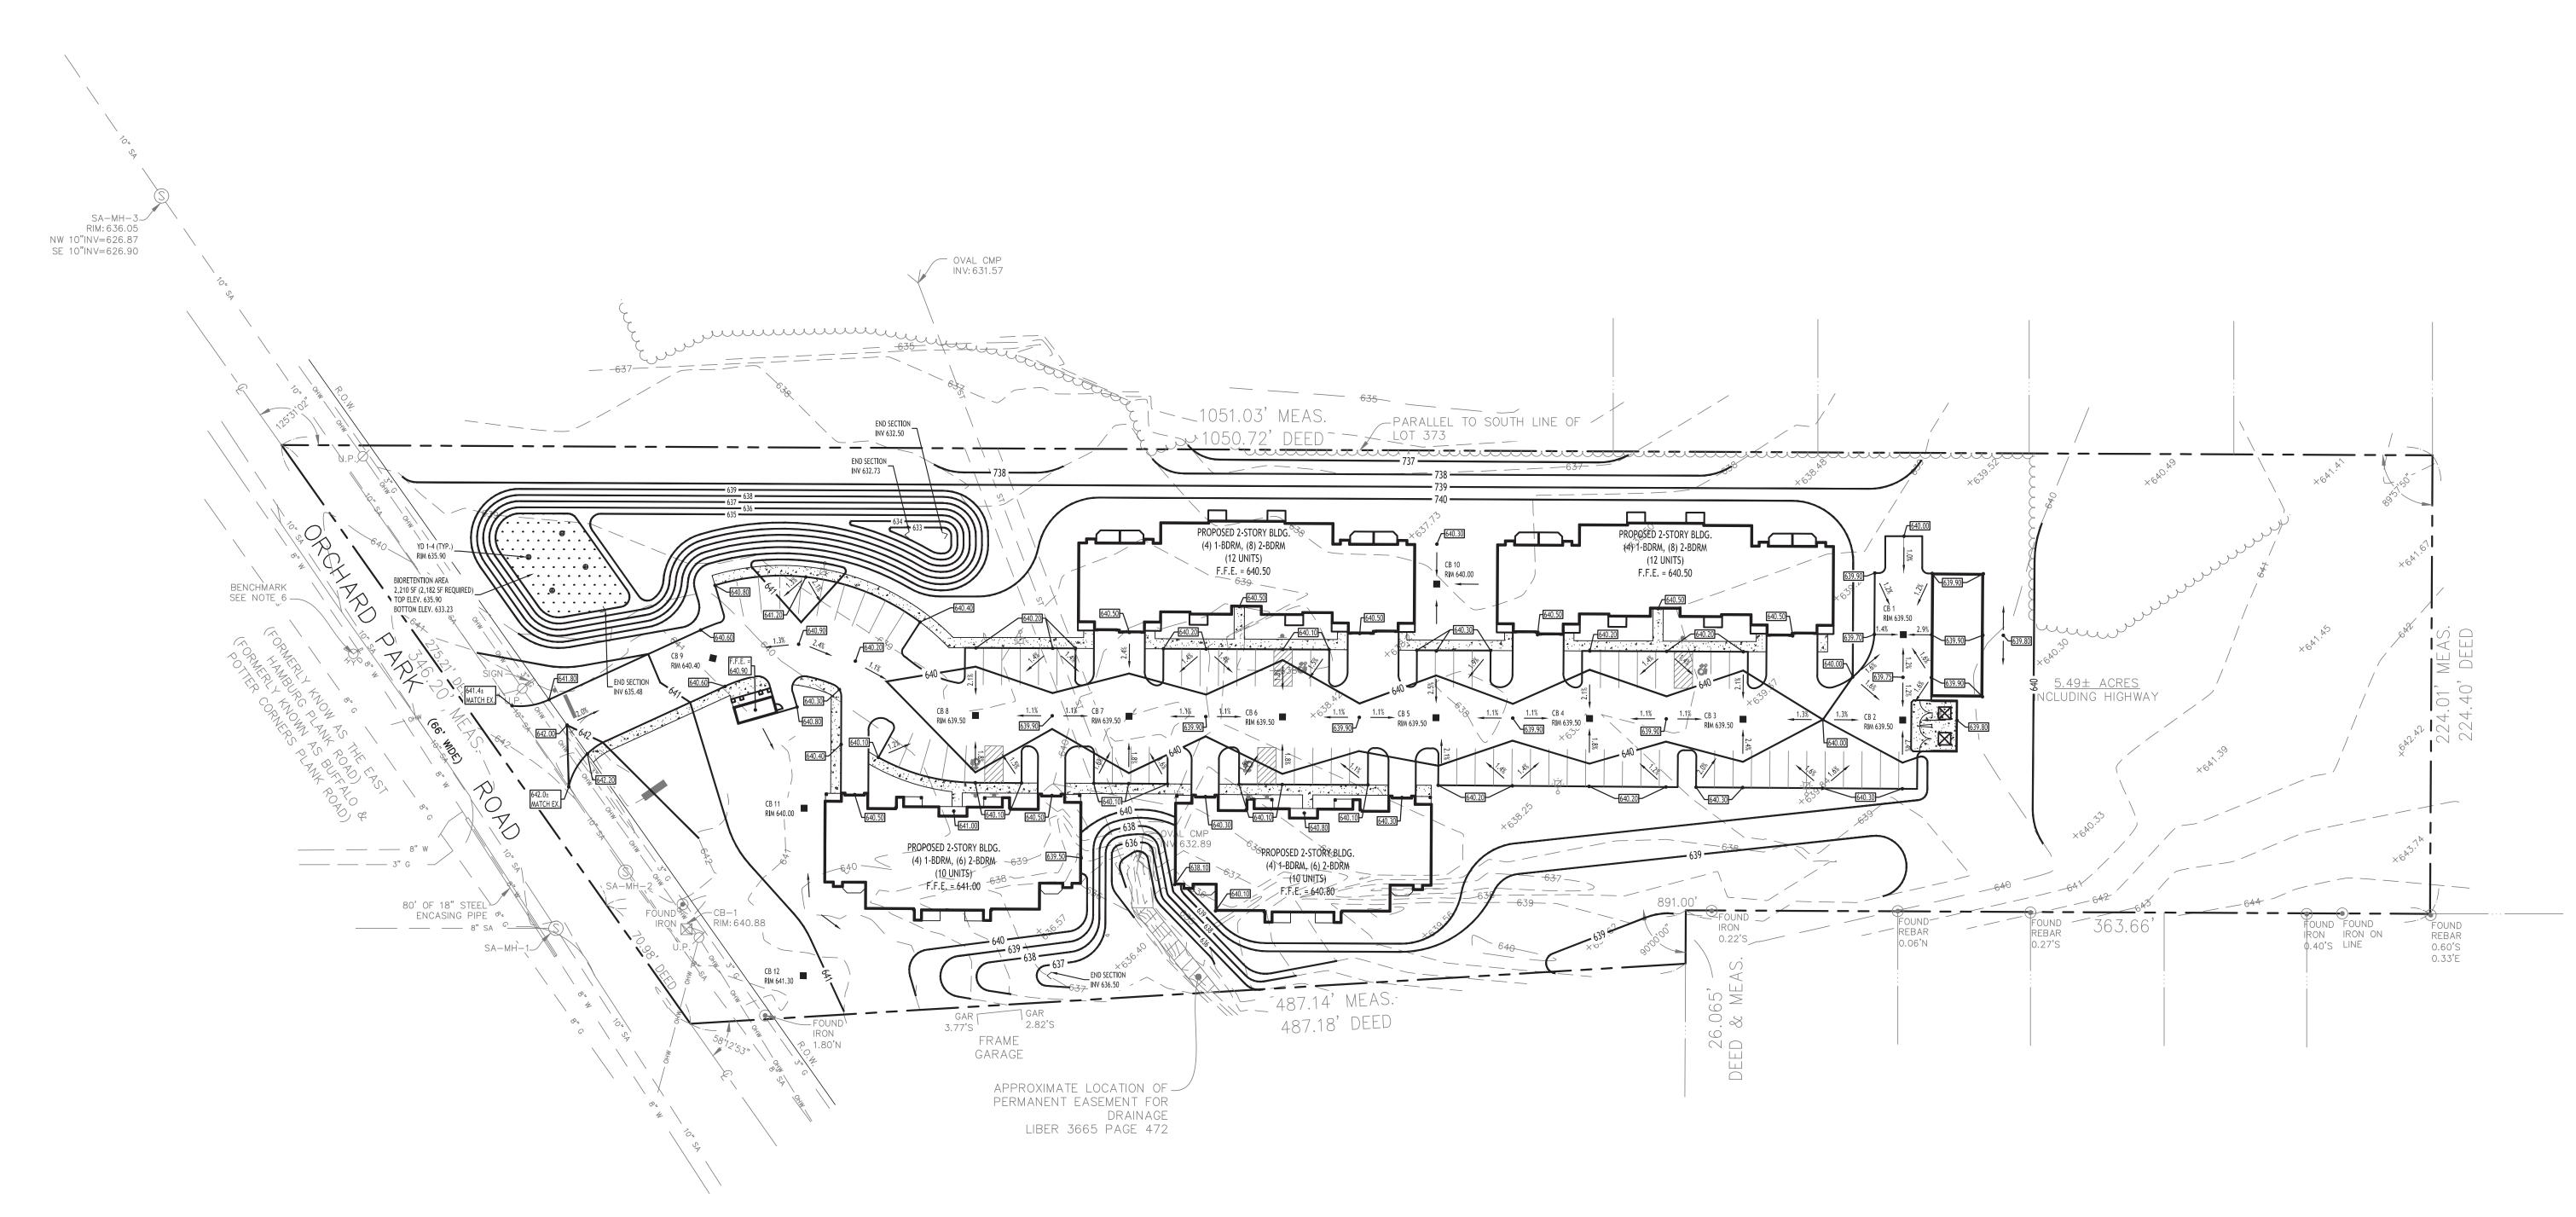
PROPOSED SPOT ELEVATION

PROPOSED CATCH BASIN

PAVEMENT/GROUND SLOPE

PROPOSED YARD DRAIN

PROPOSED MANHOLE





PROPOSED UTILITY LEGEND

— 6" SA —

—_1" W —__

■ CB

 \otimes YD

MH

PROPOSED STORM SEWER

PROPOSED SANITARY SEWER

PROPOSED WATERLINE

PROPOSED CATCH BASIN

PROPOSED YARD DRAIN

PROPOSED MANHOLE

PROPOSED HYDRANT ASSEMBLY

NOTE: FOR PROPOSED VALVE BOXES, CLEANOUTS, ETC., INSTALL A 3,000 PSI CONCRETE COLLAR AROUND THE ITEM AT GRADE. THE COLLAR SHALL BE A MINIMUM OF 6" WIDER, ON ALL SIDES, THAN THE BOX, CLEANOUT, ETC. THE COLLAR SHALL BE A MINIMUM OF 6" THICK.

NOTE: BOUNDARY AND TOPOGRAPHIC INFORMATION PROVIDED BY OTHERS, CARMINA WOOD DESIGN ASSUMES NO RESPONSIBILITY FOR ITS ACCURACY.

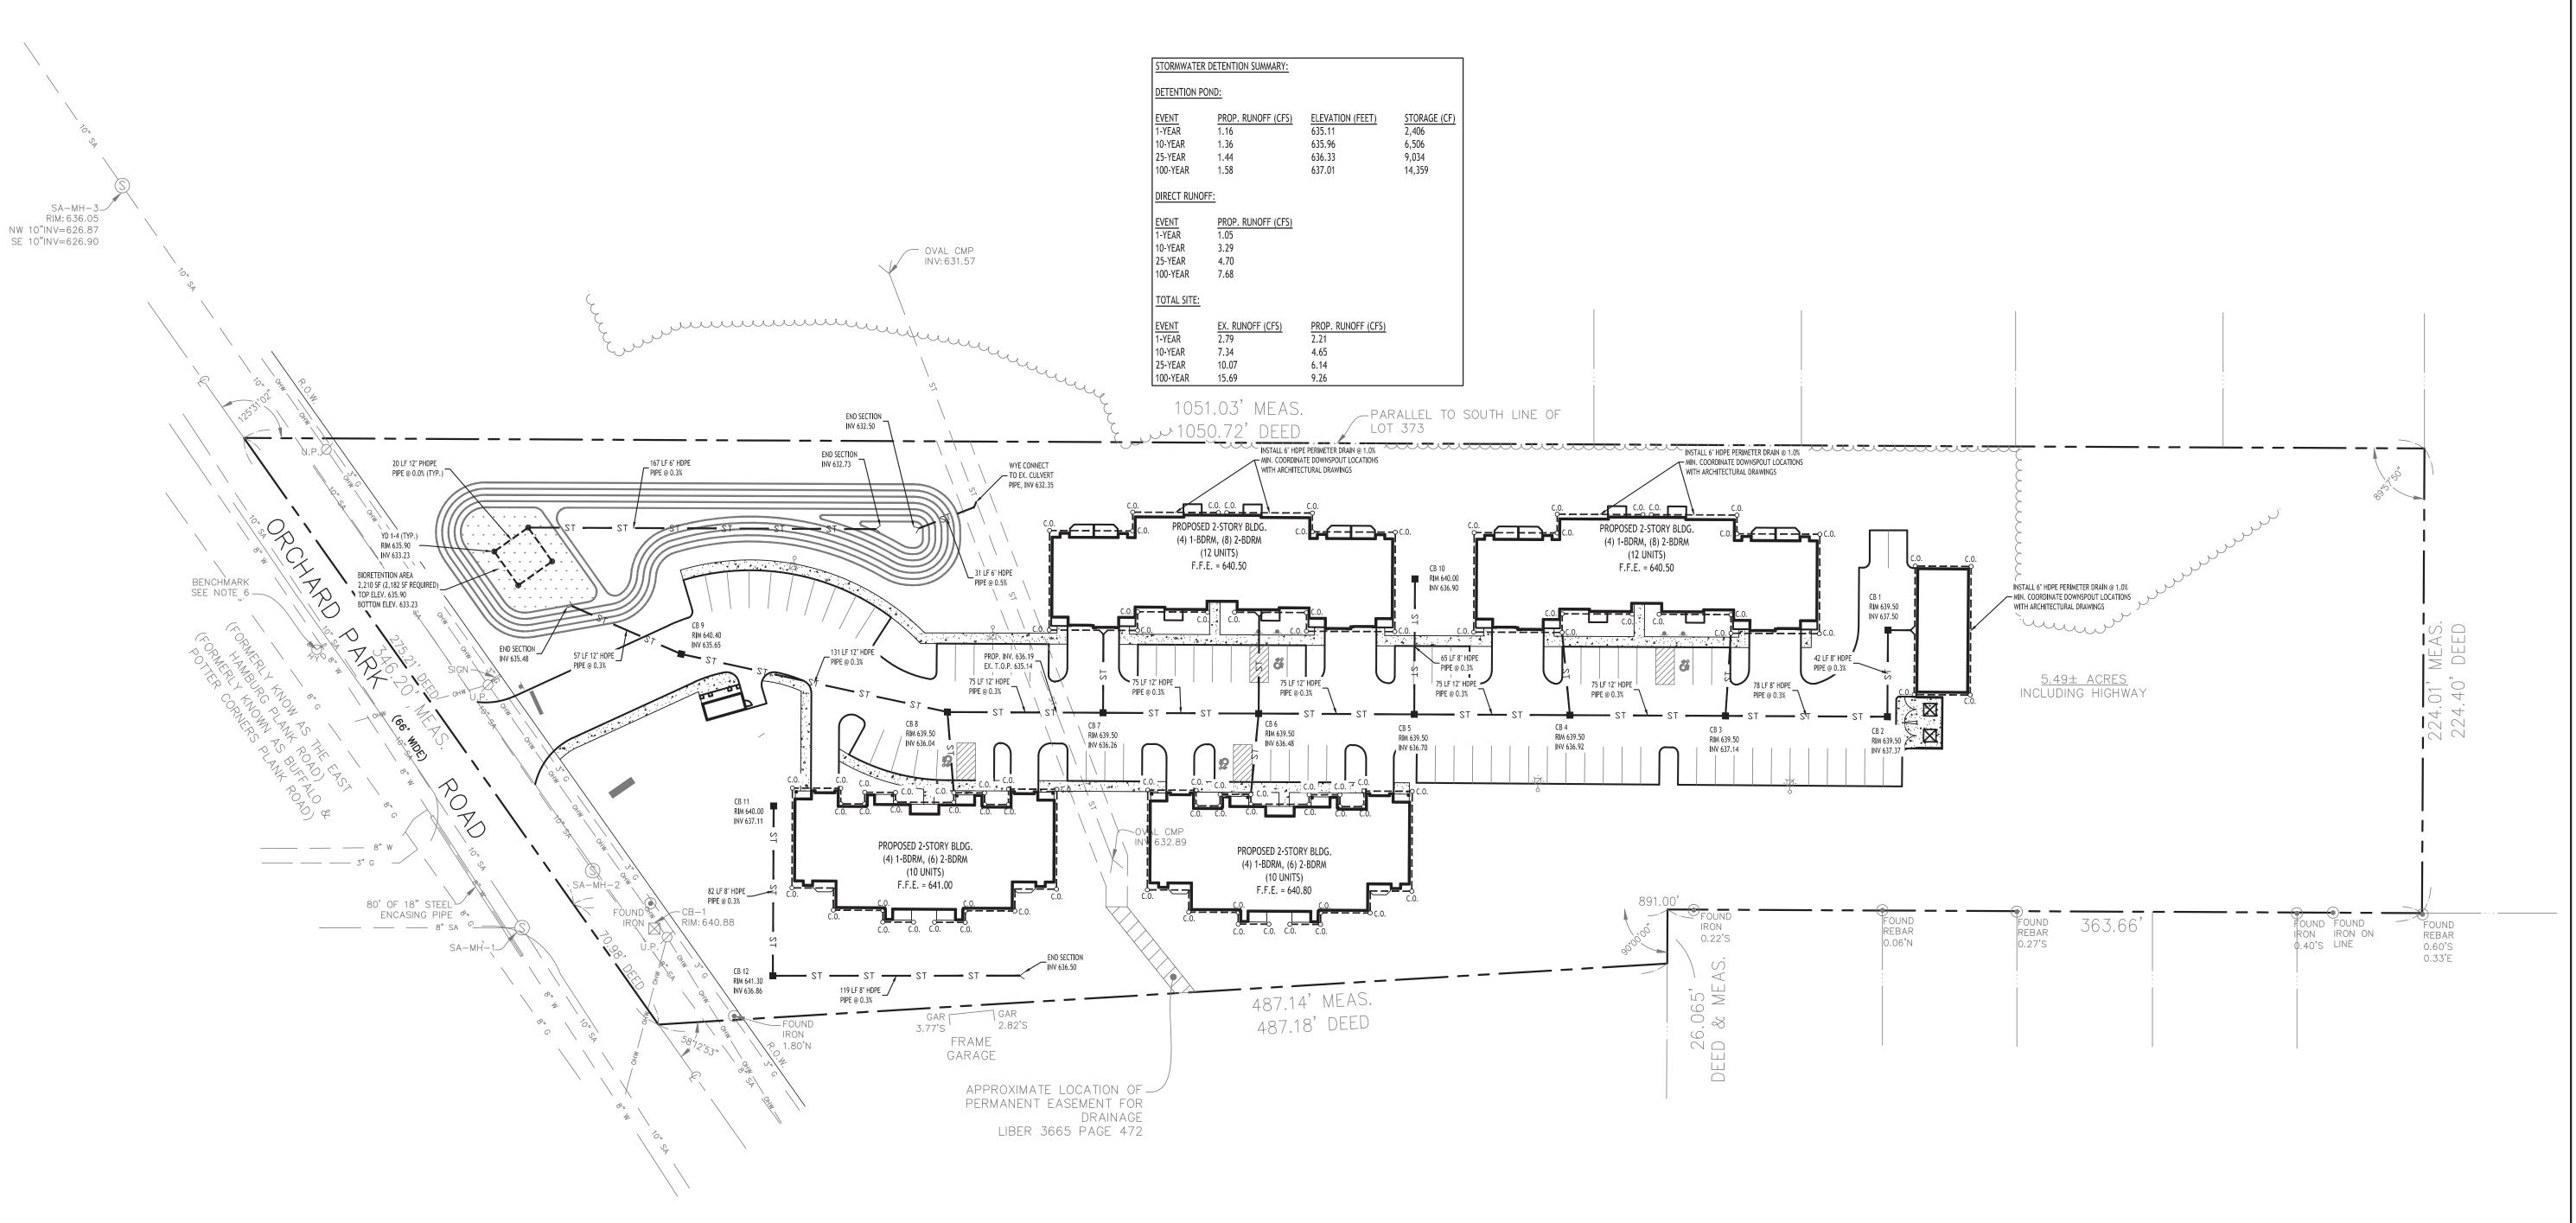
PROPOSED GATE VALVE

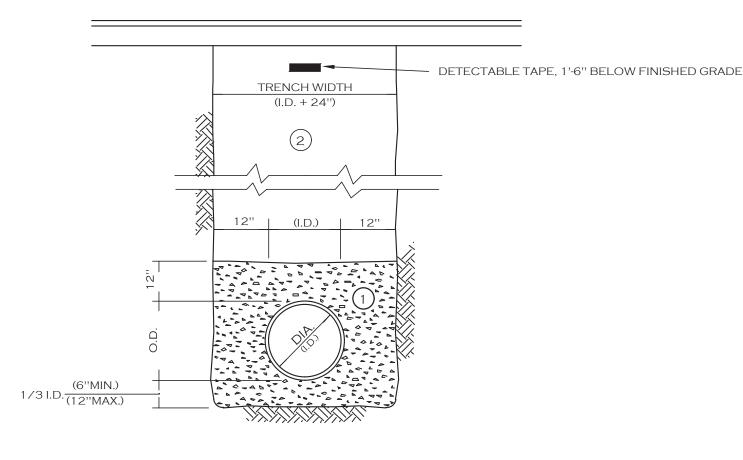
DRAWING NAME: Drainage Plan

As Noted

Date: 6/21/23 Drawn By: A. Pandolfe Scale: DRAWING NO.

Project No: 22.128





NOTES:

- A. PIPE INSTALLATION SHALL BE IN ACCORDANCE WITH MANUFACTURERS
- B. TRENCHING OPERATIONS SHALL INCLUDE ALL NECESSARY DEWATERING.
- C. TRENCH DETAILS ARE ONLY SHOWN FOR PURPOSES OF MATERIAL PLACEMENT AND MAXIMUM PAY LIMITS.
- D. AN OSHA APPROVED MOVABLE PROTECTIVE TRENCH SHIELD SHALL BE USED IN ALL UNSHEETED TRENCH AREAS.

<u>MATERIALS</u>

PIPE BEDDING MATERIAL (NYSDOT 1985 EDITION)

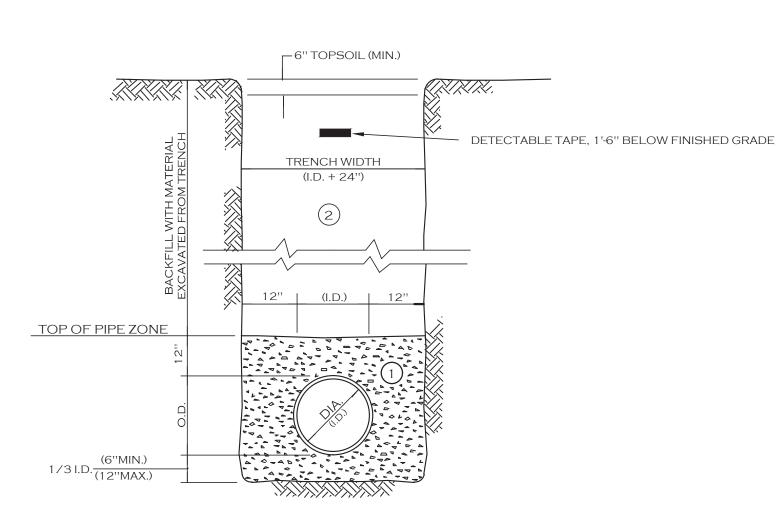
(1) NO. 1 CRUSHED STONE OR CRUSHED GRAVEL WITH A GRADATION CONFORMING WITH NYSDOT SECTION 703-02. THE MATERIAL SHALL BE WELL GRADED WITH NO PARTICLES LARGER THAN ONE INCH AND HAVING A MAXIMUM GRADATION MEETING THE LIMITS DESCRIBED IN THE SPECIFICATIONS. THE BEDDING SHALL BE COMPACTED IN 6" LIFTS WITH EQUIPMENT ACCEPTABLE TO THE PIPE MANUFACTURER.

NO SLAG SHALL BE ALLOWED FOR MATERIAL (1)

TYPE 2 CRUSHED STONE OR CRUSHED GRAVEL WITH A GRADATION CONFORMING WITH NYSDOT SECTION 304-2.02 TYPE 2. THE MATERAIL SHALL BE WELL GRADED WITH NO PARTICLES LARGER THAN TWO INCHES AND HAVING A MAXIMUM GRADATION MEETING THE LIMITS DESCRIBED IN THE SPECIFICATIONS. THE BEDDING SHALL BE COMPACTED IN 6" LIFTS WITH EQUIPMENT ACCEPTABLE TO THE PIPE MANUFACTURER.

NO SLAG SHALL BE ALLOWED FOR MATERIAL 2

STORM SEWER TRENCH SECTION **IN PAVED AREAS**



NOTES:

- A. PIPE INSTALLATION SHALL BE IN ACCORDANCE WITH MANUFACTURERS RECOMMENDATIONS.
- B. TRENCHING OPERATIONS SHALL INCLUDE ALL NECESSARY DEWATERING.
- C. TRENCH DETAILS ARE ONLY SHOWN FOR PURPOSES OF MATERIAL PLACEMENT AND MAXIMUM PAY LIMITS.
- D. AN OSHA APPROVED MOVABLE PROTECTIVE TRENCH SHIELD SHALL BE USED IN ALL UNSHEETED TRENCH AREAS.

MATERIALS

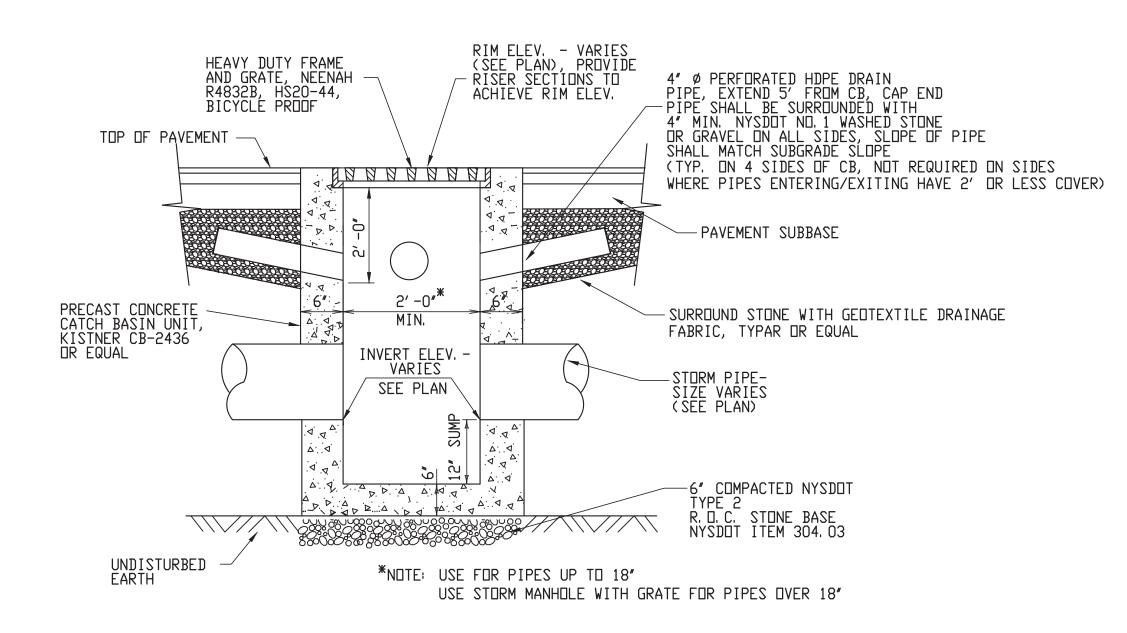
PIPE BEDDING MATERIAL (NYSDOT 1985 EDITION)

NO. 1 CRUSHED STONE OR CRUSHED GRAVEL WITH A GRADATION CONFORMING WITH NYSDOT SECTION 703-02. THE MATERIAL SHALL BE WELL GRADED WITH NO PARTICLES LARGER THAN ONE INCH AND HAVING A MAXIMUM GRADATION MEETING THE LIMITS DESCRIBED IN THE SPECIFICATIONS. THE BEDDING SHALL BE COMPACTED IN 6" LIFTS WITH EQUIPMENT ACCEPTABLE TO THE PIPE MANUFACTURER.


NO SLAG SHALL BE ALLOWED FOR MATERIAL (1)

BACKFILL MATERIAL SHALL BE NATIVE SOIL CONTAINING NO UNSUITABLE MATERIAL COMPACTED IN 6" LIFTS.


STORM SEWER TRENCH SECTION IN UNPAVED AREAS




TYPICAL PRECAST CATCH BASIN

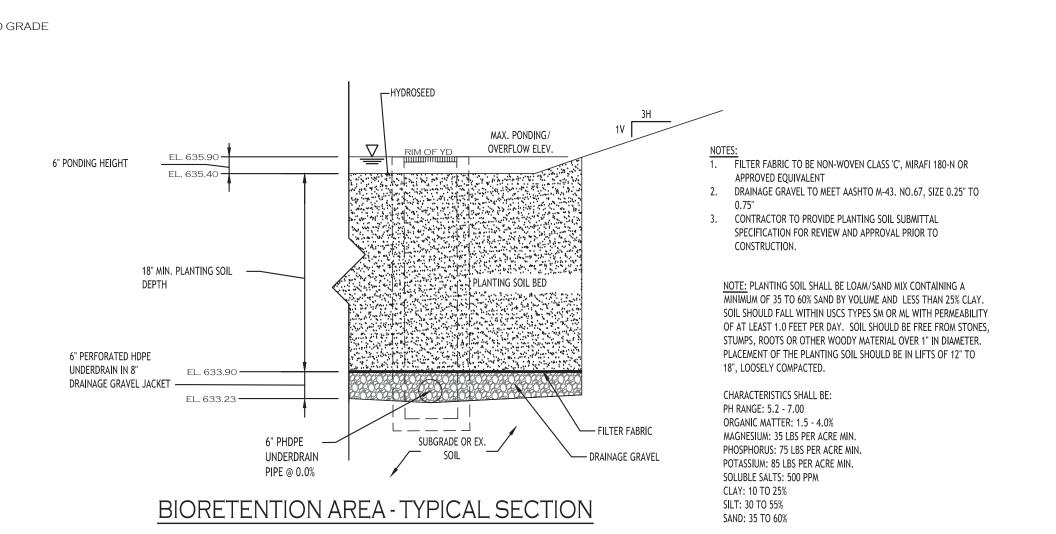


Seed Mixture	Variety	Percent by No. of Seeds
Creeping Bentgrass	Agrostis stolonifera	63.0
Rough Bluegrass	Poa trivialis	17.0
Meadow Foxtail	Alopecurus arundinaceus	11.0
Annual Ryegrass	Lolium multiflorum	4.5
Deertongue	Panicum clandestinum	4.5

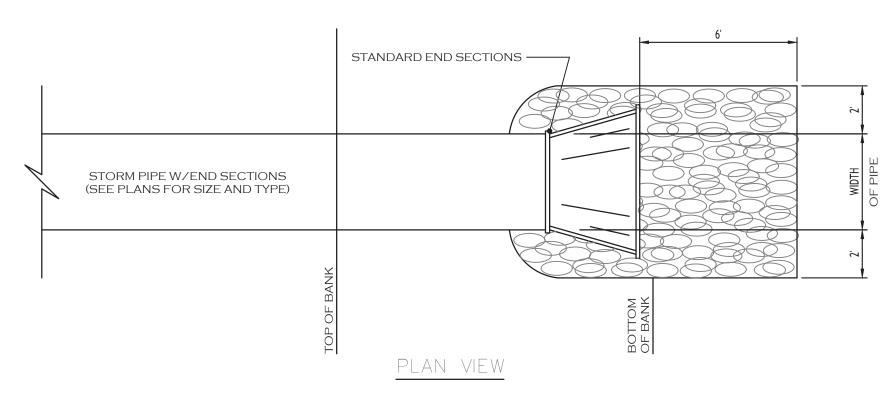

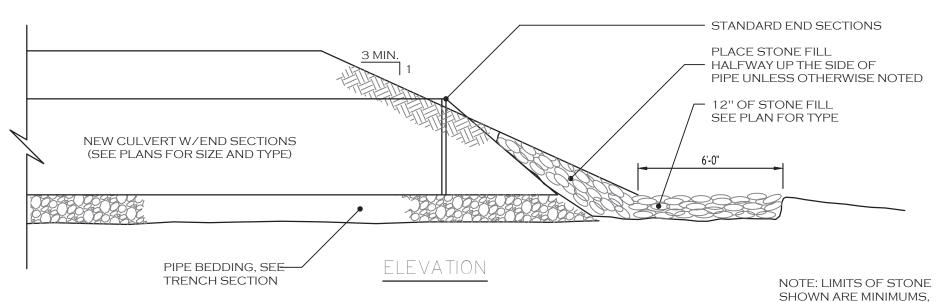

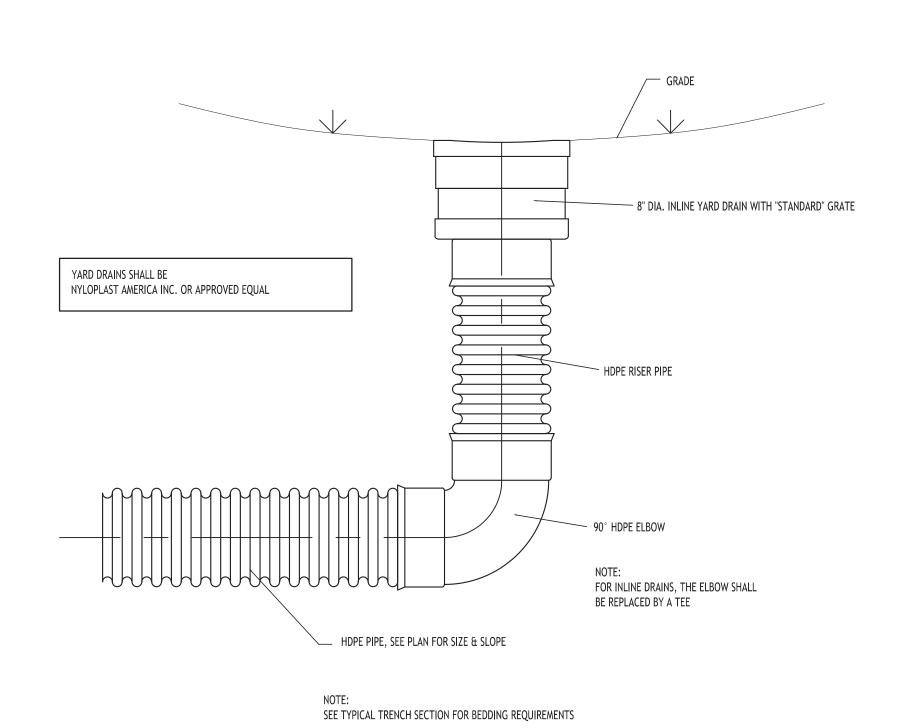TYPICAL PIPE OUTLET W/END SECTION & RIP RAP



TYPICAL YARD DRAIN DETAIL

PLAN MAY INDICATE GREATER LIMITS

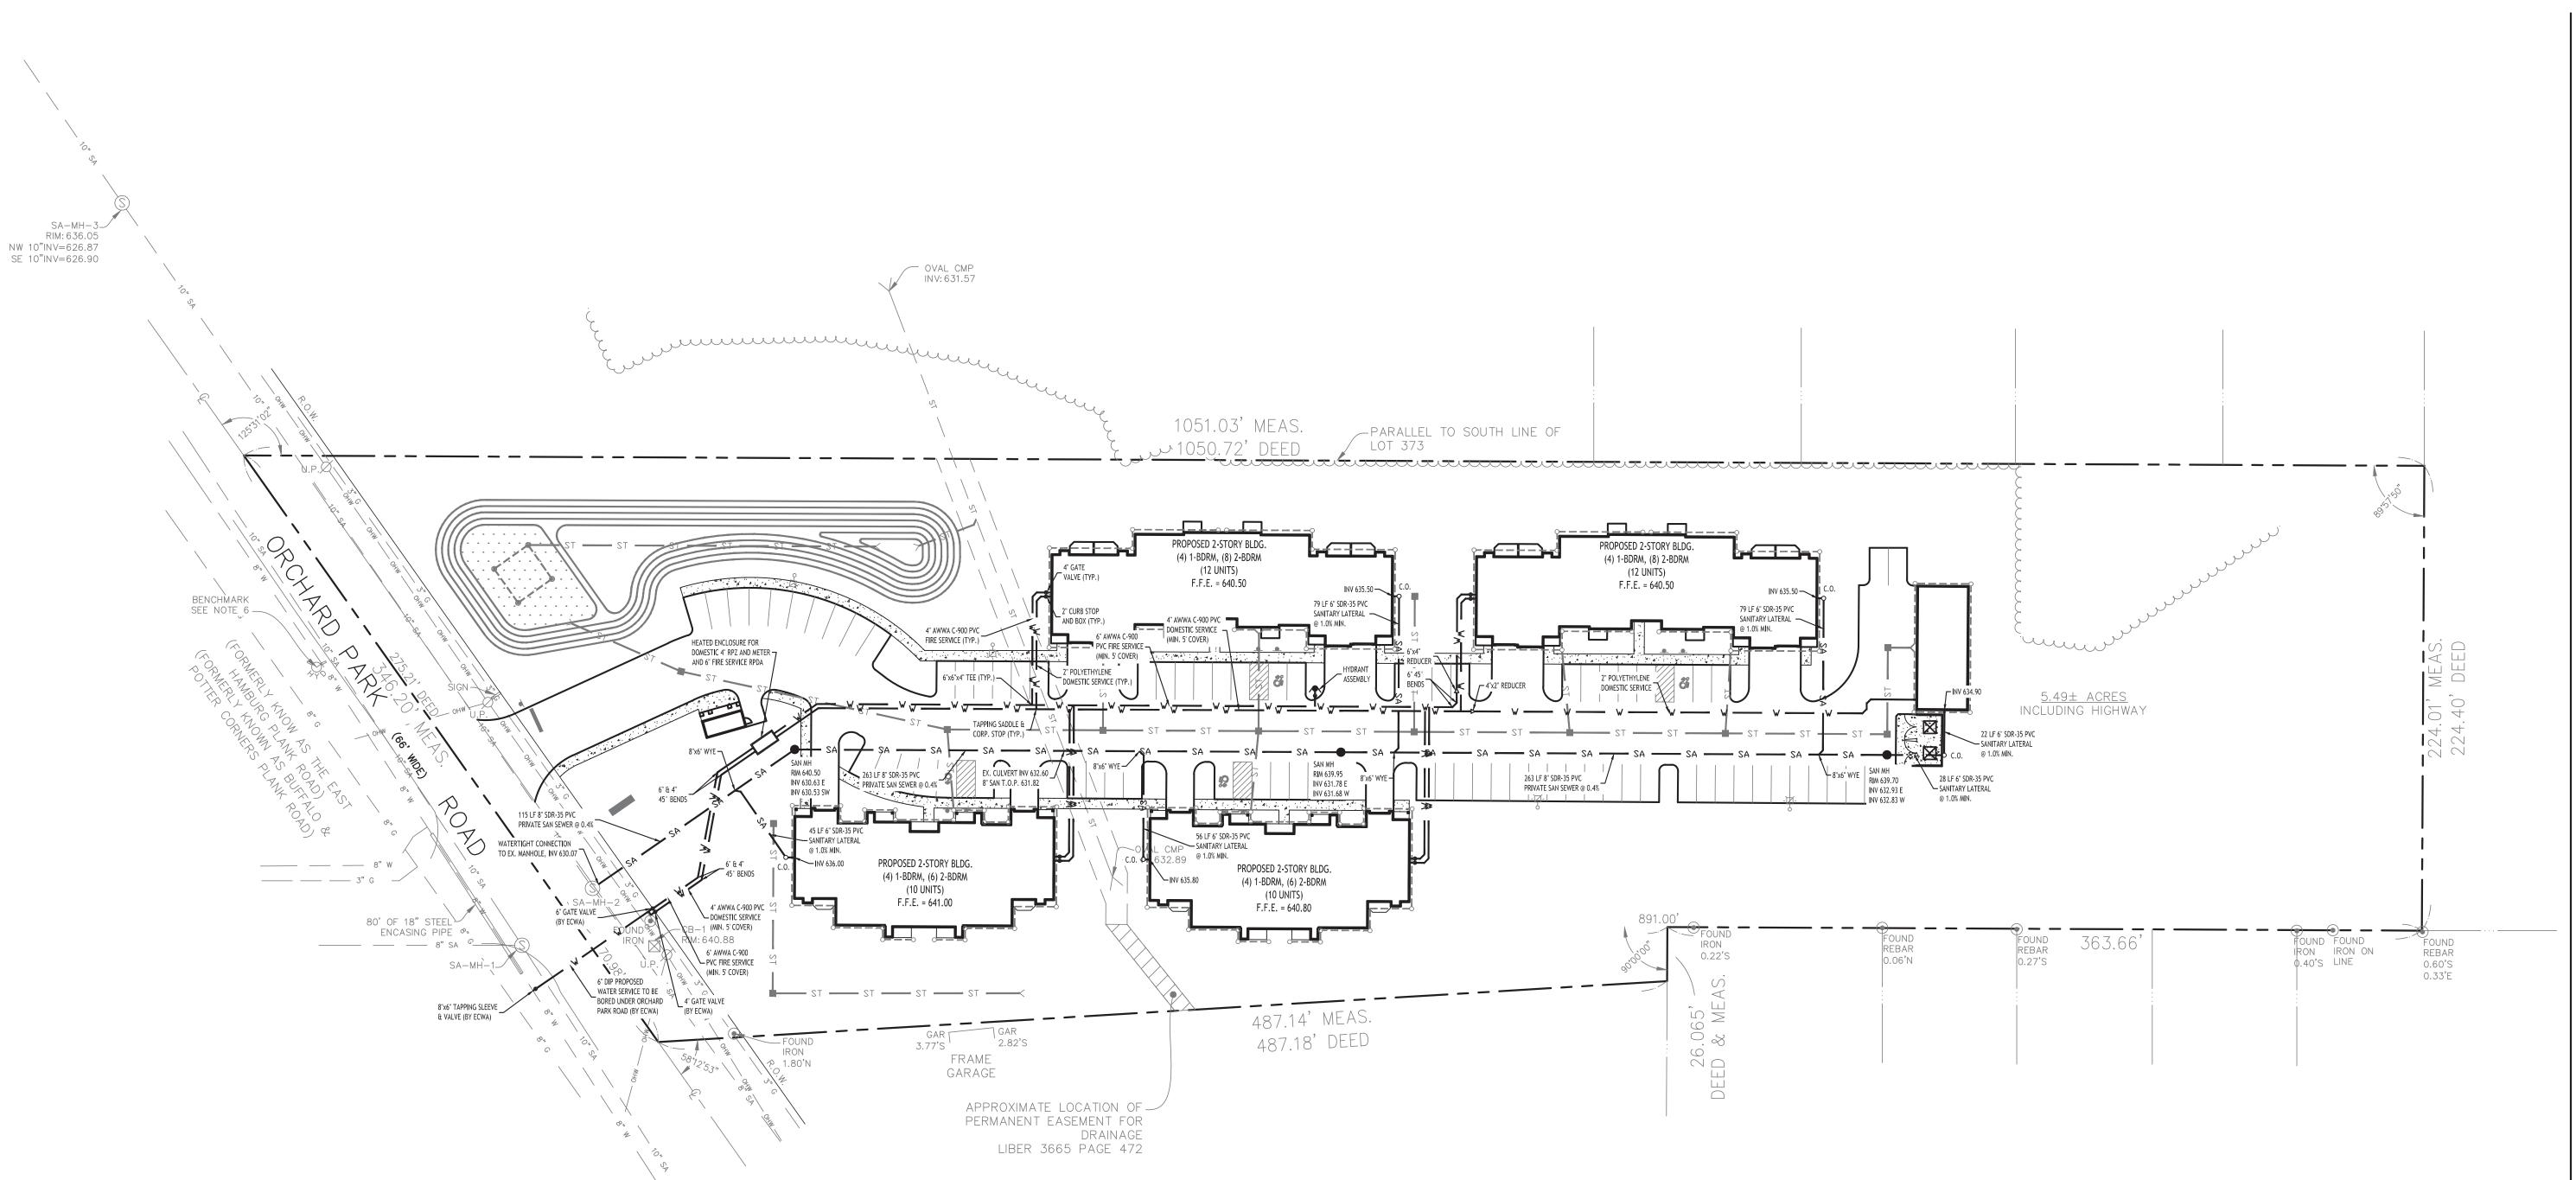
DRAWING NAME: **Drainage Details**

Drawn By: Scale: DRAWING NO.

6/21/23

As Noted

A. Pandolfe



- 1. ALL SANITARY SEWER CONSTRUCTION SHALL CONFORM TO TOWN OF WEST SENECA SPECIFICATIONS AND DETAILS, AND ERIE COUNTY DEPARTMENT OF HEALTH RULES AND REGULATIONS.
- 2. PRIOR STARTING ANY WORK ASSOCIATED WITH OR NEAR EXISTING SANITARY MANHOLES, THE CONTRACTOR SHALL MEET WITH THE TOWN OF WEST SENECA SEWER DEPARTMENT TO
- DISCUSS AND AGREE TO THE WORK. 3. FILL SHALL BE PLACED AND SATISFACTORILY COMPACTED PRIOR TO INSTALLATION OF
- UTILITIES, AND MUST BE APPROVED BY THE SUPERVISING PROJECT ENGINEER. 4. ALL OTHER REQUIRED PERMITS BY THE STATE OF NEW YORK, COUNTY OF ERIE AND TOWN OF WEST SENECA ARE THE RESPONSIBILITY OF THE CONTRACTOR/DEVELOPER.

UTILITY NOTES:


- 1. FOR ALL SANITARY SEWERS, INSTALL SELECT FILL IN PAVED AREAS, EXTEND 5' MIN. BEYOND PAVEMENT LIMITS
- 2. BUILDINGS TO HAVE A 6" HOUSE TRAP, VENT AND CLEANOUT INSTALLED AT ENTRANCE POINT. INVERT ELEVATION TO BE 5' MIN. BELOW F.F.E. OF THE BUILDING. PIPE TO BE 6" SDR-35 PVC @ 1.0% MIN WITH MIN 4' OF COVER. ADD ADDITIONAL CLEANOUTS @ 100' MAX. SPACING FOR 6" LATERALS OVER 90' IN LENGTH.
- 3. COORDINATE GAS & ELEC. METER BANK LOCATIONS ON BUILDINGS WITH M.E.P. PLANS & UTILITY CO.'S.
- 4. COORDINATE LOCATION OF CTV & TELEPHONE SERVICE TO BUILDINGS WITH M.E.P. PLANS AND UTILITY CO.'S.
- 5. ANY EXISTING UTILITIES WHICH ARE TO BE ABANDONED AND FALL UNDER PAVEMENT OR BUILDINGS SHALL BE REMOVED VS. BEING ABANDONED UNLESS THOSE UTILITIES ARE FILLED WITH FLOWABLE FILL.
- 6. EXISTING GAS SERVICES TO REMAIN UNLESS OTHERWISE NOTED. ANY PORTIONS TO BE RELOCATED SHALL BE COORDINATED WITH NATIONAL FUEL GAS.
- 7. ALL UNDERGROUND TELEPHONE SERVICES SHALL REMAIN AND BE PROTECTED DURING CONSTRUCTION.
- 8. A MINIMUM OF 10 FEET HORIZONTAL AND 18 INCHES OF VERTICAL SEPARATION MUST BE MAINTAINED BETWEEN ALL SANITARY SEWER AND WATER SERVICES.
- 9. ERIE COUNTY WATER AUTHORITY (ECWA) IS TO BE NOTIFIED A MINIMUM OF 48-HOURS PRIOR TO STARTING THE CONNECTION TO THE NEW WATER SERVICE.
- 10. SELECT BACKFILL IS REQUIRED FOR ALL UTILITIES (GAS, WATER, STORM, SANITARY) THAT CROSS THROUGH PAVEMENT AREAS.


PROPOSED UTILITY LEGEND				
PROPOSED STORM SEWER	— ST —			
PROPOSED SANITARY SEWER	6" SA -			
PROPOSED WATERLINE	—_1" W —			
PROPOSED CATCH BASIN	СВ			
PROPOSED YARD DRAIN	⊗ YD			
PROPOSED MANHOLE	● MH			
PROPOSED HYDRANT ASSEMBLY				


PROPOSED GATE VALVE NOTE: FOR PROPOSED VALVE BOXES, CLEANOUTS, ETC., INSTALL A 3,000 PSI CONCRETE COLLAR AROUND THE ITEM AT GRADE. THE COLLAR SHALL BE A MINIMUM OF 6" WIDER, ON ALL SIDES, THAN THE

NOTE: BOUNDARY AND TOPOGRAPHIC INFORMATION PROVIDED BY OTHERS, CARMINA WOOD DESIGN ASSUMES NO RESPONSIBILITY FOR ITS ACCURACY.

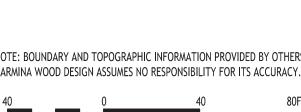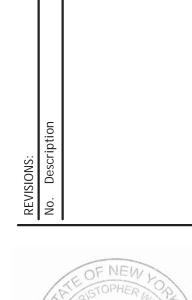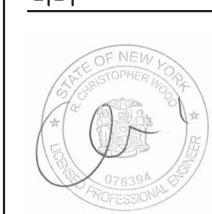BOX, CLEANOUT, ETC. THE COLLAR SHALL BE A MINIMUM OF 6" THICK.








DRAWING NAME: **Utility Plan**

Drawn By:

A. Pandolfe As Noted DRAWING NO.

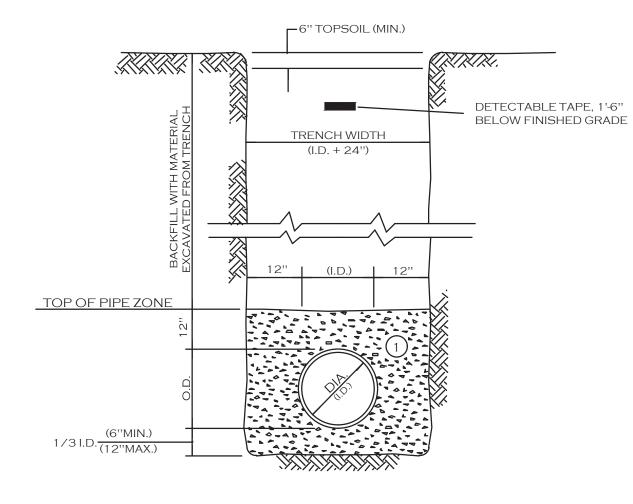6/21/23



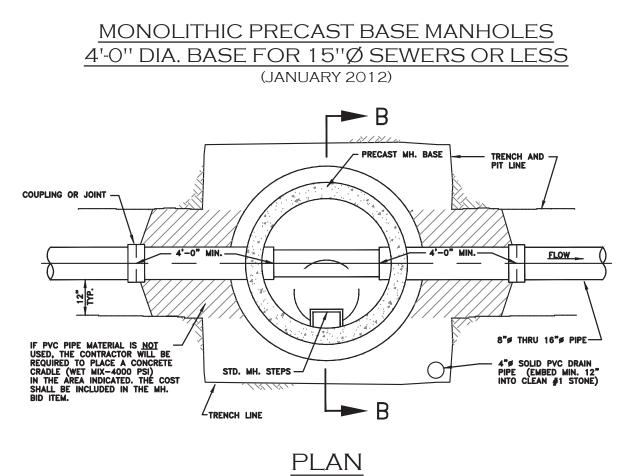
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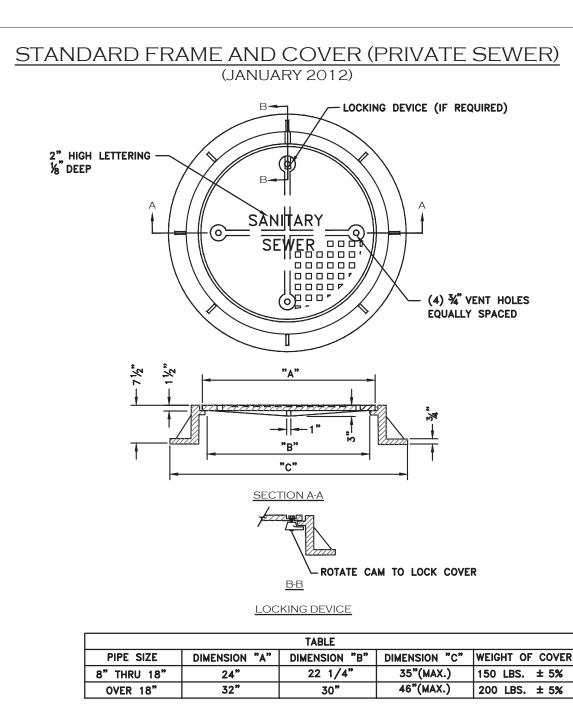
- A. PIPE INSTALLATION SHALL BE IN ACCORDANCE WITH MANUFACTURERS
- B. TRENCHING OPERATIONS SHALL INCLUDE ALL NECESSARY DEWATERING.
- C. TRENCH DETAILS ARE ONLY SHOWN FOR PURPOSES OF MATERIAL PLACEMENT AND MAXIMUM PAY LIMITS.
- D. AN OSHA APPROVED MOVABLE PROTECTIVE TRENCH SHIELD SHALL BE USED IN ALL UNSHEETED TRENCH AREAS.

<u>MATERIALS</u>

- PIPE BEDDING MATERIAL (NYSDOT LATEST EDITION) NO.1 CRUSHED STONE WITH A GRADATION CONFORMING WITH NYSDOT SECTION 703-02. THE CRUSHED STONE SHALL BE WELL GRADED WITH NO PARTICLES LARGER THAN 1" AND HAVING A MAXIMUM GRADATION MEETING THE LIMITS DESCRIBED IN THE SPECIFICATIONS. THE BEDDING SHALL BE COMPACTED IN 6" LIFTS WITH EQUIPMENT ACCEPTABLE TO THE PIPE MANUFACTURER. SELECT MATERIAL BACKFILL (NYSDOT LATEST EDITION)
- 2 NO.2 RUN OF CRUSHER STONE OR NO.2 RUN OF CRUSHER GRAVEL WITH A GRADATION CONFORMING WITH NYSDOT SECTION 304-2.02 TYPE 4 AND NYSDOT SECTION 703-02. (COMPACTED IN 6"LIFTS TO 90% DENSITY) NOTE: SLAG SHALL NOT BE ALLOWED FOR MATERIALS (1) AND (2)

UTILITY TRENCH SECTION IN UNPAVED AREAS





6. FRAMES AND COVERS SHALL HAVE MACHINED BEARING SURFACES.

MACHINED BEAKING SURFACES.

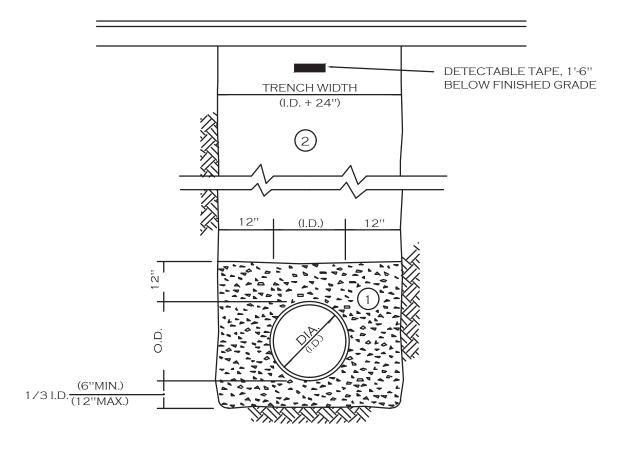
7. LOCKING DEVICE MUST BE SITUATED TO ALLOW EASY REMOVAL OF COVER.

8. NO COMMERCIAL "BRAND NAME" LETTERING WILL BE ALLOWED ON THE EXPOSED SURFACE OF THE COVER.

. MATERIAL ASTM A48 CLASS 30B CAST IRON. 2. UNIT MUST WITHSTAND H-20 WHEEL LOADING.

COVER WEIGHT 210 LBS. (MAX) COATING NOT REQUIRED.

ALL DIMENSIONS ARE TO BE CONSIDERED MINIMUM WITH THE EXCEPTION OF THE COVER, WHICH MUST CONFORM EXACTLY TO MAINTAIN INTERCHANGEABILITY WITHIN THE COUNTY.

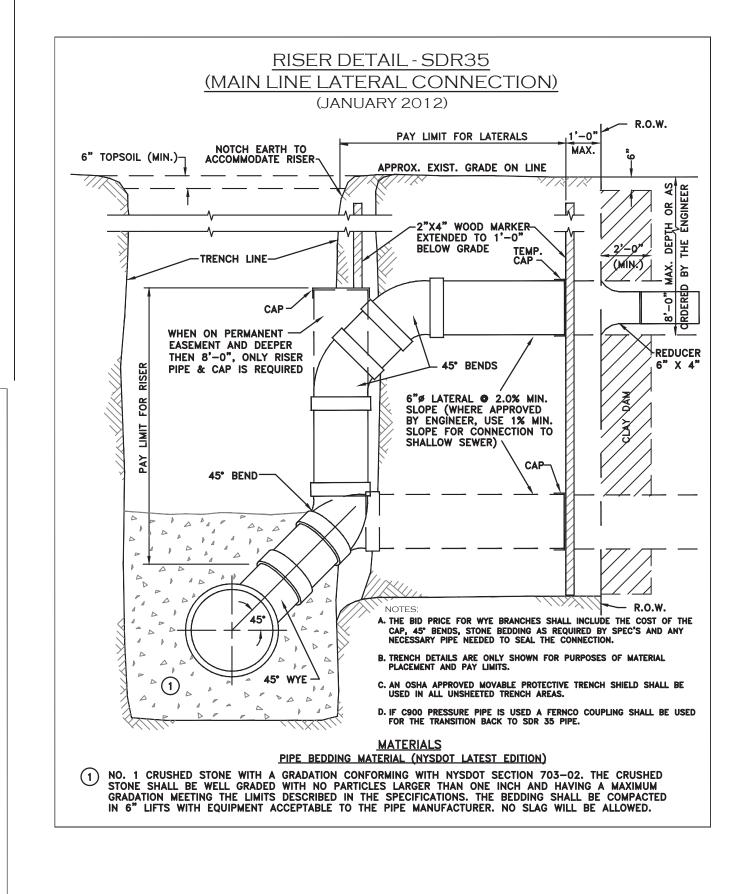


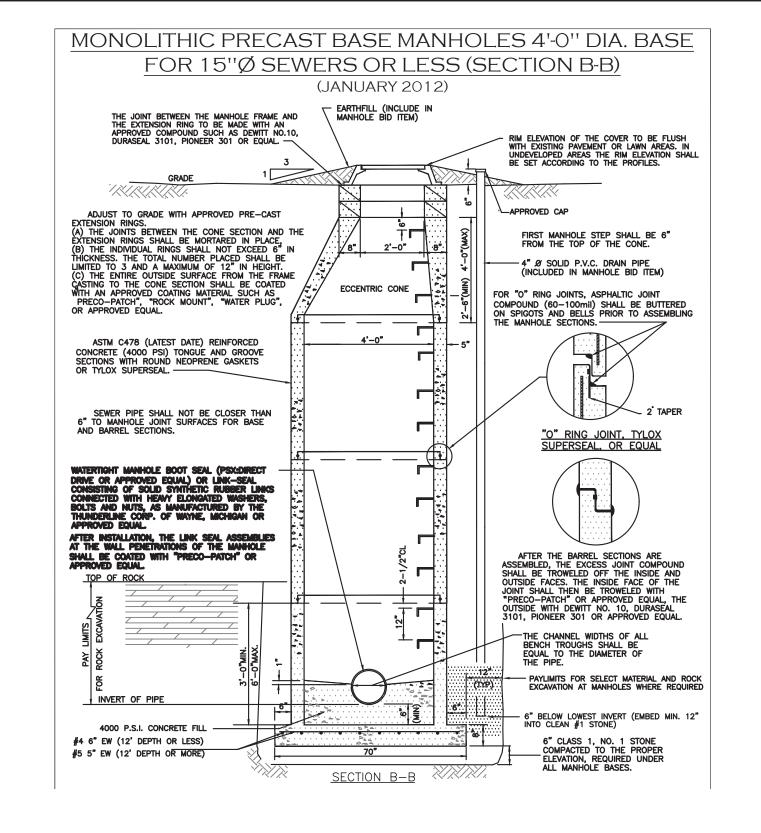
- A. PIPE INSTALLATION SHALL BE IN ACCORDANCE WITH MANUFACTURERS
- B. TRENCHING OPERATIONS SHALL INCLUDE ALL NECESSARY DEWATERING C. TRENCH DETAILS ARE ONLY SHOWN FOR PURPOSES OF MATERIAL
- PLACEMENT AND MAXIMUM PAY LIMITS.
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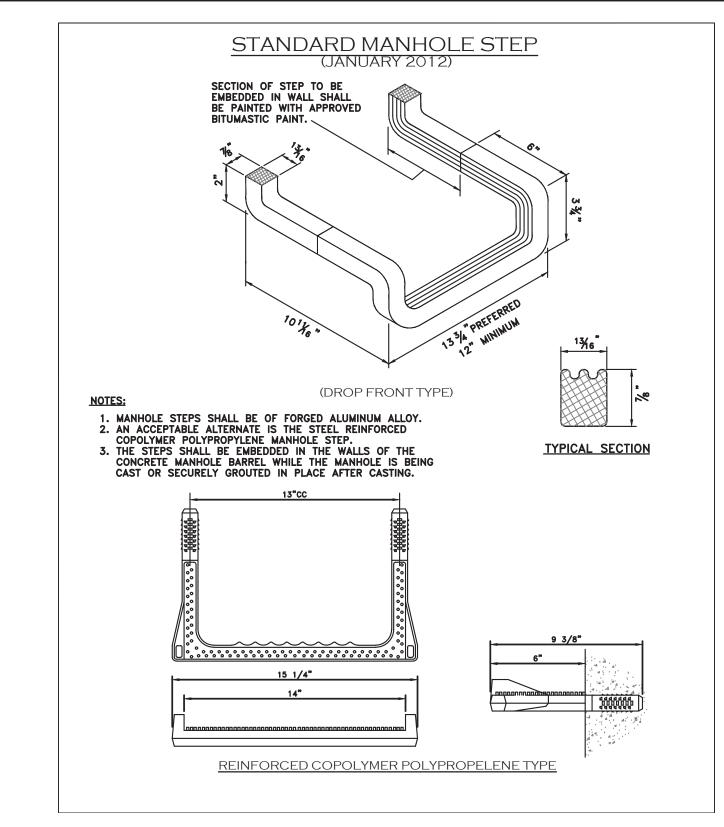
MATERIALS


- PIPE BEDDING MATERIAL (NYSDOT LATEST EDITION) NO.1 CRUSHED STONE WITH A GRADATION CONFORMING WITH NYSDOT SECTION 703-02. THE CRUSHED STONE SHALL BE WELL GRADED WITH NO PARTICLES LARGER THAN 1" AND HAVING A MAXIMUM GRADATION MEETING THE LIMITS DESCRIBED IN THE SPECIFICATIONS. THE BEDDING SHALL BE COMPACTED IN 6" LIFTS WITH EQUIPMENT ACCEPTABLE TO THE PIPE MANUFACTURER.
- SELECT MATERIAL BACKFILL (NYSDOT LATEST EDITION) 2 NO.2 RUN OF CRUSHER STONE OR NO.2 RUN OF CRUSHER GRAVEL WITH A GRADATION CONFORMING WITH NYSDOT SECTION 304-2.02 TYPE 4 AND NYSDOT SECTION 703-02. (COMPACTED IN 6"LIFTS TO 90% NOTE: SLAG SHALL NOT BE ALLOWED FOR MATERIALS (1) AND (2)

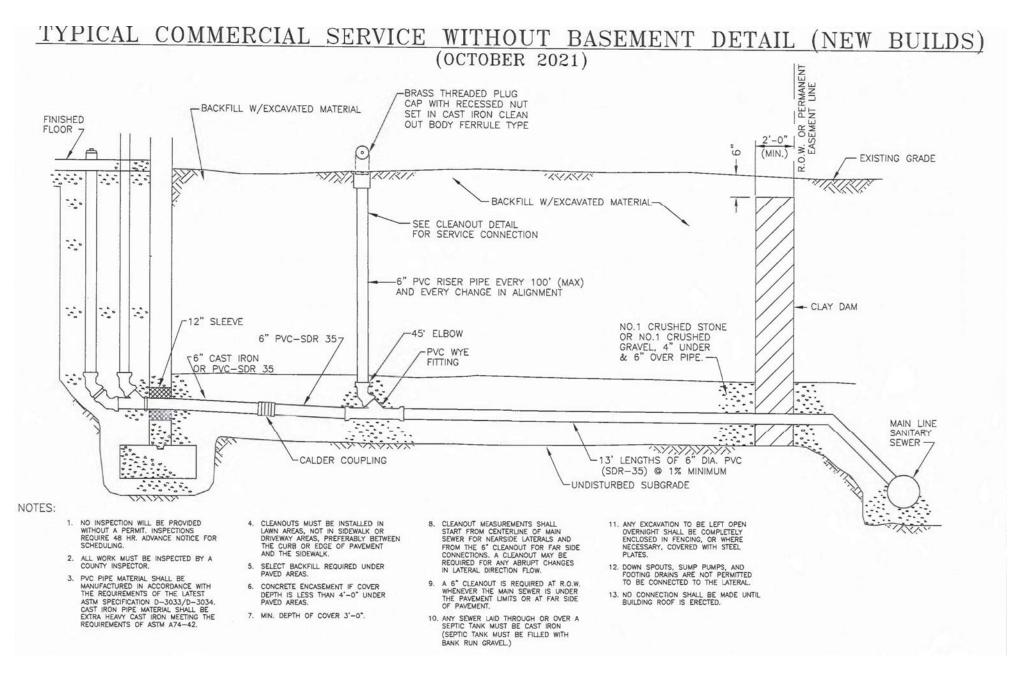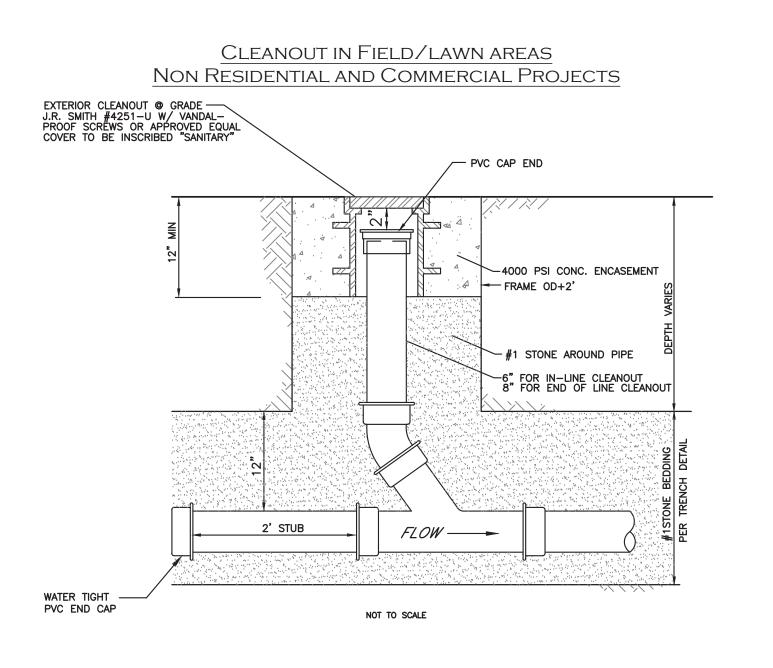
UTILITY TRENCH SECTION IN PAVED AREAS

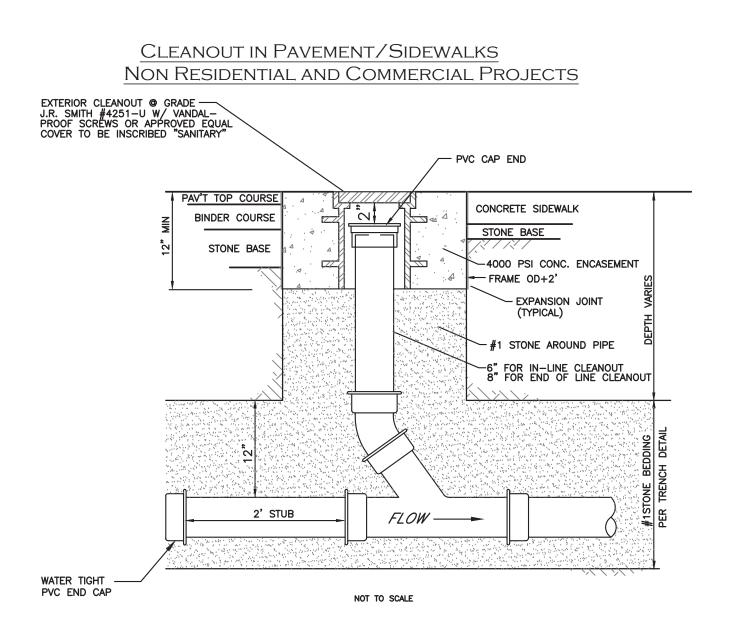














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Date:

DRAWING NAME:

Utility Details

6/21/23 A. Pandolfe Drawn By: As Noted DRAWING NO.

Scale:

SECTION A-A

6" DIP RISER (TYP)

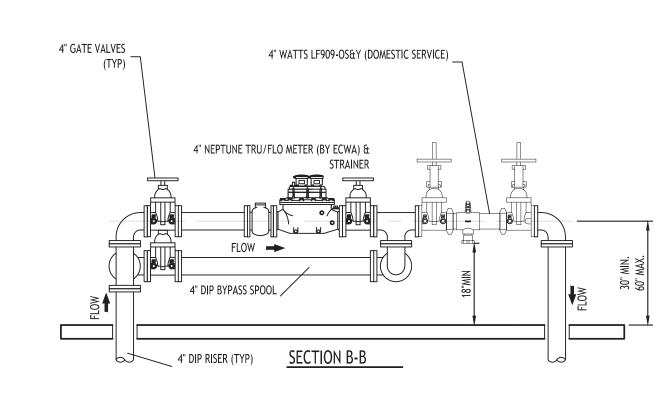
6" WATTS 957 RPDA (FIRE SERVICE)

6" GATE VALVES


- 1. BACKFLOW PREVENTER DIMENSIONS FURNISHED BY WATTS.
- 2. ALL DIMENSIONS ARE IN INCHES.
- 3. WALL & INSULATION THICKNESS IS 1-1/2".
- 4. ROOF & INSULATION THICKNESS IS 3".

5. EXTERIOR ENCLOSURE DIMENSIONS: SEE SITE PLAN.


- 6. CONCRETE PAD IS 72"W x 149"L x 6"THK W/W.W.F. 6X6/10X10.
- 7. METER SHOWN: 4" NEPTUNE TRU/FLO COMPOUND METER; SUPPLIED BY ECWA, VERIFY DIMENSIONS PRIOR TO ORDERING.
- 8. RPZ SHOWN: 4" WATTS LF909-OS&Y (DOMESTIC SERVICE), 6" WATTS 957 RPDA (FIRE SERVICE).
- 9. CONTRACTOR TO INSTALL ELECTRIC SERVICE TO ENCLOSURE, COORDINATE SOURCE WITH OWNER.
- 10. INSTALL A 120V GFI OUTLET IN THE ENCLOSURE.
- 11. HEATERS TO HAVE THERMOSTAT CONTROL.



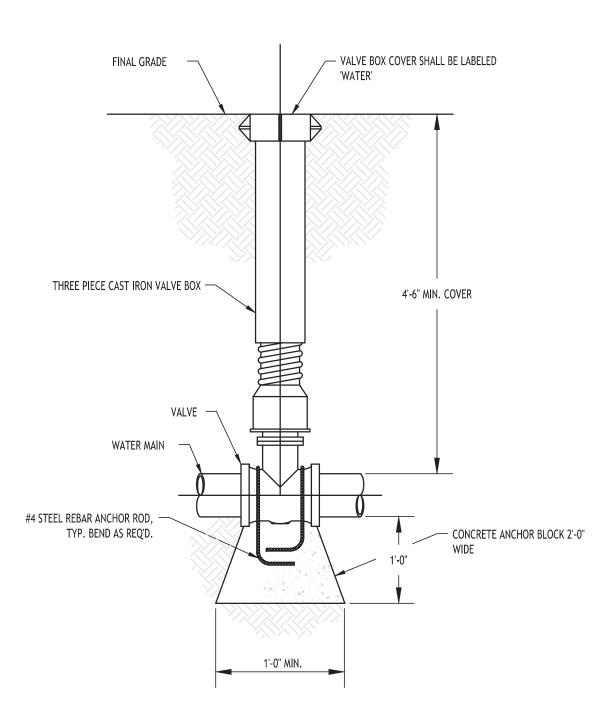
4" METER/RPZ (DOMESTIC) & 6" RPDA (FIRE)
NOT TO SCALE



TYPICAL GATE VALVE DETAIL NOT TO SCALE

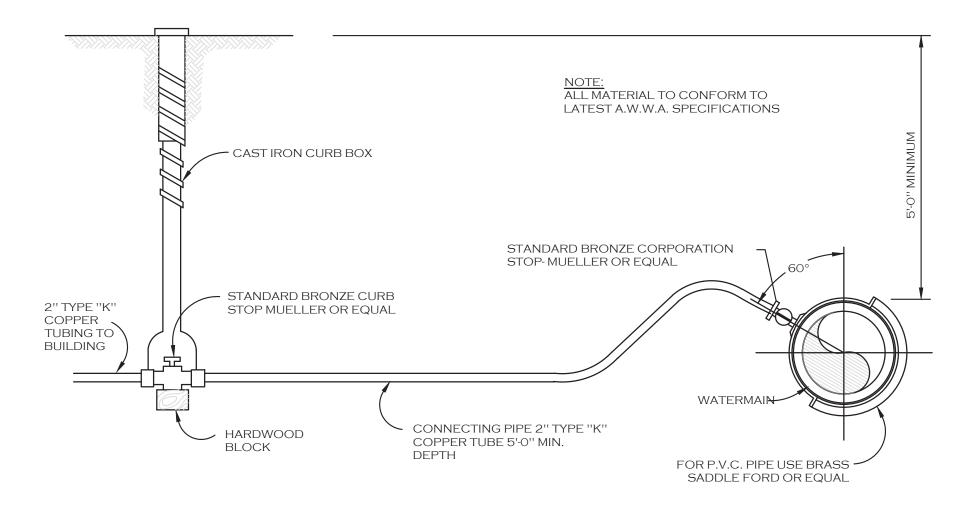

TYPICAL WATER SERVICE LINE INSTALLATION

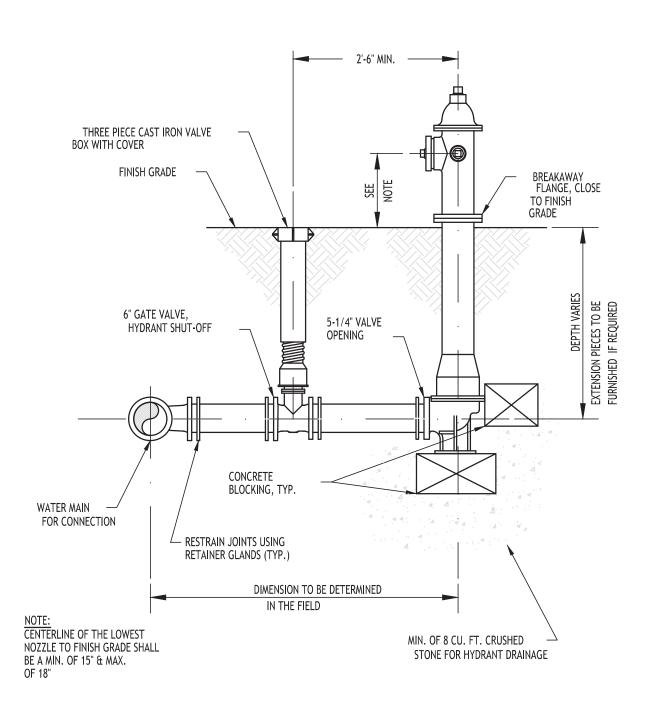

TYPICAL FIRE HYDRANT ASSEMBLY DETAIL NOT TO SCALE





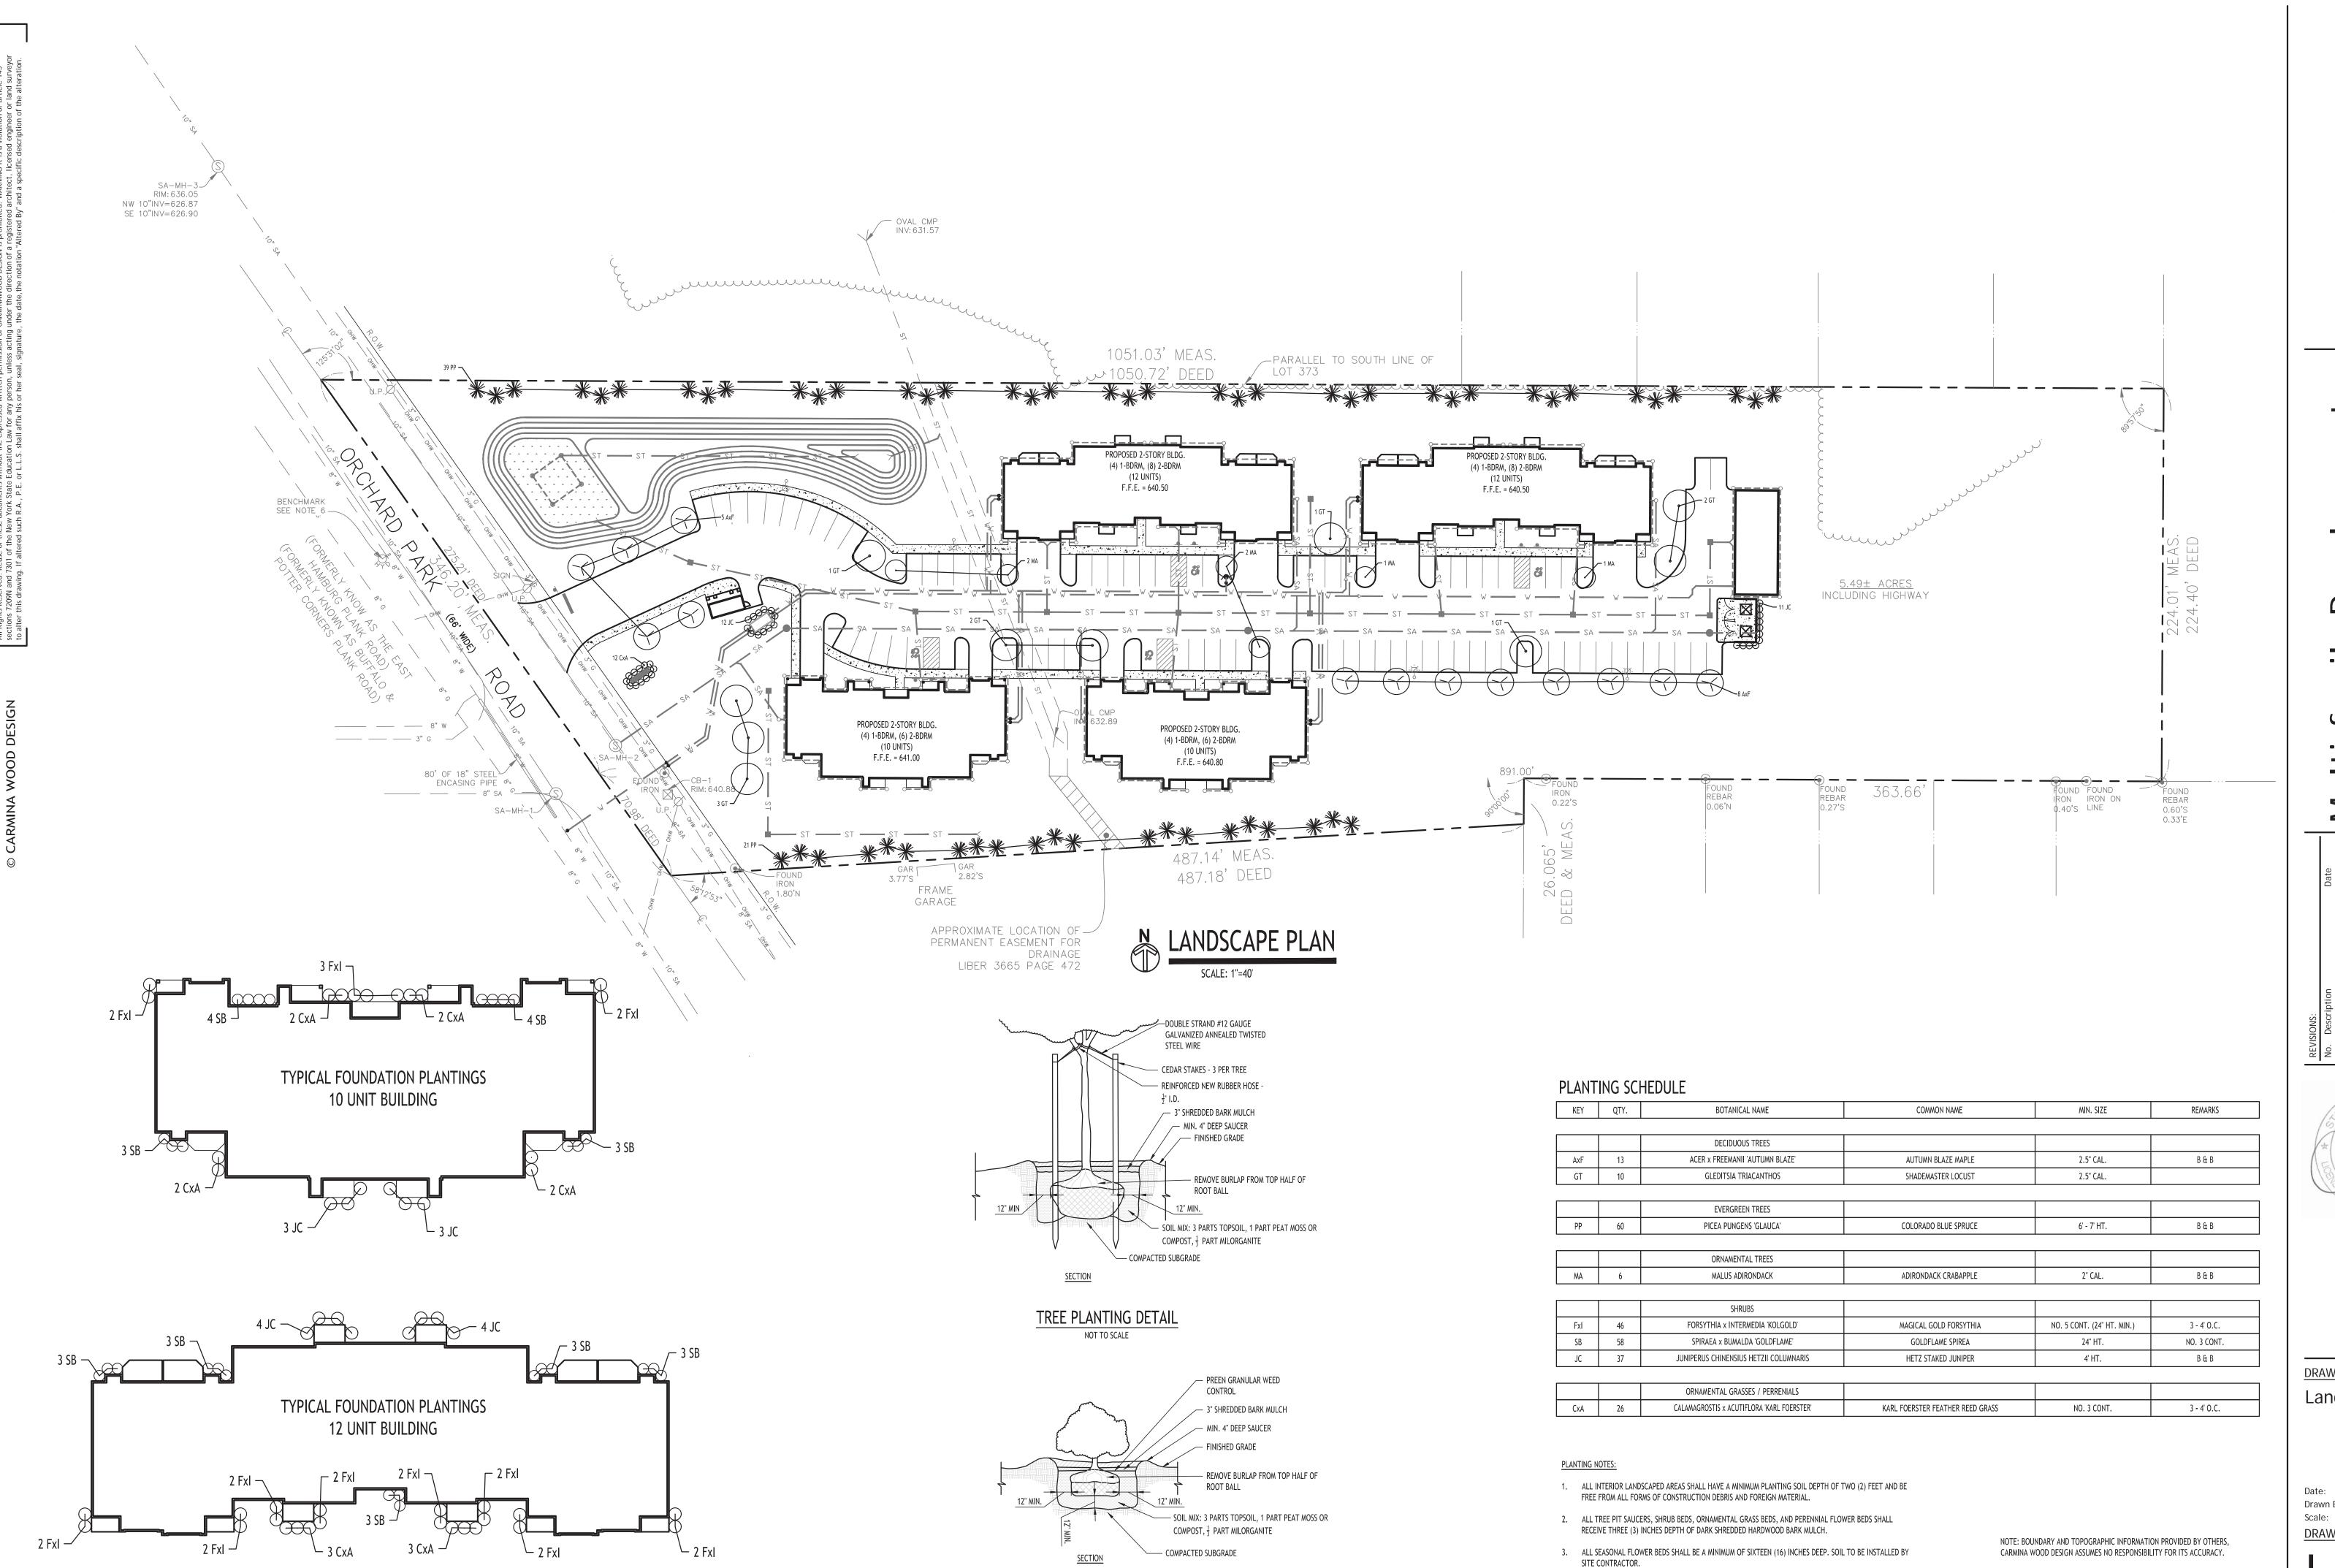
DRAWING NAME: **Utility Details**

6/21/23

A. Pandolfe


As Noted

Drawn By: Scale: DRAWING NO.



SHRUB PLANTING DETAIL

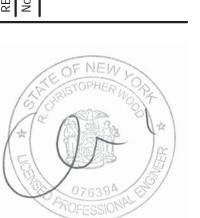NOT TO SCALE



DRAWING NAME:

Landscape Plan

Drawn By: DRAWING NO.

6/21/23 A. Pandolfe As Noted

4. ALL DECIDUOUS AND EVERGREEN TREES SHALL BE STAKED WITH THREE (3) TREE STAKES AS PER TREE

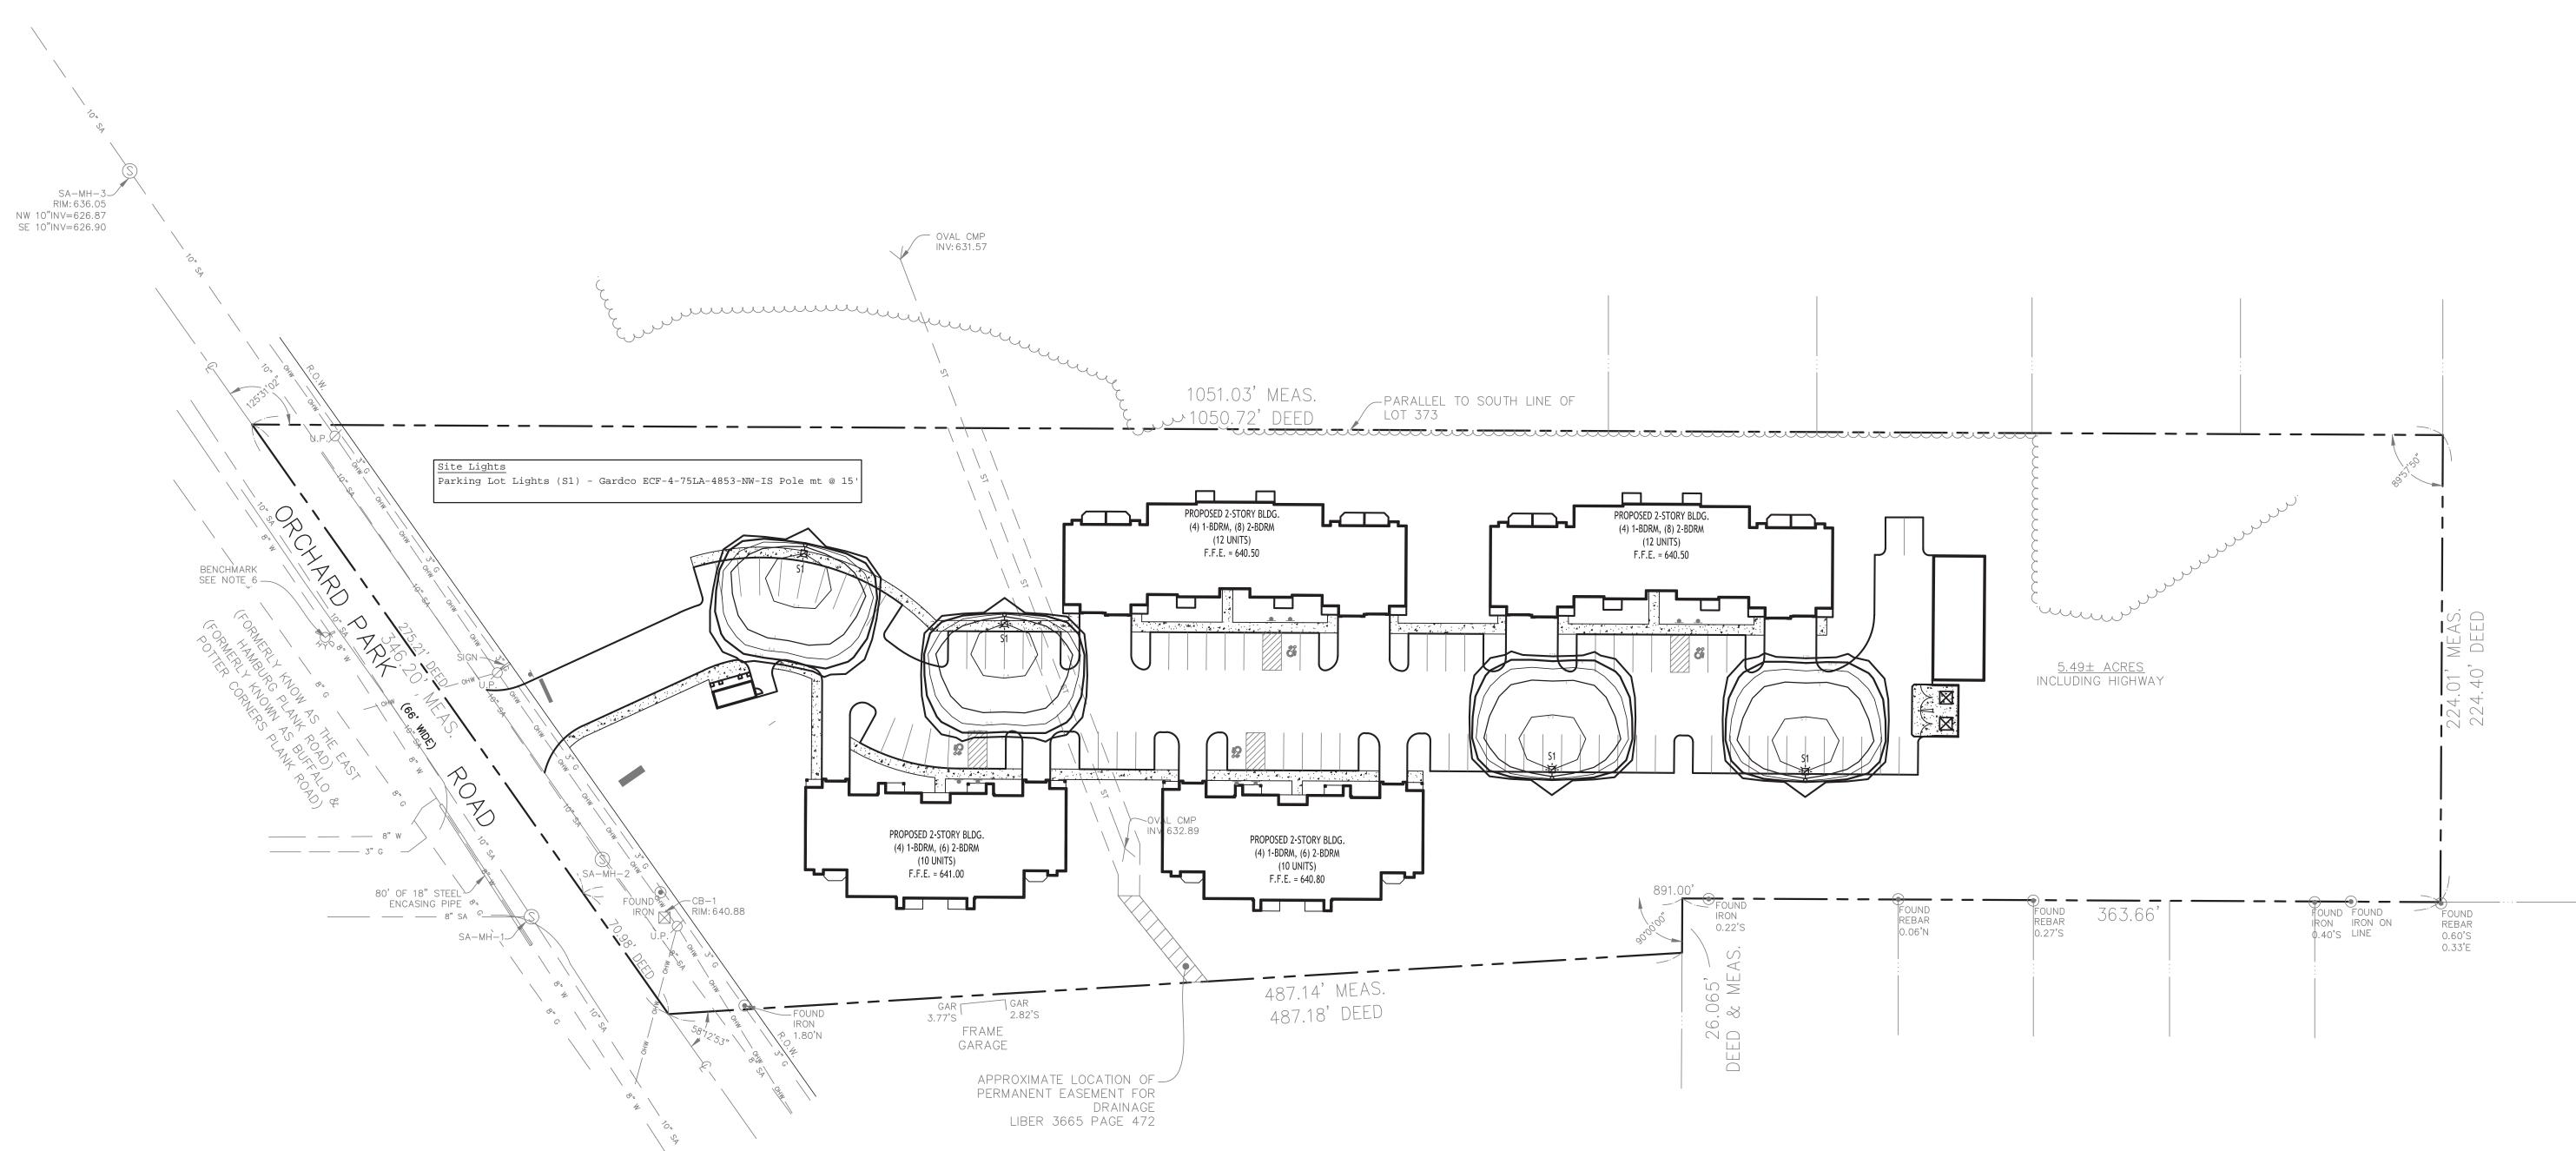
Project No: 22.128

DRAWING NAME: Lighting Plan

Drawn By: Scale:

6/21/23 A. Pandolfe As Noted DRAWING NO. Project No: 22.128

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LIGHTING PLAN