
# **Project Drawings For**

# The Broadway Group West Seneca Site

West Seneca (T.), Erie (Co.) New York

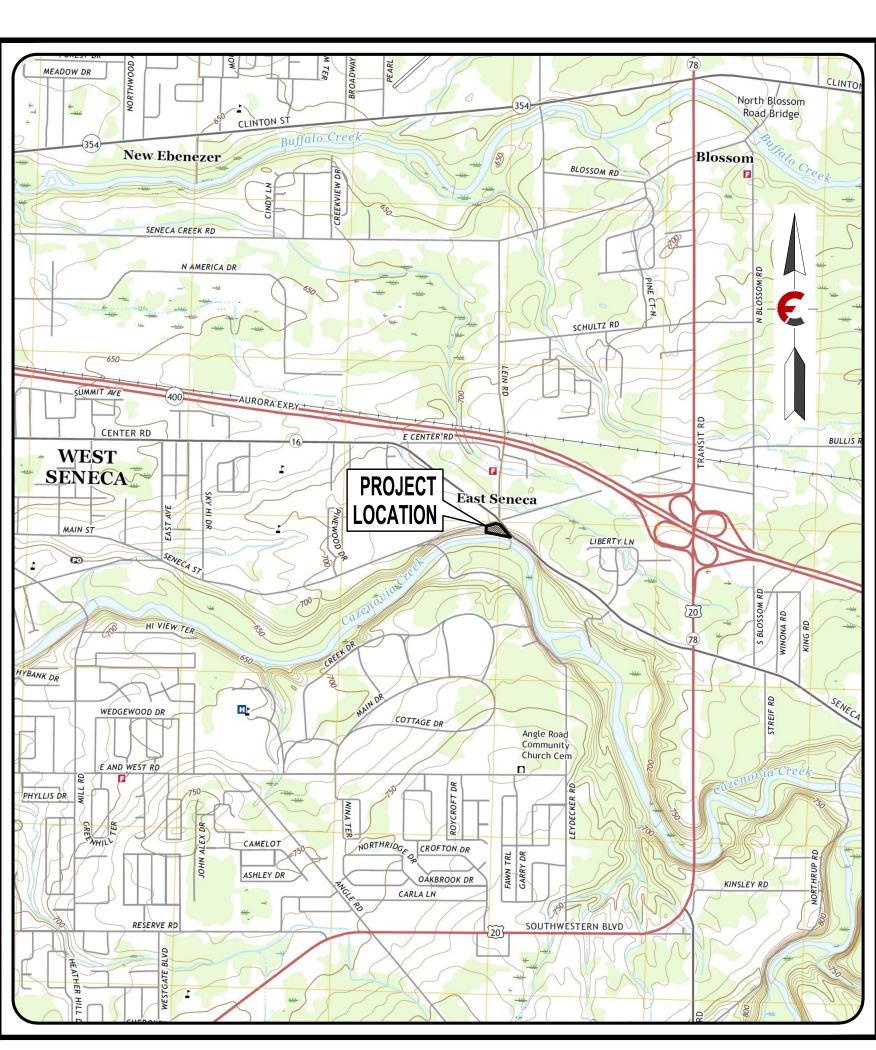

**LOCATION MAP** 

October 2020 Last Revised: January 8, 2021

# PREPARED FOR:

The Broadway Group, LLC 216 West Side Square Huntsville, AL 35801

# PREPARED LOCATION:


The Broadway Group West Seneca Site

5203 Seneca Street West Seneca, NY 14224 Tax Map Parcel: 135.20-1-3

	INDEX OF DRAWINGS
NO.	TITLE
<b>C1</b>	DEMOLITION PLAN
C2	SITE PLAN
C3	GRADING PLAN
C4	UTILITY PLAN
<b>C</b> 5	LANDSCAPING PLAN
<b>C6</b>	CIVIL DETAILS
<b>C7</b>	CIVIL DETAILS
<b>C8</b>	CIVIL DETAILS
C9	E & S PLAN
<b>C10</b>	E & S DETAILS

TRUCK ACCESS

**C11** 

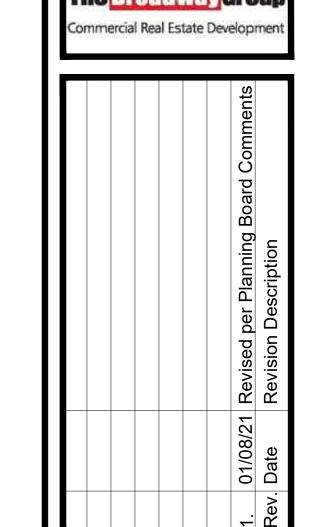

It is A Violation Of The New York ducation Law, Article 145 Section 7209, For Any Person, Unless He Is Acting Under The Direction Of A Licensed rofessional Engineer Or Land Surveyor o Alter An Item In Any Way. If An Item Bearing The Seal Of An Engineer Or Land Surveyor Is Altered, The Altering ngineer Or Land Surveyor Shall Affix To The Item His Seal And The Notation 'Altered By' Followed By His Signature and The Date Of Such Alteration, And Specific Description Of The Alteration.


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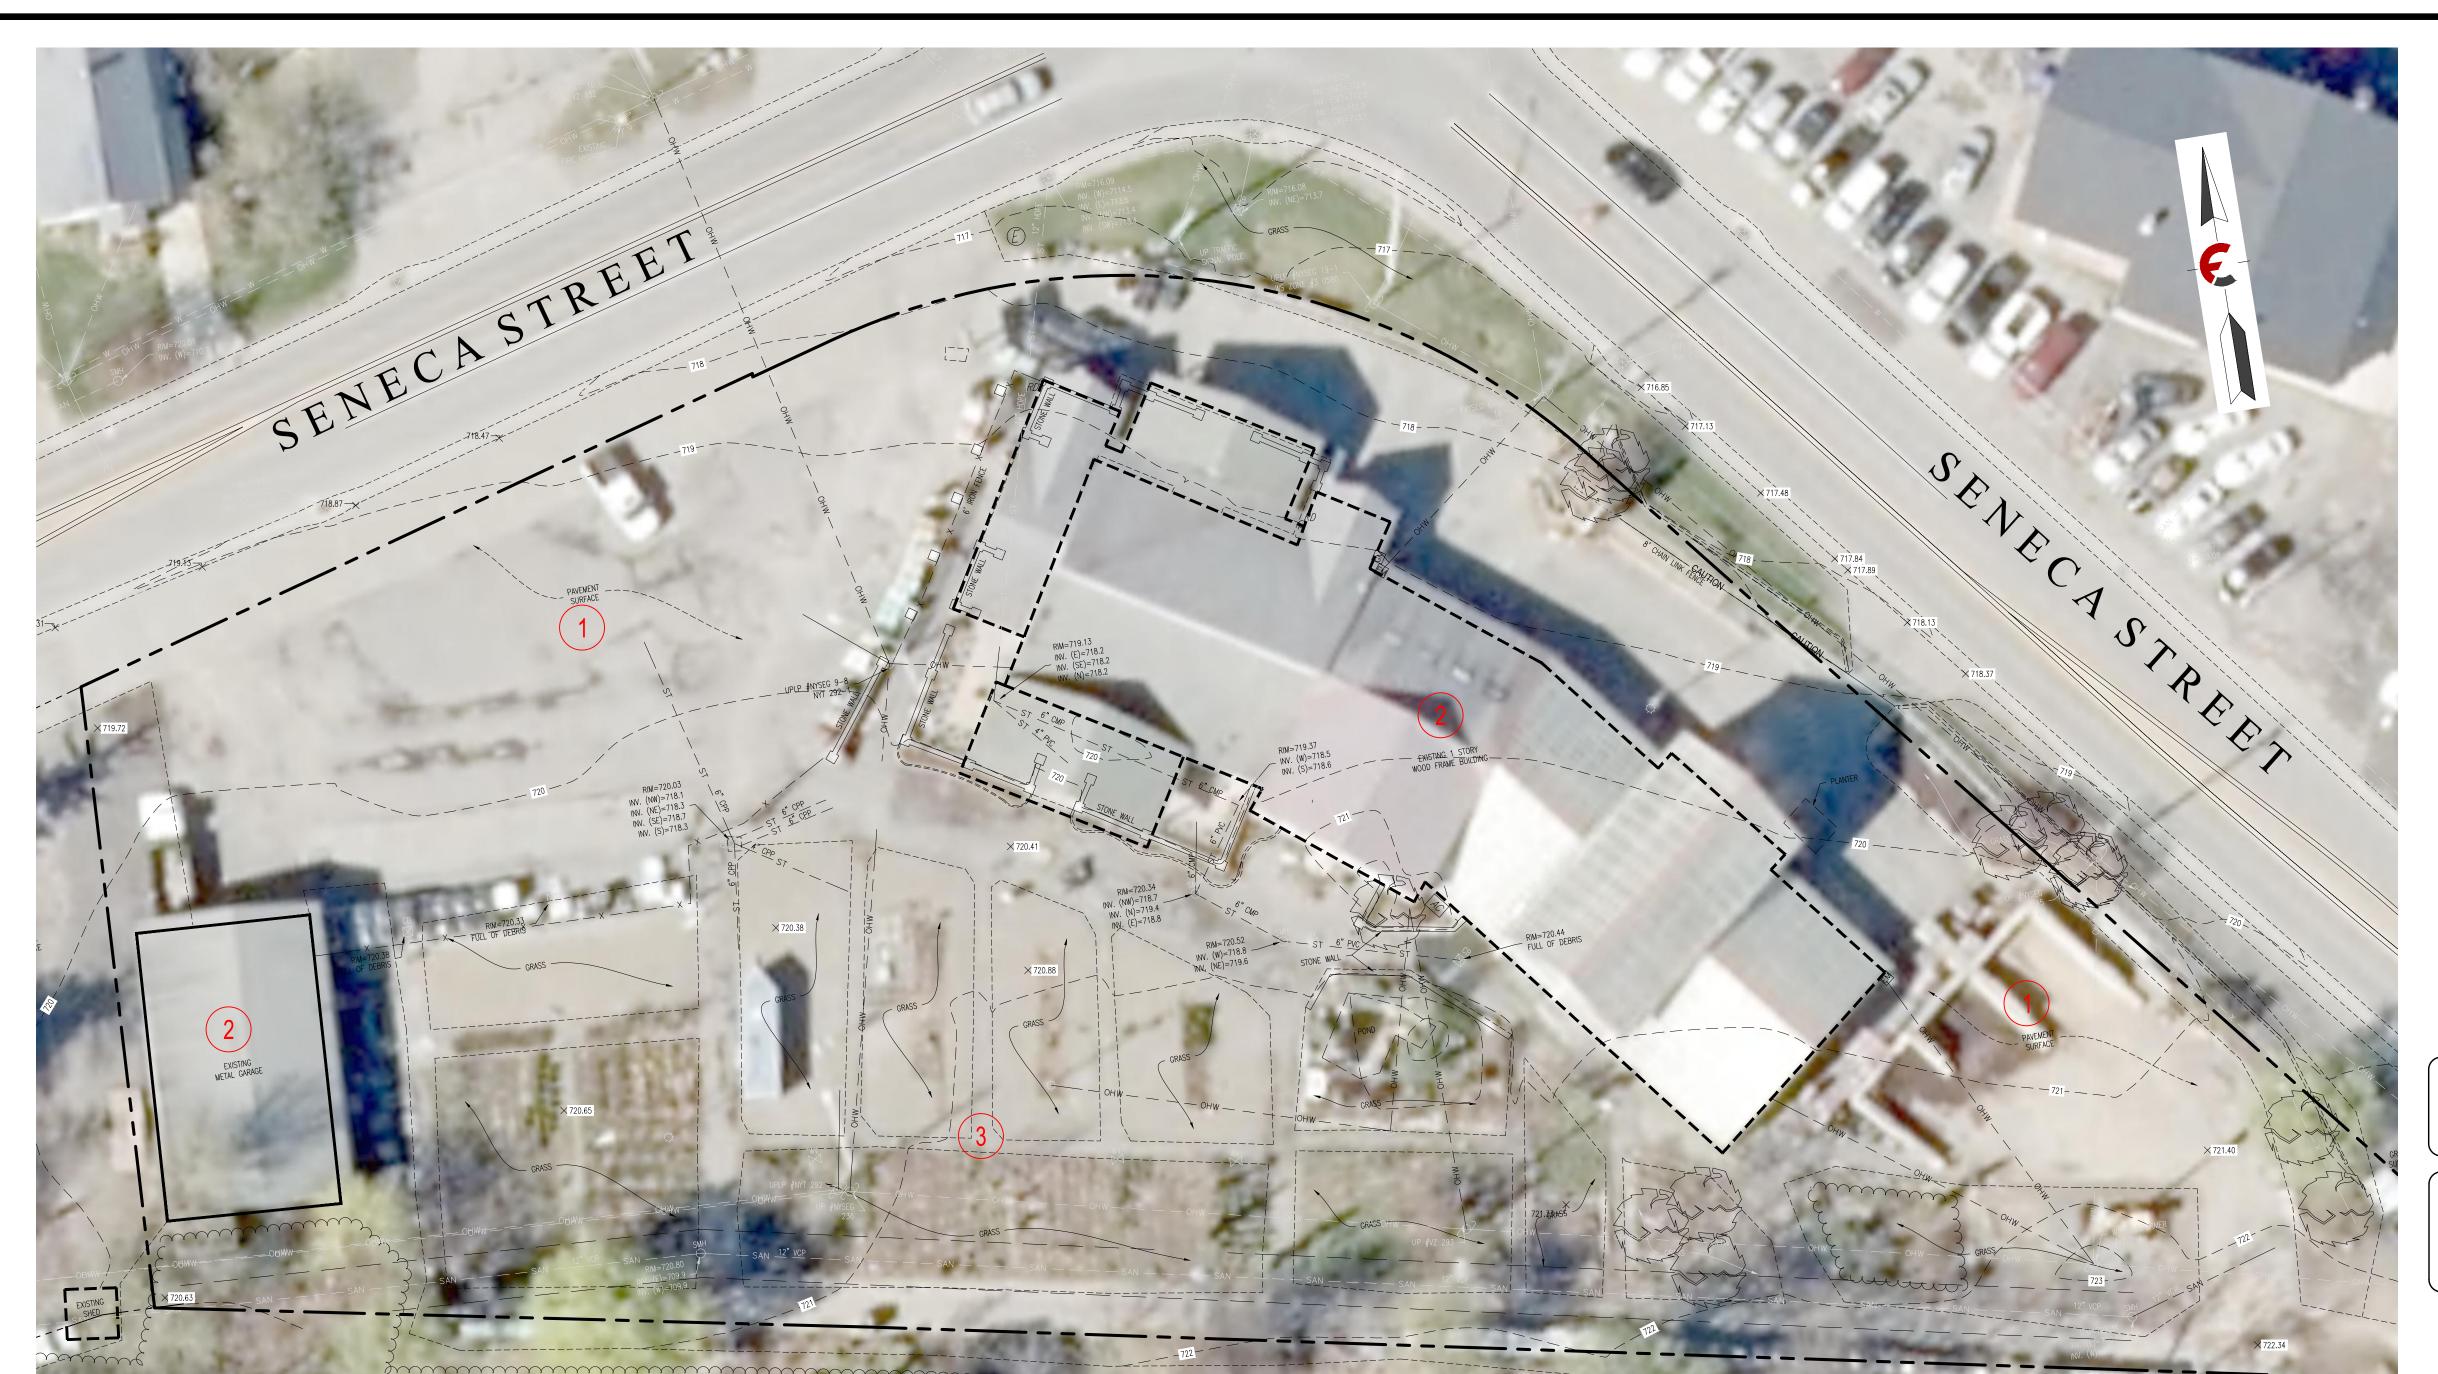



- 1	Scale:	As Noted
	11x17	Prints are 1/2 Size
- 1	Date:	October 2020
	Design By:	BMG
/	Drawn By:	BMG, CEL
ı	Checked By:	KMS
	Project No.:	2017.023.028
	Drawing Name:	17023.028-a.dwg
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CO

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- LEGEND

Note:
Utility information has been plotted from available sources and their locations and size should be considered approximate only. The contractor is responsible for determining exact utility locations, sizes, and elevations prior to commencing construction. If uncharted or misplotted utilities are encountered, the contractor is required to notify the owner immediately.

New York State law requires excavators to contact the one-call notification system prior to digging to prevent damage to buried facilities.
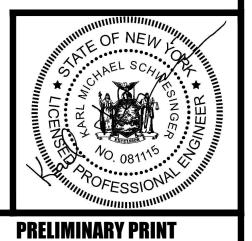
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1-800-962-7962
Dig Safely New York
(non-members must be contacted separately)

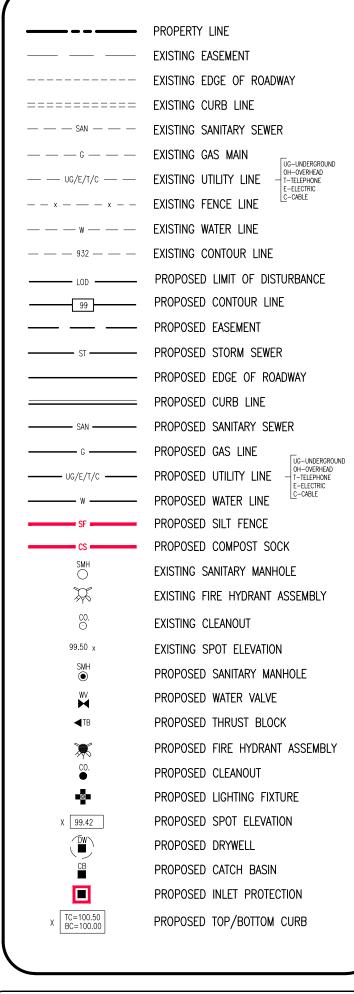
0 20' SCALE: 1" = 20'

#### GENERAL DEMOLITION NOTES:

- 1. THE SITE WORK FOR THIS PROJECT SHALL MEET OR EXCEED THE PLAN SET AND PROJECT SPECIFICATIONS.
- 2. CONTRACTOR SHALL BE RESPONSIBLE FOR REMOVAL OF THE EXISTING STRUCTURES, RELATED UTILITIES, PAVING, UNDERGROUND STORAGE TANKS, AND ANY OTHER EXISTING IMPROVEMENTS AS NOTED. SEE SITE WORK SPECIFICATIONS.
- 3. CONTRACTOR IS TO REMOVE AND DISPOSE OF ALL DEBRIS. RUBBISH AND OTHER MATERIALS RESULTING FROM PREVIOUS AND CURRENT DEMOLITION OPERATIONS. DISPOSAL WILL BE IN ACCORDANCE WITH ALL LOCAL STATE AND/OR FEDERAL REGULATIONS GOVERNING SUCH OPERATIONS.
- 4. THE GENERAL CONTRACTOR SHALL TAKE ALL PRECAUTIONS NECESSARY TO AVOID PROPERTY DAMAGE TO ADJACENT PROPERTIES DURING THE CONSTRUCTION PHASES OF THIS PROJECT. THE CONTRACTOR WILL BE HELD SOLELY RESPONSIBLE FOR ANY DAMAGES TO THE ADJACENT PROPERTIES OCCURRING DURING THE CONSTRUCTION PHASES OF THIS PROJECT.
- 5. THE CONTRACTOR IS SPECIFICALLY CAUTIONED THAT THE LOCATION AND/OR ELEVATION OF EXISTING UTILITIES AS SHOWN ON THESE PLANS IS BASED ON RECORDS OF THE VARIOUS UTILITY COMPANIES AND WHERE POSSIBLE MEASUREMENTS TAKEN IN THE FIELD. THE INFORMATION IS NOT TO BE RELIED ON AS BEING EXACT OR COMPLETE. THE CONTRACTOR MUST CALL THE APPROPRIATE UTILITY COMPANY AT LEAST 48 HOURS BEFORE ANY EXCAVATION TO REQUEST EXACT FIELD LOCATION OF UTILITIES. IT SHALL BE THE RESPONSIBILITY OF THE CONTRACTOR TO RELOCATE ALL EXISTING UTILITIES WHICH CONFLICT WITH THE PROPOSED IMPROVEMENTS SHOWN ON THE PLANS.

#### DEMOLITION NOTES (①):

- 1. EXISTING PAVEMENT PARKING AREAS AND SIDEWALKS TO BE REMOVED.
- 2. EXISTING BUILDING AND ACCESSORIES TO BE REMOVED.
- 3. EXISTING GRAVEL AND STONE AREAS TO BE REMOVED.

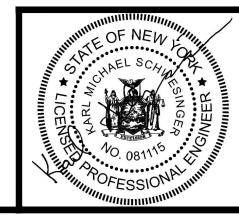

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It Is A Violation Of The New York Education Law, Article 145 Section 7209, For Any Person, Unless He Is Acting Under The Direction Of A Licensed							

Professional Engineer Or Land Surveyor
To Alter An Item In Any Way, If An Item
Bearing The Seal Of An Engineer Or
Land Surveyor Is Altered, The Altering
Engineer Or Land Surveyor Shall Affix To
The Item His Seal And The Notation
"Altered By" Followed By His Signature
And The Date Of Such Alteration, And
A Specific Description Of The Alteration.

The Broadway Group
West Seneca (T.), Erie (Co.) New York



Fax (607) 734-2169

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 Date:
 October 2020

 Design By:
 BMG

 Drawn By:
 BMG, CEL

 Checked By:
 KMS

 Project No.:
 2017.023.028

 Drawing Name:
 17023.028-a.dwg

EXISTING CONDITIONS



	FROFEITT LINE
	EXISTING EASEMENT
	EXISTING EDGE OF ROADWAY
========	EXISTING CURB LINE
— — — SAN — — —	EXISTING SANITARY SEWER
G	EXISTING GAS MAIN
—— — UG/E/T/C —— —	EXISTING UTILITY LINE OH-OVERHEAD T-TELEPHONE E-ELECTRIC
x x	EXISTING FENCE LINE
— — w — — —	EXISTING WATER LINE
— — — 932 — — —	EXISTING CONTOUR LINE
LOD	PROPOSED LIMIT OF DISTURBANCE
99	PROPOSED CONTOUR LINE
	PROPOSED EASEMENT
ST	PROPOSED STORM SEWER
	PROPOSED EDGE OF ROADWAY
	PROPOSED CURB LINE
SAN	PROPOSED SANITARY SEWER
G	PROPOSED GAS LINE
UG/E/T/C	PROPOSED UTILITY LINE - OH-OVERHEAD T-TELEPHONE E-ELECTRIC
w	PROPOSED WATER LINE
SF	PROPOSED SILT FENCE
CS	PROPOSED COMPOST SOCK
SMH	EXISTING SANITARY MANHOLE
H	EXISTING FIRE HYDRANT ASSEMBLY
co. ⊙	EXISTING CLEANOUT
99.50 x	EXISTING SPOT ELEVATION
SMH	PROPOSED SANITARY MANHOLE
wv	PROPOSED WATER VALVE
<b>∢</b> TB	PROPOSED THRUST BLOCK
	PROPOSED FIRE HYDRANT ASSEMBLY
CO. ●	PROPOSED CLEANOUT
	PROPOSED LIGHTING FIXTURE
X 99.42	PROPOSED SPOT ELEVATION
(DW)	PROPOSED DRYWELL
CB	PROPOSED CATCH BASIN
▣	PROPOSED INLET PROTECTION
X TC=100.50 BC=100.00	PROPOSED TOP/BOTTOM CURB

LEGEND

PROPERTY LINE

Utility information has been plotted from available sources and their locations and size should be considered approximate only. The contractor is responsible for determining exact utility locations, sizes, and elevations prior to commencing construction. If uncharted or misplotted utilities are encountered, the contractor is required to notify the owner immediately.

New York State law requires excavators to contact the one-call notification system prior to digging to prevent damage to buried facilities.


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ESTIMATED SITE QUANTITIES						
DESCRIPTION	YTITY		UNIT			
CONCRETE SIDEWAL	K 1,4	179		SF		
STANDARD DUTY ASPHALT PAVING	5,7	768		SF		
HEAVY DUTY ASPHALT PAVING	16,	788		SF		
HEAVY DUTY CONCRETE PAVING	6	21		SF		
ESTIMA	ATED R.O	.W. QUA	NTI	TIES		
DESCRIPTION	YTITY		UNIT			
STANDARD DUTY ASPHALT PAVING	-	_		SF		
HEAVY DUTY ASPHALT PAVING	15	1594 SF		SF		
	PARKIN	G RATIC	)			
В	JILDING SQ.	REQUIRE	ΞD	PROVIDED		

31

1 PER 300 SQ. FT. OF TOTAL AREA

30

9,100

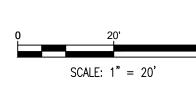TOTAL

REQUIRED

PARKING RATIO

STRIPING	LEGEND
YELLOW CURBING AND BOLLARDS — PARKING LOT	SURFACES SHOULD BE CLEAN, DRY AND METAL SURFACES FREE OF HEAVY RUST 2 COATS SHERWIN WILLIAMS — KEM 4000 ACRYLIC ALKYD ENAMEL SAFETY YELLOW B55Y300
STRIPING — PARKING LOT	SURFACES SHOULD BE CLEAN, DRY. TOP COAT SHERWIN WILLIAMS — PROMAR TRAFFIC MARKING PAINT YELLOW TM5495
HANDICAP STRIPING — PARKING LOT	SURFACES SHOULD BE CLEAN, DRY. TOP COAT SHERWIN WILLIAMS – PROMAR TRAFFIC MARKING PAINT "H.C." BLUE

#### GENERAL UTILITY NOTES:

- 1. ALL WATER LINES SHALL BE TYPE K COPPER WITH 5' MIN. COVER.
- 2. ALL BUILDING SANITARY SEWER LINES SHALL BE SDR-26 PVC WITH 5' MIN. COVER. ALL MAIN SANITARY SEWER LINES SHALL BE C-900 PVC WITH 5' MIN. COVER.
- 3. CONTRACTOR SHALL COORDINATE ANY DISRUPTIONS TO EXISTING UTILITY SERVICES WITH ADJACENT PROPERTY OWNERS.
- 4. ALL ELECTRIC, TELEPHONE, AND GAS EXTENSIONS INCLUDING SERVICE LINES SHALL BE CONSTRUCTED TO THE APPROPRIATE UTILITY COMPANY SPECIFICATIONS. ALL UTILITY DISCONNECTIONS SHALL BE COORDINATED WITH THE DESIGNATED UTILITY COMPANIES.
- 5. CONSTRUCTION SHALL NOT START ON ANY PUBLIC UTILITY SYSTEM UNTIL WRITTEN APPROVAL HAS BEEN RECEIVED BY THE ENGINEER FROM THE APPROPRIATE GOVERNING AUTHORITY AND CONTRACTOR HAS BEEN NOTIFIED BY THE ENGINEER.
- 6. PRIOR TO THE CONSTRUCTION OF OR CONNECTION TO ANY STORM DRAIN, SANITARY SEWER, WATER MAIN, OR ANY OF THE DRY UTILITIES. THE CONTRACTOR SHALL EXCAVATE, VERIFY, AND CALCULATE ALL POINTS OF CONNECTION AND ALL UTILITY CROSSINGS AND INFORM FAGAN ENGINEERS & LAND SURVEYORS, P.C. AND THE OWNER/DEVELOPER OF ANY CONFLICT OR REQUIRED DEVIATIONS FROM THE PLAN. NOTIFICATION SHALL BE MADE A MINIMUM OF 48 HOURS PRIOR TO CONSTRUCTION. FAGAN ENGINEERS & LAND SURVEYORS, P.C. AND ITS CLIENTS SHALL BE HELD HARMLESS IN THE EVENT THAT THE CONTRACTOR FAILS TO MAKE SUCH NOTIFICATION.
- UNLESS OTHERWISE SHOW, CALLED OUT OR SPECIFIED HEREON OR WITHIN SPECIFICATIONS: ALL WATER LINE PIPE BEDDING AND SANITARY SEWER PIPE BEDDING SHALL BE INSTALLED PER TYPICAL PIPE TRENCH DETAIL ON SHEET C7.
- 8. FOR LIGHTING REQUIREMENTS SEE ES1.

#### GENERAL SITE NOTES:


- 1. ALL DIMENSIONS SHOWN ARE TO THE EDGE OF PAVEMENT UNLESS OTHERWISE NOTED.
- 2. ALL CURB RETURN RADII SHALL BE 3' OR 10'. AS SHOWN TYPICAL ON THIS PLAN UNLESS OTHERWISE NOTED.
- 3. PAVEMENT SHALL BE INSTALLED OVER THE ENTIRE CUSTOMER PARKING LOT AREA AND OVER ALL TRUCK AND DELIVERY APPROACH DRIVES IN ACCORDANCE WITH THE PAVEMENT DETAILS ON SHEET C6. ALL PARKING LOT STRIPING INCLUDING ACCESSIBLE AND VAN ACCESSIBLE SPACES SHALL BE PAINTED PER DETAIL ON SHEET C6.
- 4. ALL PARKING LOT SIGN BASE SUPPORTS SHALL BE INSTALLED PER TYPICAL SIGN INSTALLATION ON SHEET C8.
- 5. ALL ACCESSIBLE PARKING STALLS SHALL HAVE SIGNAGE INSTALLED PER ACCESSIBLE PARKING SIGN DETAIL ON SHEET C6.
- 6. GENERAL CONTRACTOR IS RESPONSIBLE FOR VERIFYING POSTAL DELIVERY METHOD WITH LOCAL JURISDICTION IF A PHYSICAL MAILBOX IS REQUIRED. GENERAL CONTRACTOR IS RESPONSIBLE FOR THE PURCHASE, LOCATION, PLACEMENT, AND INSTALLATION.
- 7. DRIVEWAY CONSTRUCTION WITHIN ROAD RIGHT-OF-WAY SHALL ME JURISDICTIONAL REQUIREMENTS.
- 8. WATER WELL DESIGN FROM LICENSED INSTALLED SHALL BE PROVIDED FOR OWNERS REVIEW AND APPROVAL PRIOR TO INSTALLATION.
- 9. ALL WORK ZONE TRAFFIC CONTROLS SHALL CONFORM TO THE 2009 MANUAL OF UNIFORM TRAFFIC CONTROL DEVICES (MUTCD). THE CURRENT NEW YORK STATE SUPPLEMENT, NYSDOT STANDARD SPECIFICATIONS, NYSDOT STANDARD SHEETS, AND NYSDOT WORK ZONE TRAFFIC CONTROL MANUAL DATED JANUARY 2012.
- 10. PROPOSED STOP BAR PAVEMENT MARKINGS AND STOP SIGN SHALL NOT BE INSTALLED WITHIN NYSDOT RIGHT-OF-WAY.

## **ZONING INFORMATION**

ZONING DISTRICT - C-2 COMMERCIAL DISTRICT TAX MAP # 135.20-1-3

<b>REQUIRED</b>	<b>PROPOSED</b>
40'	66'
30'	30'
10'	156'
40'	18'
55	30*
	40' 30' 10' 40'

\*OWNER IS SEEKING AREA VARIANCE FOR REQUIRED PARKING STALLS

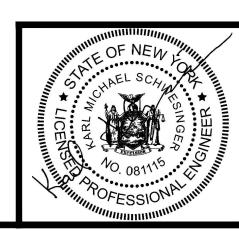

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	<del>-</del>	01/08/21	01/08/21 Revised per Planning Board Comments
200	Rev.	Rev. Date	Revision Description

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Under The Direction Of A Licensed
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And The Date Of Such Alteration, And
A Specific Description Of The Alteration.

The Broadway Group
West Seneca (T.), Erie (Co.) New York



Phone (607) 734-2165

Fax (607) 734-2169

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 Design By:
 BMG


 Drawn By:
 BMG, CEL


 Checked By:
 KMS

 Project No.:
 2017.023.028

 Drawing Name:
 17023.028-a.dwg

SITE PLAN

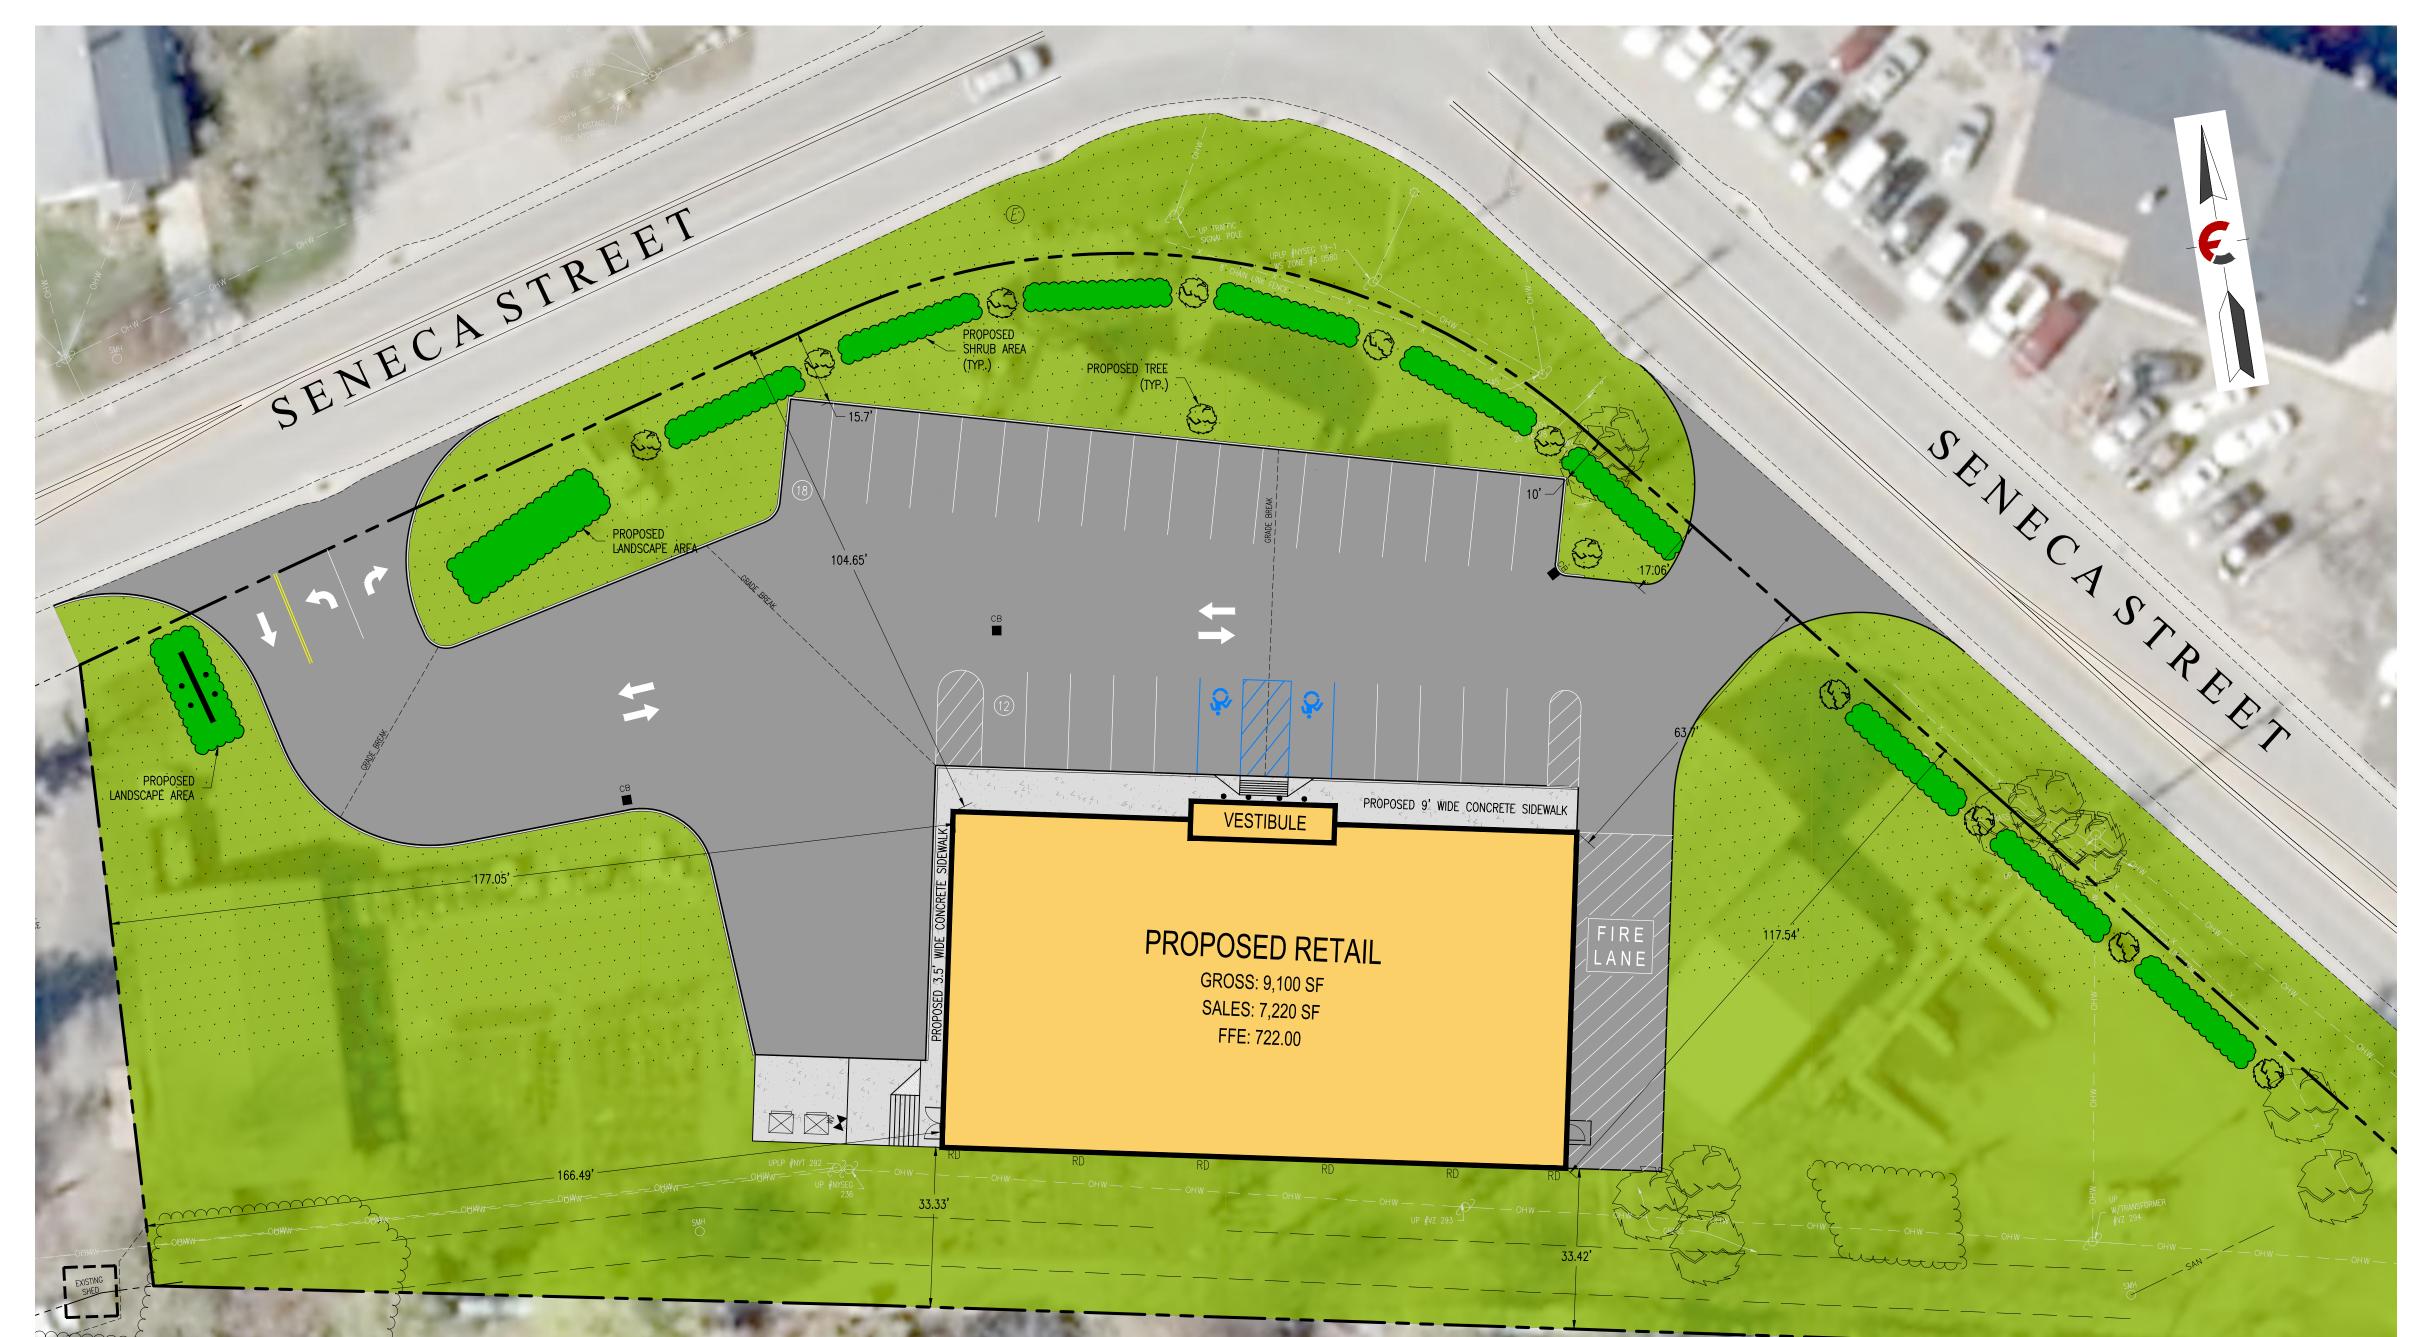

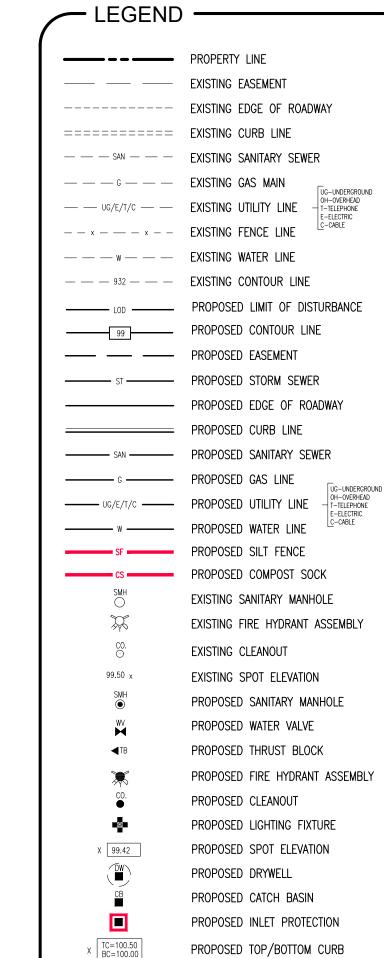

Note:

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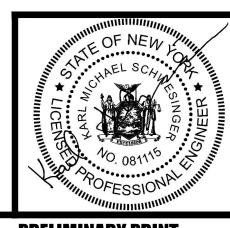
(non-members must be contacted separately)

0 20' SCALE: 1" = 20'

ZONING INFORMATION
ZONING DISTRICT - C-2 COMMERCIAL DISTRICT
TAX MAP # 135.20-1-3

	<u>REQUIRED</u>	<u>PROPOSED</u>	
<b>BUILDING SETBACK</b>			
FRONT YARD	40'	63'	
REAR YARD	30'	33'	
SIDE YARD	10'	166'	
MAX. BUILDING HEIGHT	40'	18'	
OFF STREET PARKING	55	30*	

\*OWNER IS SEEKING AREA VARIANCE FOR REQUIRED PARKING STALLS



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The Item His Seal And The Notation

"Altered By" Followed By His Signature And The Date Of Such Alteration, And

A Specific Description Of The Alteration

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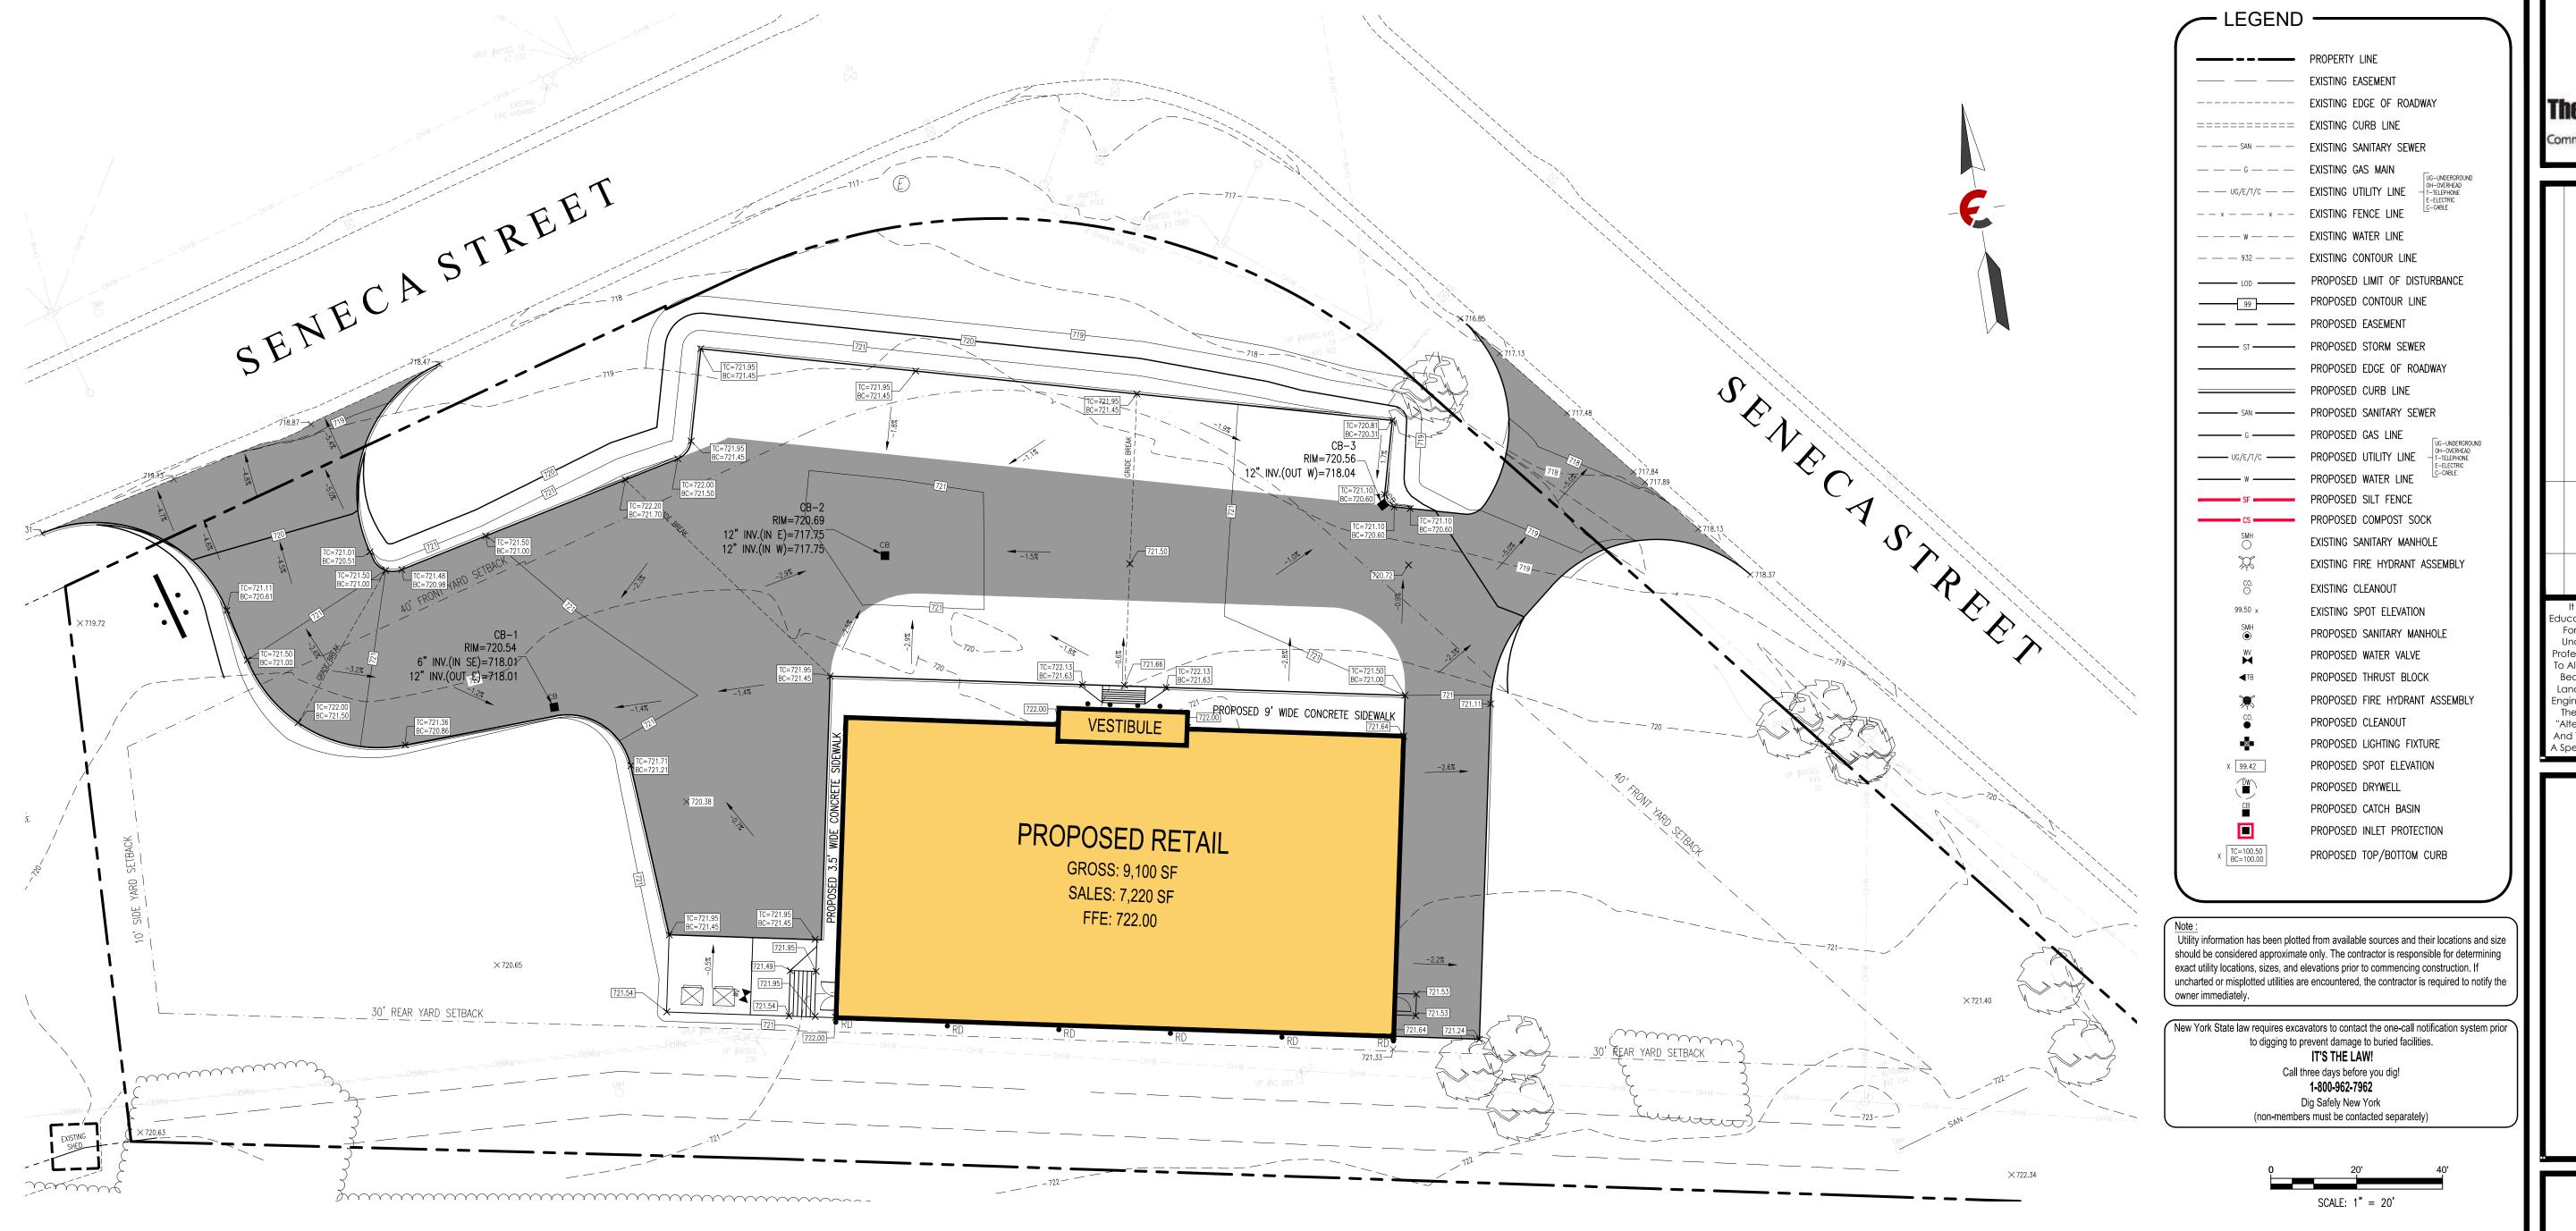
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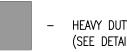
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BUILDING SETBACK PLAN

C2A



ESTIMATED GRADING QUANTITIES							
DESCRIPTION		UNIT					
FILL	1546.10	CY					
CUT	13.18	CY					
NET (FILL)	1532.92	CY					



HEAVY DUTY PAVEMENT (SEE DETAIL SHEET C6)

#### **GENERAL GRADING NOTES:**

- 1. PRIOR TO INSTALLATION OF STORM OR SANITARY SEWER, THE CONTRACTOR SHALL EXCAVATE, VERIFY, AND CALCULATE ALL CROSSINGS AND INFORM THE OWNER AND THE ENGINEER OF ANY CONFLICTS PRIOR TO CONSTRUCTION. THE ENGINEER WILL BE HELD HARMLESS IN THE EVENT THE ENGINEER IS NOT NOTIFIED OF DESIGN CONFLICTS.
- 2. ALL SLOPES AND AREAS DISTURBED BY CONSTRUCTION SHALL BE GRADED SMOOTH AND 4" OF TOPSOIL APPLIED. IF ADEQUATE TOPSOIL IS NOT AVAILABLE ON SITE, THE CONTRACTOR SHALL PROVIDE TOPSOIL, APPROVED BY THE OWNER, AS NEEDED. THE AREA SHALL THEN BE SEEDED, FERTILIZED, MULCHED, WATERED, AND MAINTAINED UNTIL HARDY GRASS GROWTH IS ESTABLISHED IN ALL AREAS (SEE LANDSCAPE PLAN FOR SEED MIX AND PROPER APPLICATION RATE). ANY AREAS DISTURBED FOR ANY REASON PRIOR TO FINAL ACCEPTANCE OF THE PROJECT SHALL BE CORRECTED BY THE CONTRACTOR AT NO ADDITIONAL COST TO THE OWNER.
- 3. THE CONTRACTOR IS SPECIFICALLY CAUTIONED THAT THE LOCATION AND/OR ELEVATION OF EXISTING UTILITIES AS SHOWN ON THESE PLANS IS BASED ON RECORDS OF THE VARIOUS UTILITY COMPANIES, AND WHERE POSSIBLE MEASUREMENTS TAKEN IN THE FIELD. THE INFORMATION IS NOT TO BE RELIED ON AS BEING EXACT OR COMPLETE. THE CONTRACTOR MUST CALL THE APPROPRIATE UTILITY COMPANY AT LEAST 48 HOURS BEFORE ANY EXCAVATION TO REQUEST EXACT FIELD LOCATION OF UTILITIES.

4. UNLESS OTHERWISE SHOWN, CALLED OUT, OR SPECIFIED HEREON OR WITHIN THE SPECIFICATIONS: ALL STORM DRAIN PIPE BEDDING SHALL BE INSTALLED PER TYPICAL PIPE TRENCH DETAIL ON SHEET C7. ALL STORM DRAIN PIPES ARE MEASURED FROM CENTER OF STRUCTURES AND ENDS OF FLARED END SECTIONS.



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> dway Group Broa



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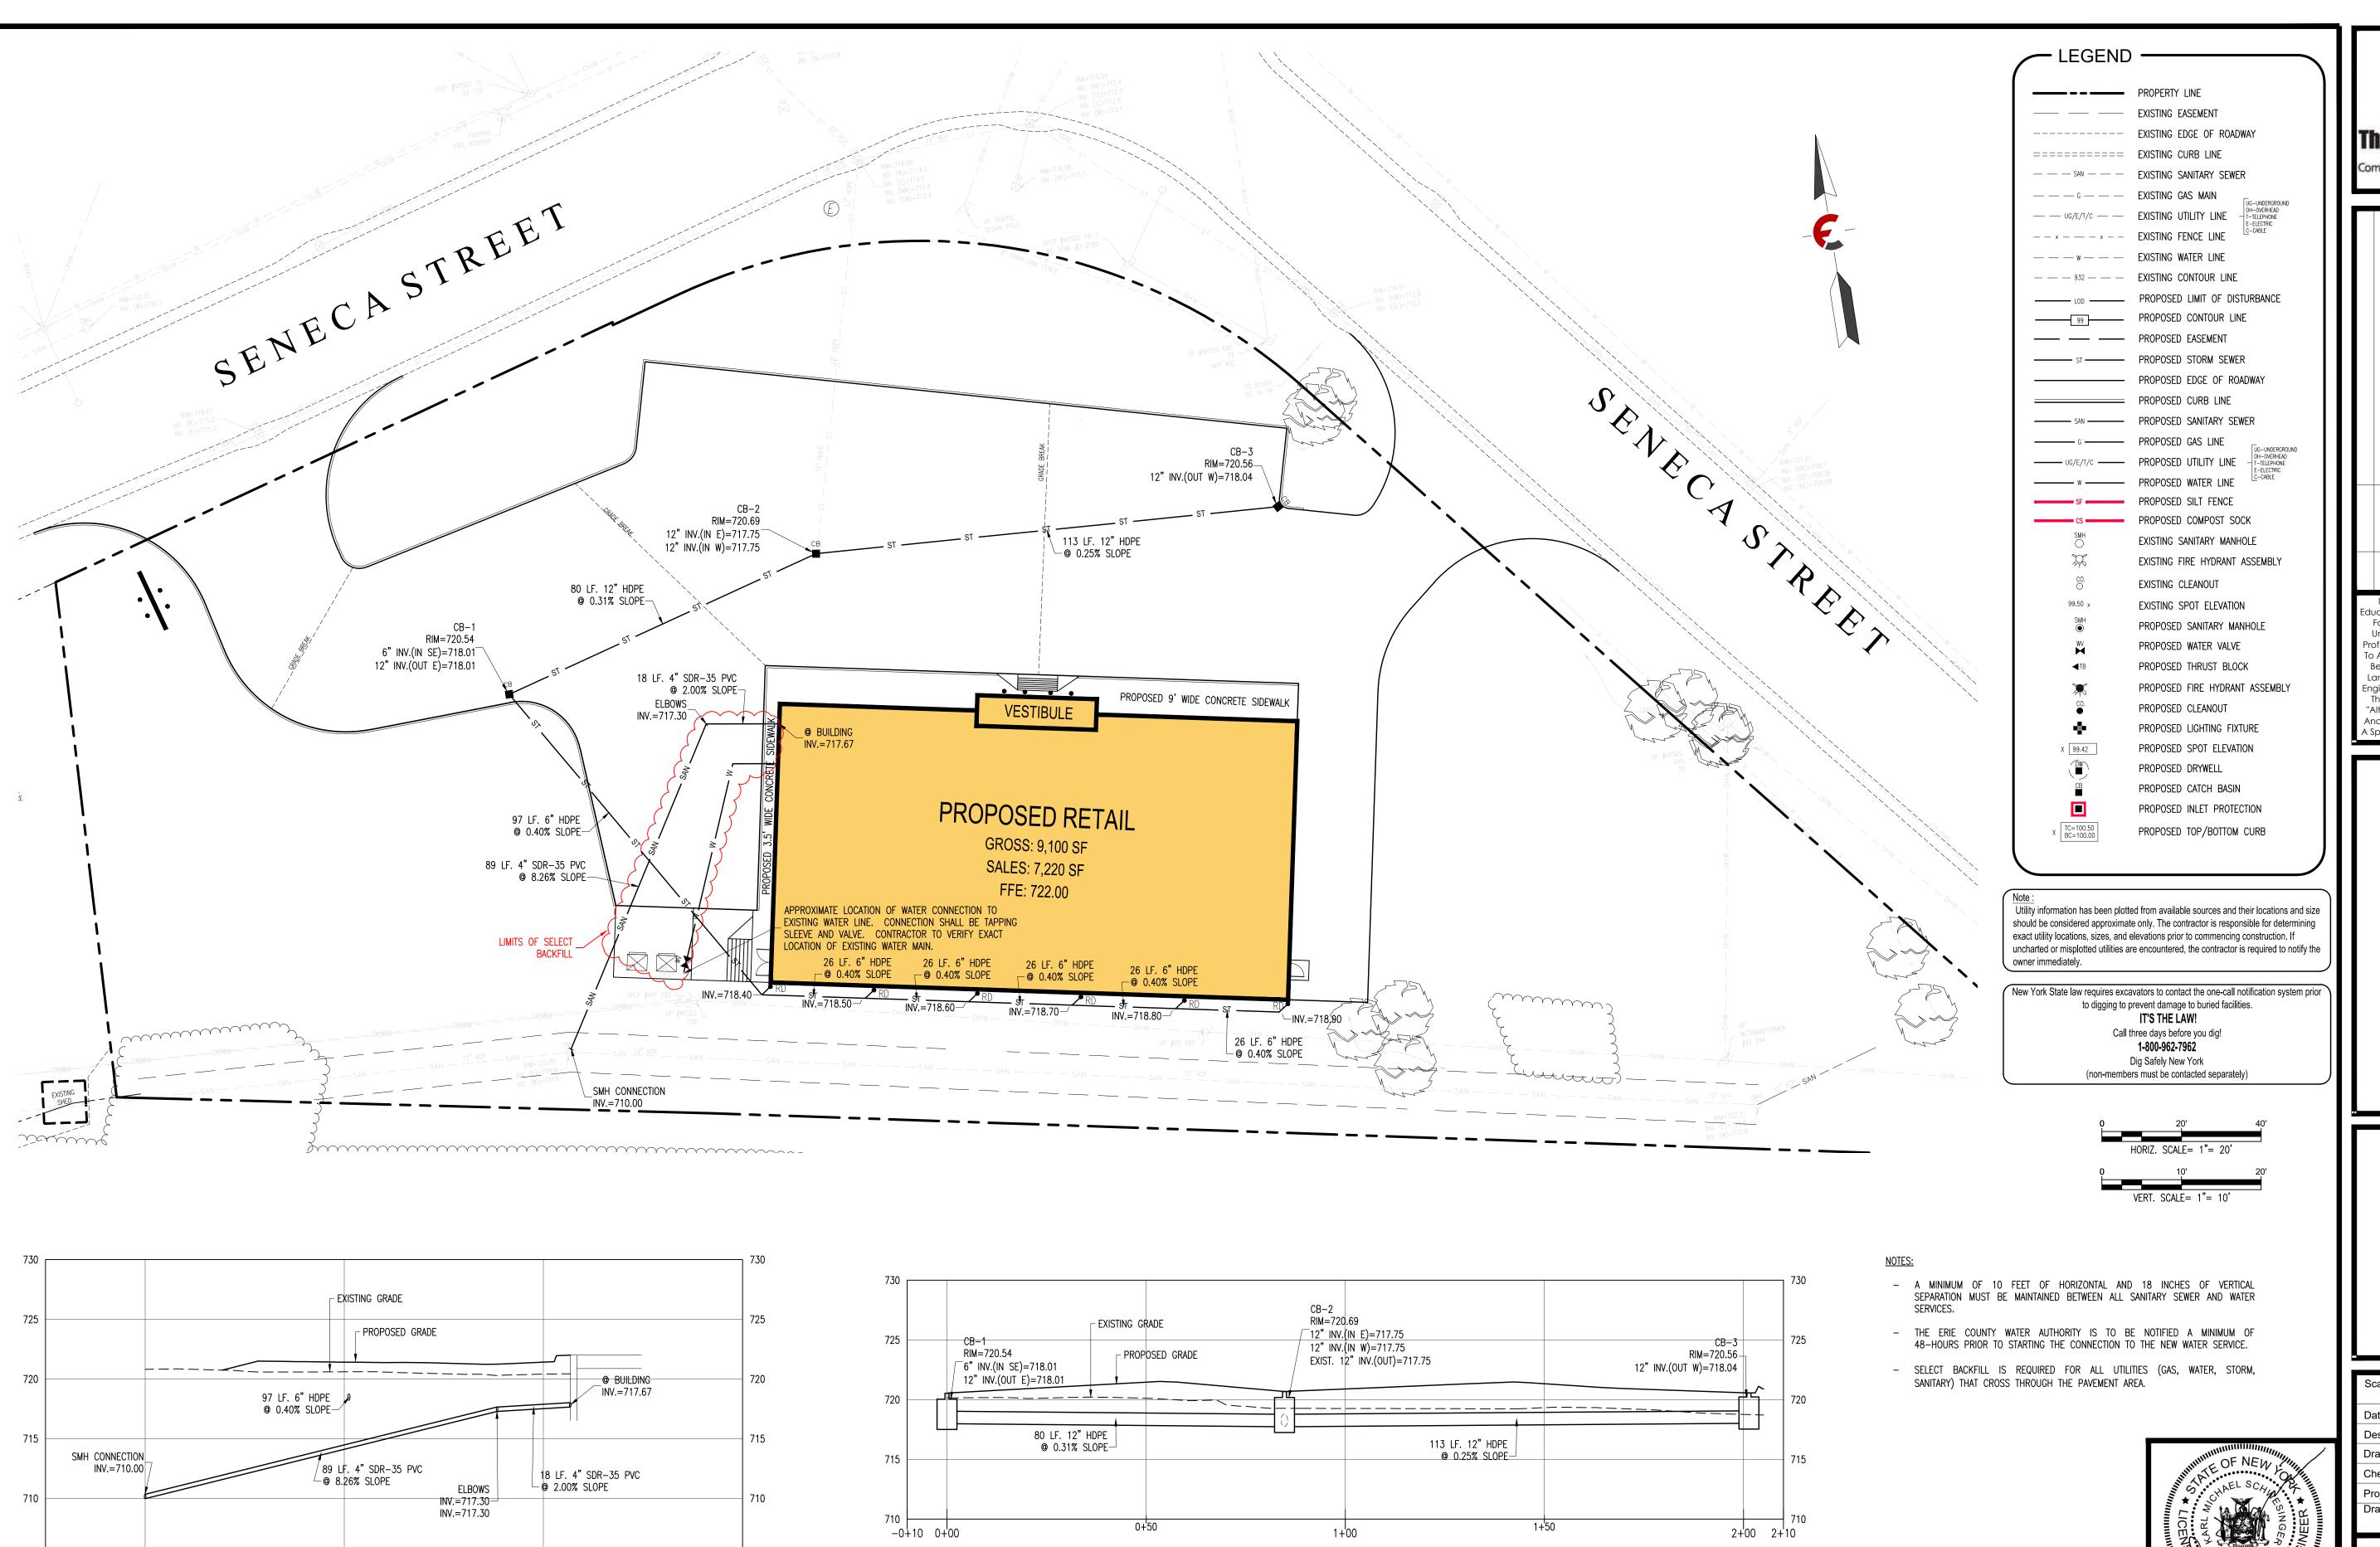
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	Drawn By:	BMG, CEL
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**GRADING PLAN** 

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STORM SEWER PROFILE

1+00

SANITARY SEWER PROFILE

1+'50

-0<del>+</del>25



						Comments	
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						01/08/21	Rev. Date
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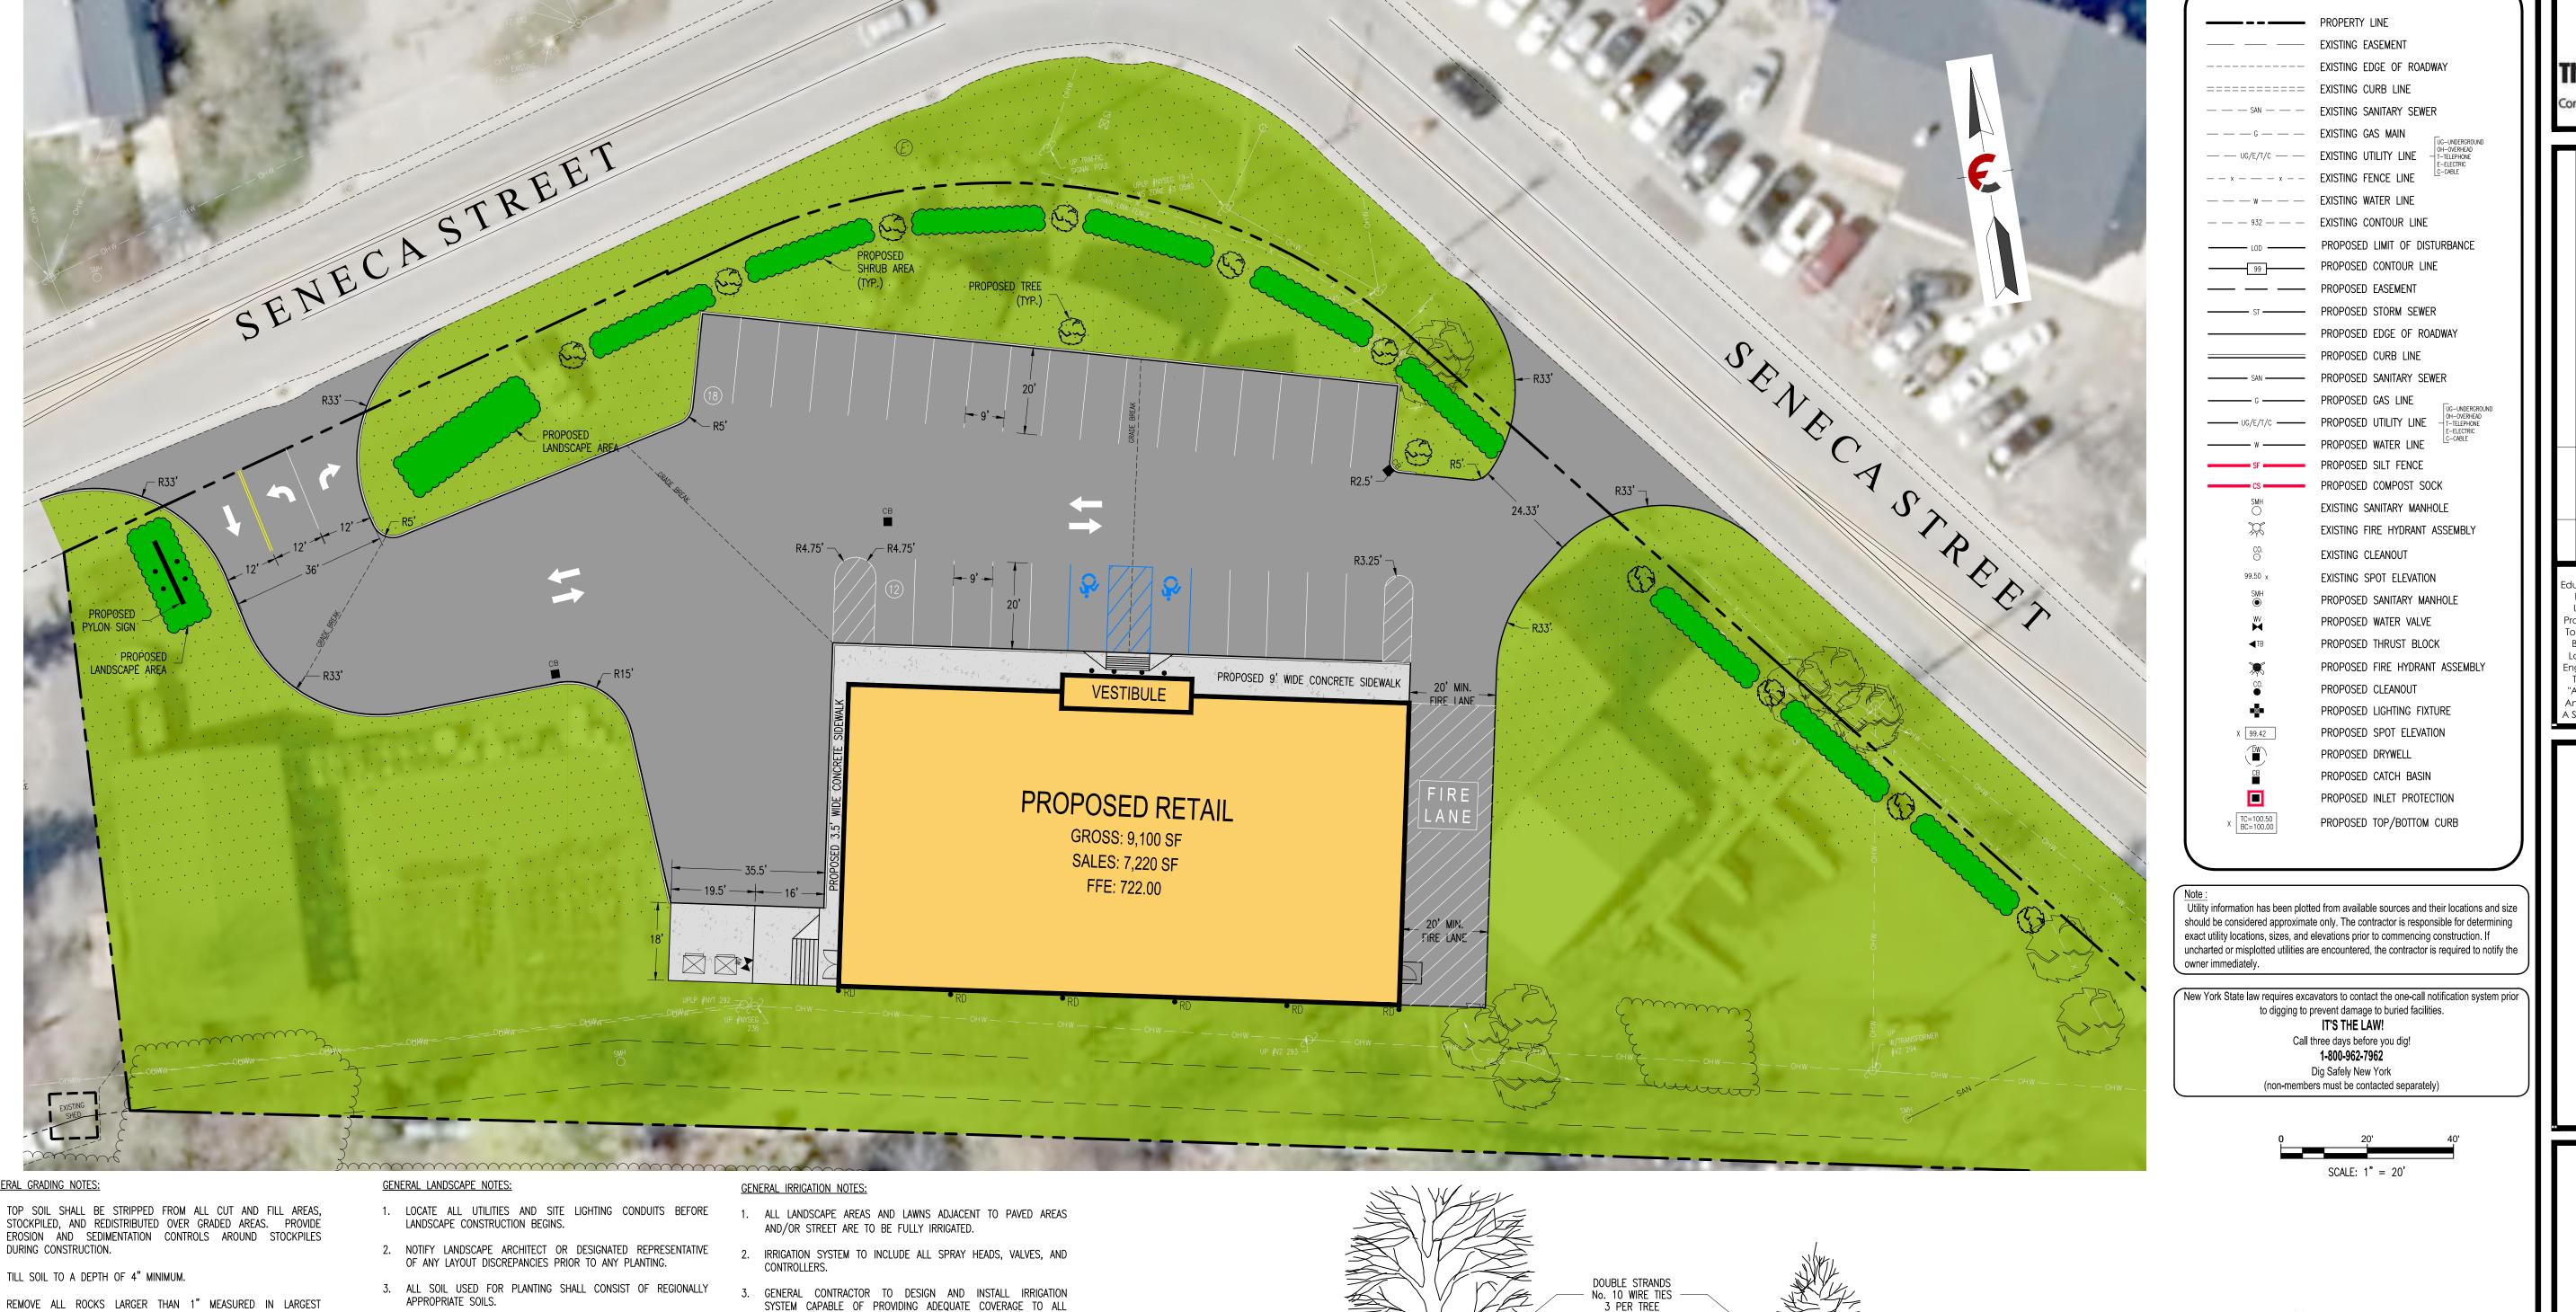
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UTILI	TY PLAN

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#### **GENERAL GRADING NOTES:**

- TILL SOIL TO A DEPTH OF 4" MINIMUM.
- REMOVE ALL ROCKS LARGER THAN 1" MEASURED IN LARGEST
- BUILDING. ALL GRADED AREAS TO RECEIVE SEED OR SOD, TOP SOIL, STRAW,
- AND WATER UNTIL A HEALTHY STAND OF GRASS IS OBTAINED.

GRADE ALL AREAS TO MAINTAIN POSITIVE SLOPE AWAY FROM

- GENERAL LAWN SEEDING AND SODDING NOTES:
- 1. ALL LAWNS FROM FACE OF THE BUILDING AND ON THE SIDE WHERE THERE IS PARKING OR A STREET ARE REQUIRED TO BE FULLY SODDED. ALL OTHER LANDSCAPE AREAS TO RECEIVE SEED.
- 2. AREAS TO RECEIVE SOD SHALL BE CLEAN OF DEBRIS AND FREE OF WEEDS.
- 3. SEED MIX TO BE DROUGHT TOLERANCE FESCUE OR REGIONAL SPECIFIC BLEND. 1/4 TO 1/3 OF THE SEED MIXTURE TO BE ANNUAL RYE TO AIDE IN LIMITING EROSION OF PERENNIAL SEED DURING GERMINATION.
- 4. STRAW SHALL BE THRESHED STRAW OF HAY, OATS, WHEAT, BARLEY, OR RYE. SPREAD AT A RATE OF 2 1/2 TONS PER ACRE. STRAW. NETTING. AND OTHER ANTI-EROSION MATERIALS TO BE REMOVED AFTER ESTABLISHED LAWN.
- MAINTENANCE SHALL BEGIN IMMEDIATELY AFTER SEEDING. WATER REGULARLY TO KEEP LAWN AREAS MOIST TO MAXIMIZE GERMINATION AND MAINTAIN OPTIMUM GROWTH AND SURVIVAL TO ACHIEVE AN ACCEPTABLE STAND OF ESTABLISHED LAWN PRIOR TO THE STORE POSSESSION DATE, FREE OF ERODED OR BARE AREAS.

- AS CALLED OUT ON THE PLAN. 5. FERTILIZE ALL PLANTS AT THE TIME OF PLANTING WITH A TIME

4. ALL DISTURBED AREAS AS DESIGNATED ON THE GRADING PLAN


SHALL HAVE 4" TOPSOIL AND BE RESTORED WITH SEED OR SOD

- RELEASE FERTILIZER PER MANUFACTURER'S SPECIFIED APPLICATION
- 6. SEE GRADING PLAN FOR APPLICATION OF TOPSOIL AND MAINTENANCE OF SODDED/SEEDED AREAS.
- ALL PLANTING BEDS SHALL HAVE A MINIMUM 3" DEPTH OF MULCH WITH EDGING AS REQUIRED, AND SHALL ALSO HAVE A WATER PERMEABLE WEED MAT INSTALLED.
- ALL TREES LOCATED IN SOD AREAS SHALL HAVE A MULCH RING AROUND THEM WITH EDGING AS REQUIRED.
- ALL PLANTINGS SHALL BE THOROUGHLY WATERED BY THE LANDSCAPE CONTRACTOR AT THE TIME OF THE PLANTINGS.
- 10. ALL DISTURBED GRADES GREATER THAN 8:1 SHALL BE STABILIZED BY SODDING. SODDING PINS ARE TO BE USED ON ALL 3:1 TO 4:1 GRADES.
- 11. PRIOR TO FINAL ACCEPTANCE OF STORE BY DOLLAR GENERAL, THE SITE SHALL BE CLEAN OF ALL DEBRIS/TRASH AND MEET ALL REQUIREMENTS OUTLINED IN THIS PLAN.

- SODDED AND LANDSCAPE AREAS. SUBMIT PLAN TO ARCHITECT/ENGINEER FOR APPROVAL PRIOR TO INSTALLATION. IRRIGATION SYSTEM MUST HAVE A SEPARATE METER, AN APPROVED BACKFLOW DEVICE INSTALLED, AND RAIN SENSOR TO STOP IRRIGATION DURING RAIN EVENTS.
- LOCATE HEADS A MINIMUM 2' FROM EDGE OF PAVEMENT/CURB.
- INSTALL 3" DIA. PVC PIPE SLEEVES WHERE IRRIGATION LINES CROSS OR ARE UNDER PAVEMENT.

#### LOCATE RAINBIRD CONTROL PANEL IN RECEIVING AREA NEXT TO ELECTRICAL PANEL. LANDSCAPING CHART KEY QTY BOTANICAL NAME COMMON NAME SIZE SPACING RM ~14 ACER RUBRUM RED MAPLE 10' HIGH AS SHOWN HOL ~96 LLEX CRENATA 'COMPACTA' COMPACT JAPANESE HOLLY 4'-5' HIGH 4'-6'

 Topsoil and seed all disturbed lawn areas. 2. Provide approved double ground hardwood mulch (dark brown) for planting mulch in parking area islands.

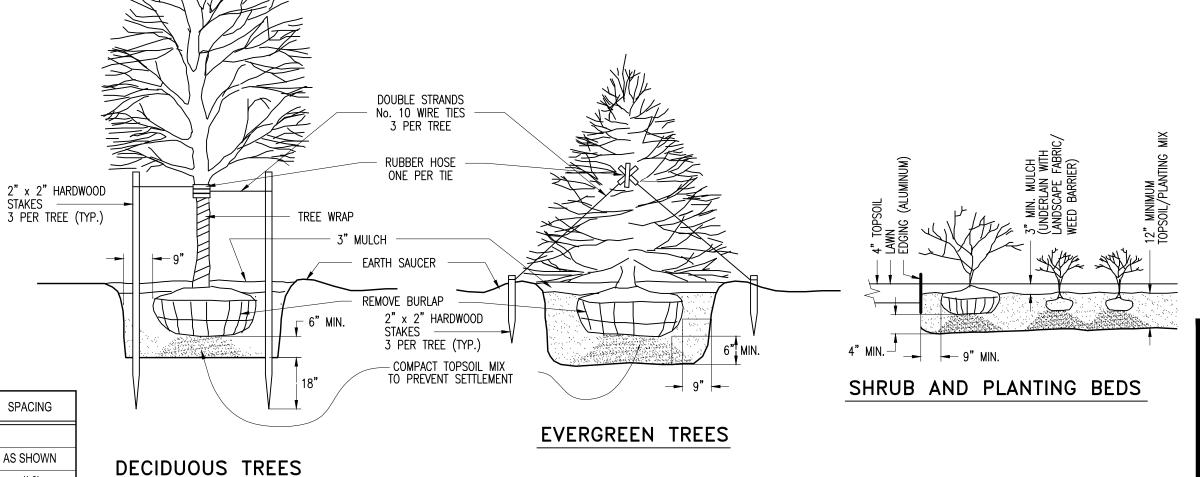

TREE AND SHRUB PLANTING DETAIL



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- LEGEND

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> dway Group Broa S




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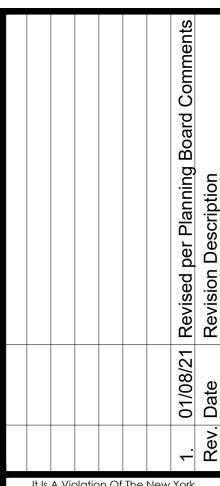
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**LANDSCAPING** PLAN





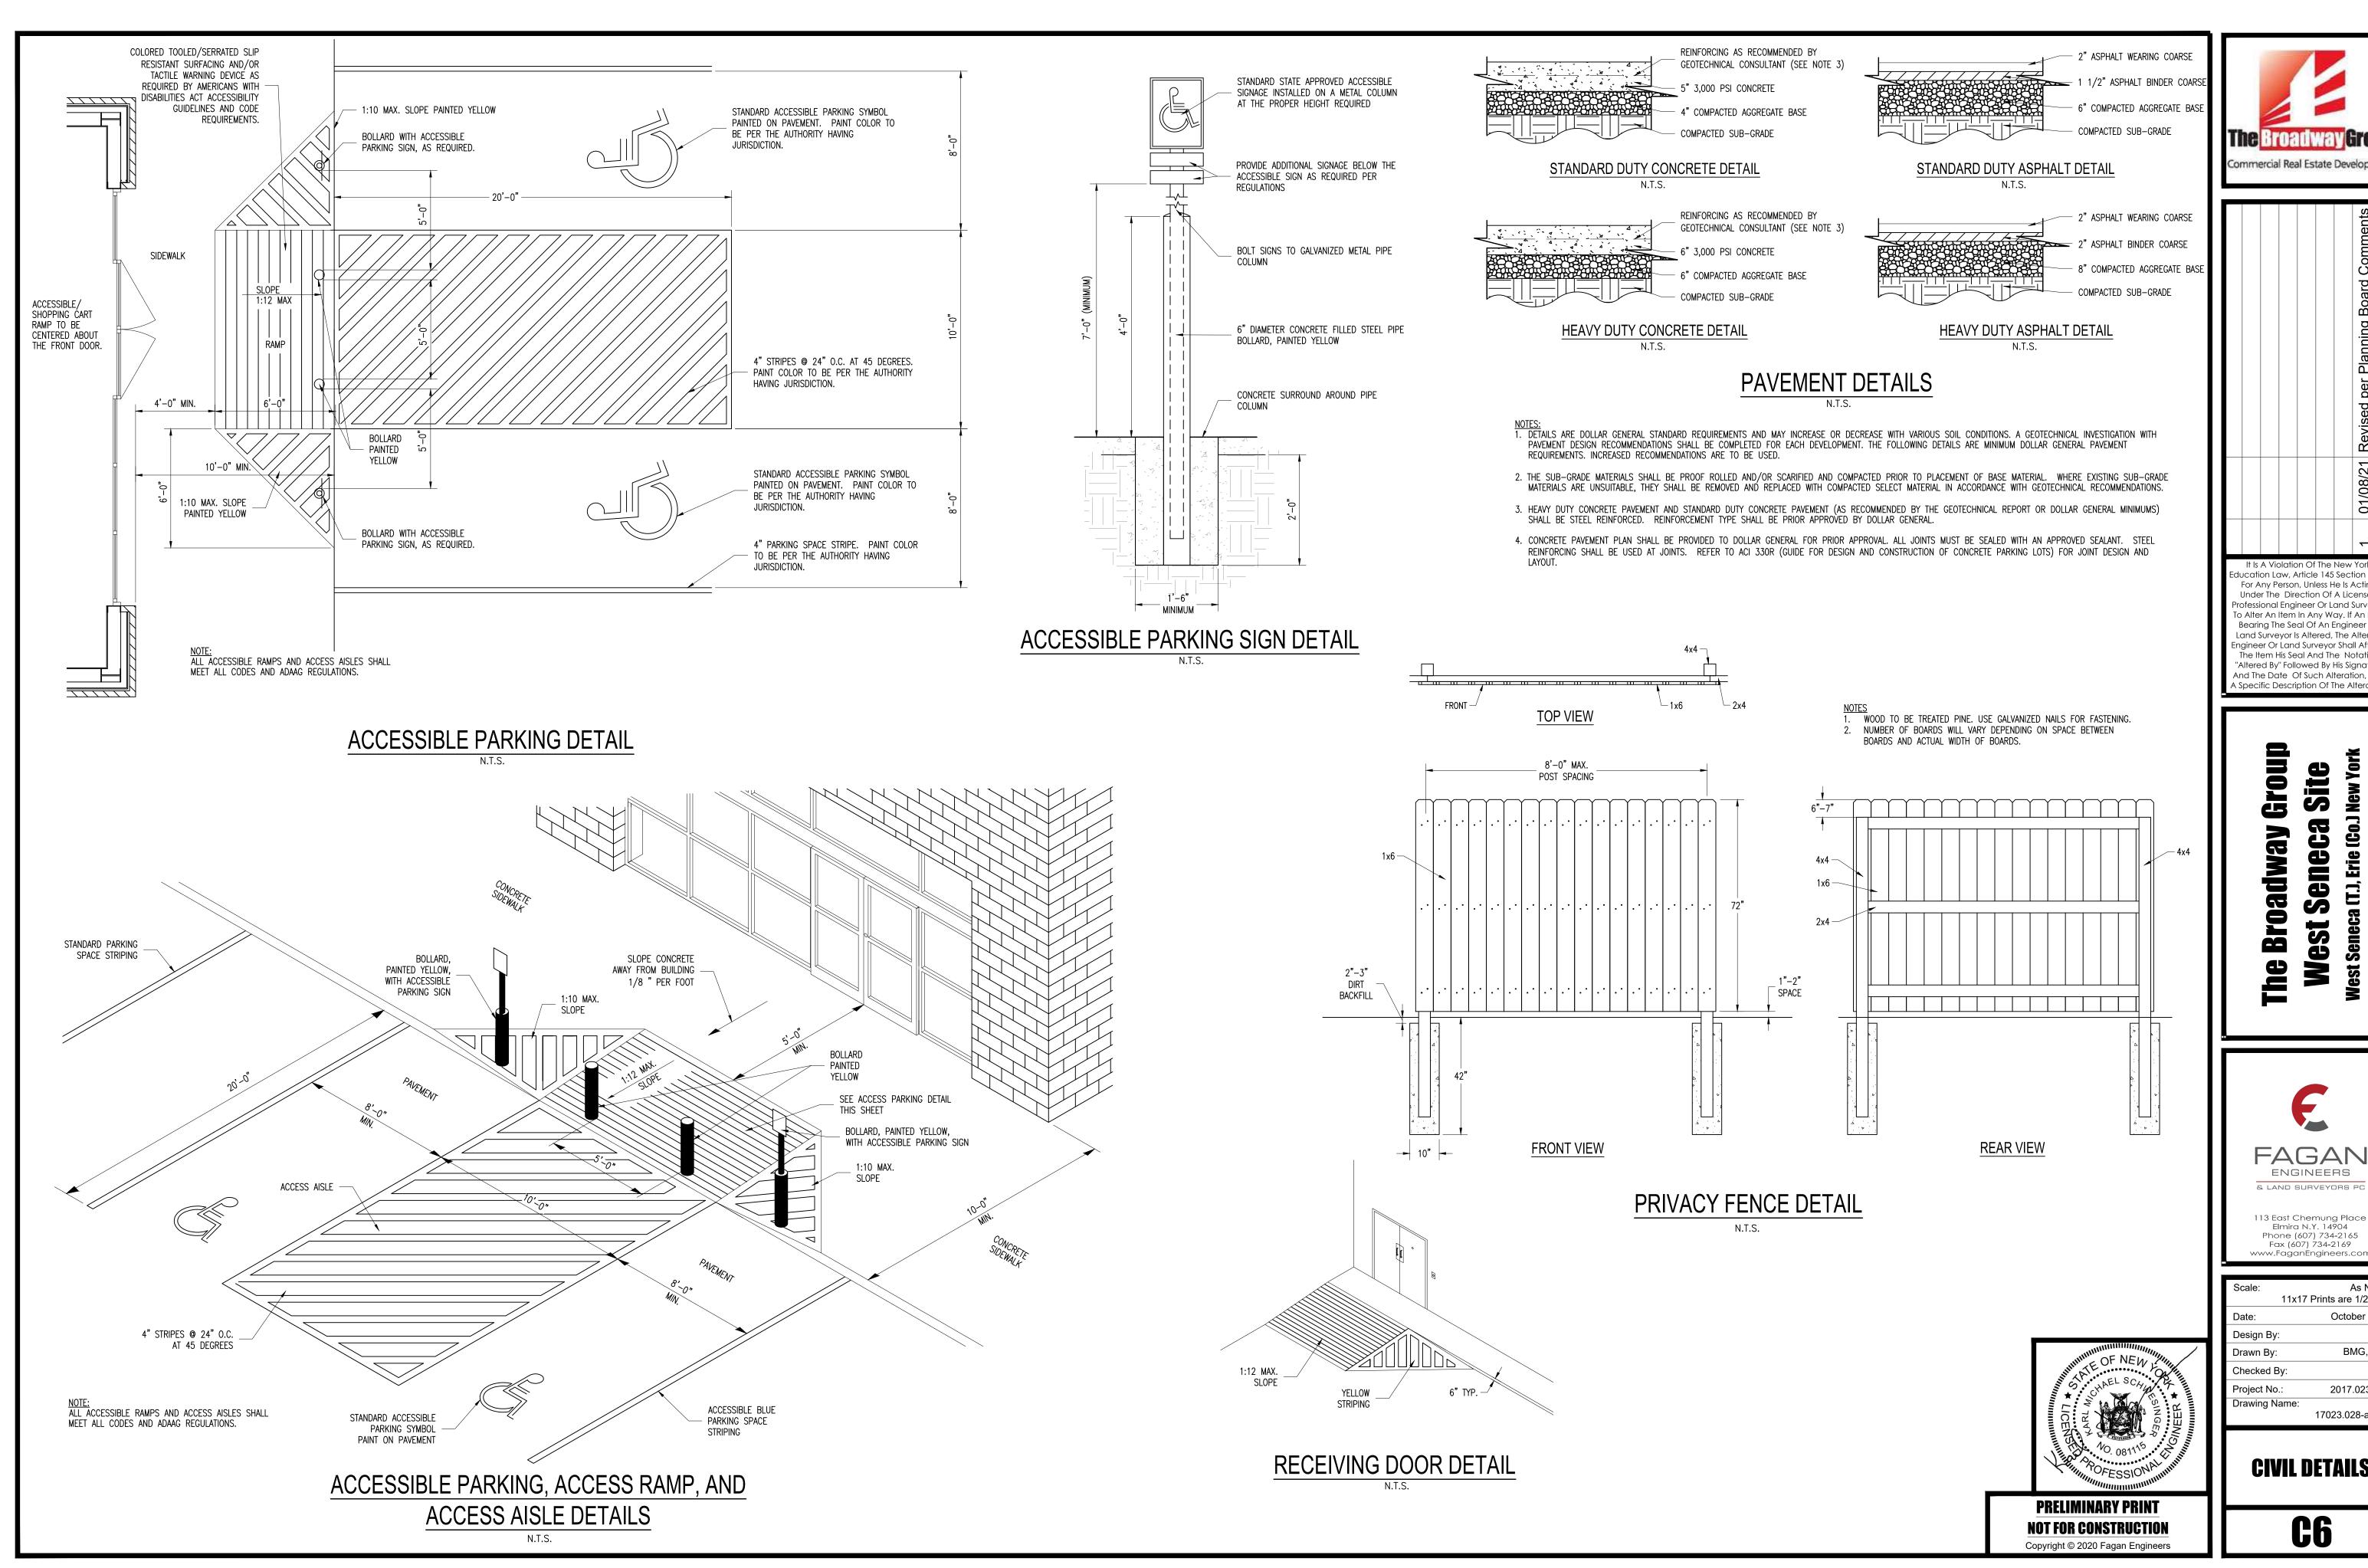


ducation Law, Article 145 Section 7209 For Any Person, Unless He Is Acting Under The Direction Of A Licensed Professional Engineer Or Land Surveyor To Alter An Item In Any Way. If An Item Bearing The Seal Of An Engineer Or Land Surveyor Is Altered, The Altering Engineer Or Land Surveyor Shall Affix To The Item His Seal And The Notation "Altered By" Followed By His Signature And The Date Of Such Alteration, And A Specific Description Of The Alteration




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Date:	October 2020
Design By:	BMG
Drawn By:	BMG, CEL
Checked By:	KMS
Project No.:	2017.023.028
Drawing Name:	17023.028-a.dwg
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CIVIL DETAILS

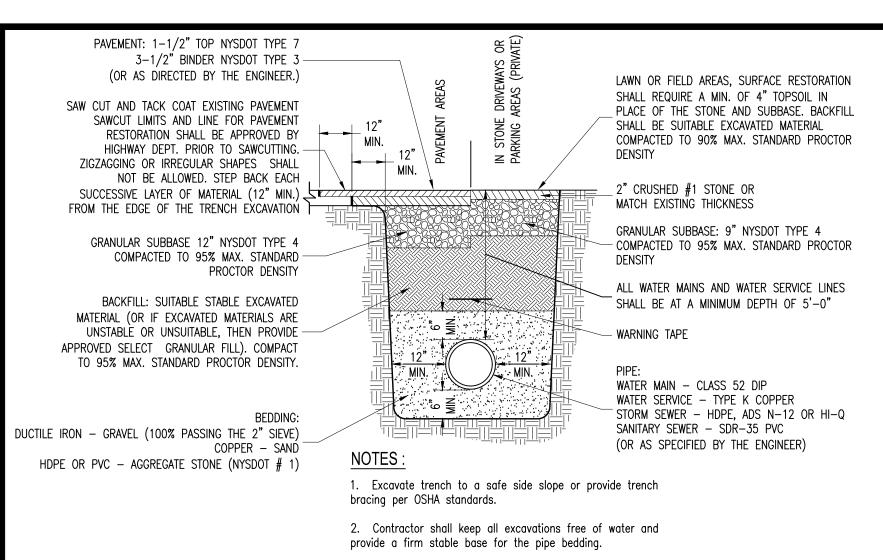


# TYPICAL PIPE TRENCH DETAIL

N.T.S.

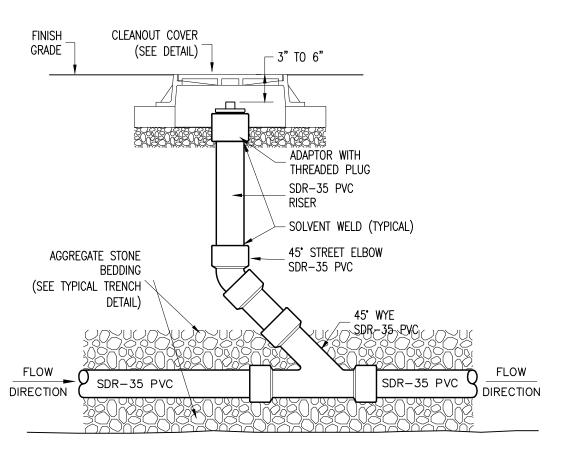


IN-LINE CLEANOUT DETAIL

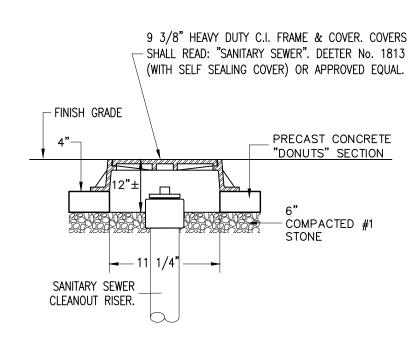

CLEANOUT COVER DETAIL


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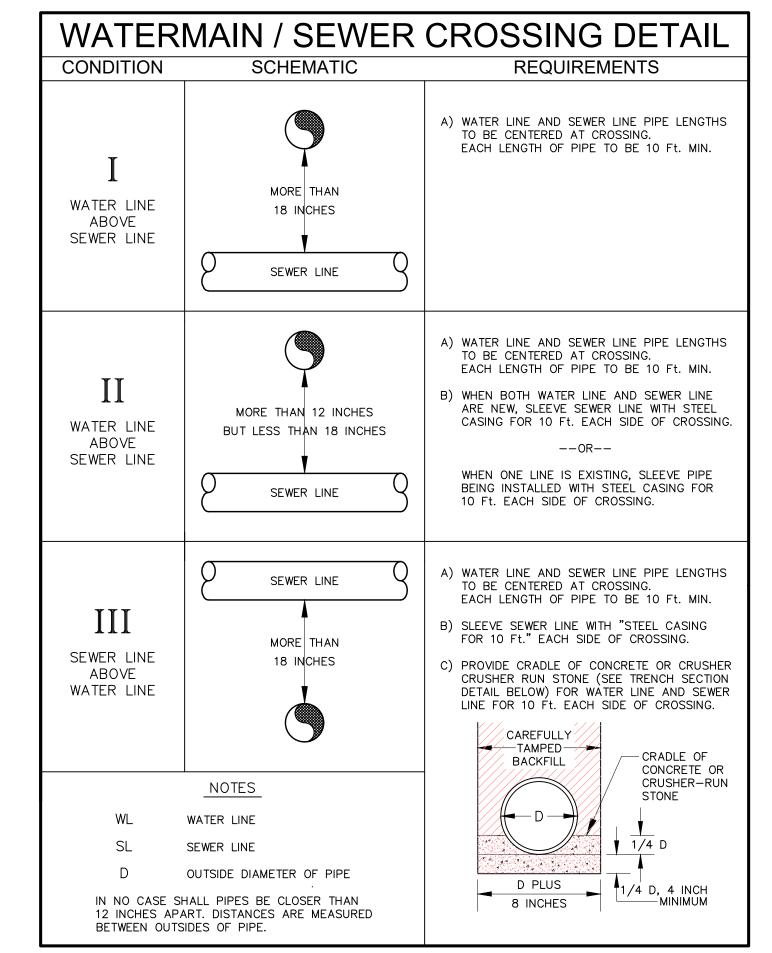


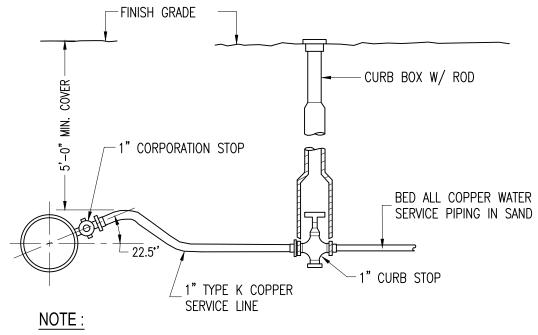
Contractor shall provide corporation stop, curb stop and box with style/manufacturer as directed by the Water Department.

# WATER SERVICE DETAIL

N.T.S



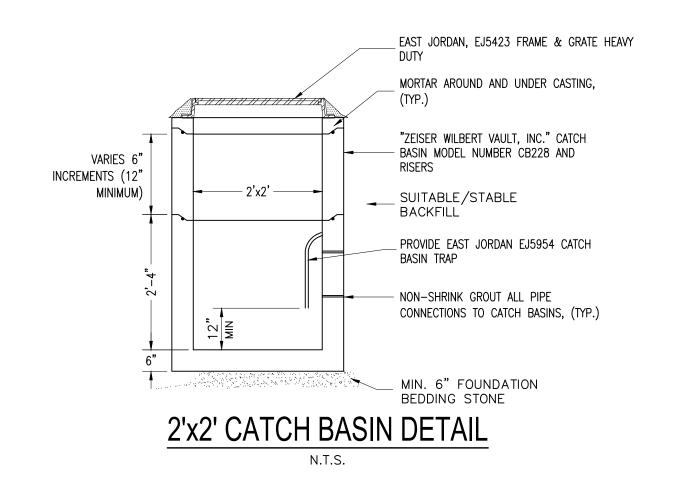

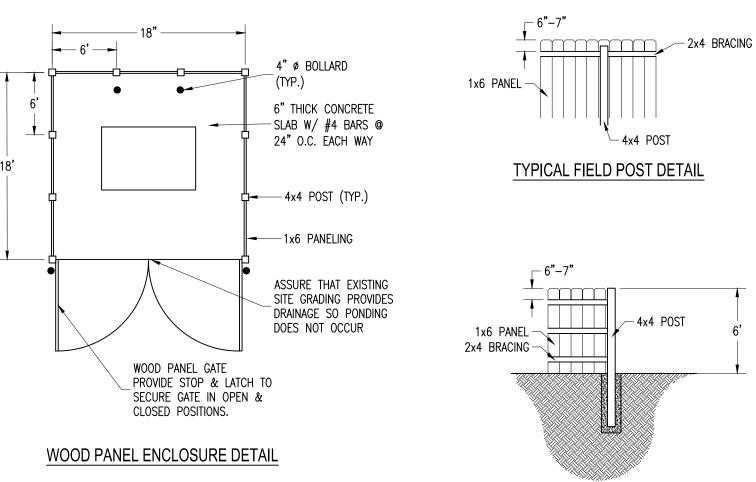


NOTES

1. WOOD TO BE TREATED PINE. USE GALVANIZED NAILS FOR FASTENING.
2. NUMBER OF BOARDS WILL VARY DEPENDING ON SPACE BETWEEN BOARDS AND ACTUAL WIDTH OF BOARDS.
3. COLOR TO BE DETERMINED BY OWNER.

# WOOD PANEL DUMPSTER ENCLOSURE DETAIL

N.T

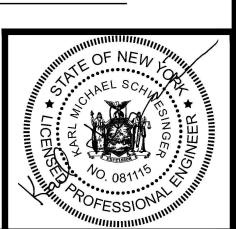

TYPICAL CORNER POST DETAIL

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Bearing The Seal Of An Engineer Or

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The Item His Seal And The Notation

"Altered By" Followed By His Signature

And The Date Of Such Alteration, And

A Specific Description Of The Alteration

Group

Way

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Date: October 2020

Design By: BMG


Drawn By: BMG, CEL

Checked By: KMS

Project No.: 2017.023.028

Drawing Name: 17023.028-a.dwg

CIVIL DETAILS

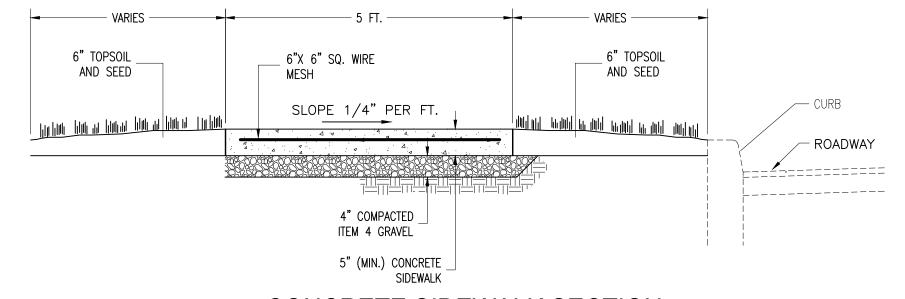


# CONCRETE SIDEWALK SECTION

N.T.S.

1. The Local Code Enforcement Officer shall be notified prior 4. Provide 5/8" wide asphalt impregnated fiber board to repair of existing sidewalk or construction of new sidewalk within a public right-of-way.


CONCRETE SIDEWALK NOTES

- 2. Appropriate barricades shall be required for the entire construction period.
- 3. Provide 3500 psi (28 day compressive strength) concrete, utilizing Type II Portland cement and 6" x 6" sq. wire mesh reinforcement.
- expansion joints in sidewalk construction as follows:
- Adjacent to all concrete curbing and gutters.
- Adjacent to all building foundations or walls. - Abutting yard walks, driveways or existing sidewalks. - Approximately every 20 ft. in long sidewalk runs.
- 5. Sidewalk shall have a light broom finish across the walk. Edges and joints shall be rounded by an edging tool.
- 6. Side walk shall be coated with a curing compound after finishes are complete.

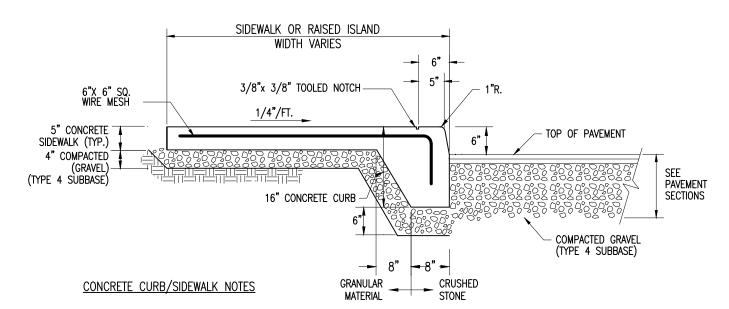

- 1. PROVIDE 3500 PSI (28 DAY COMPRESSIVE STRENGTH) CONCRETE, UTILIZING TYPE II PORTLAND CEMENT.
- 2. PROVIDE 5/8" WIDE ASPHALT IMPREGNATED FIBER BOARD CONTROL JOINTS IN SIDEWALK CONSTRUCTION AS FOLLOWS:
  - ADJACENT TO ALL CONCRETE CURBING - ADJACENT TO ALL BUILDING FOUNDATIONS/ WALLS
- APPROXIMATELY EVERY 24 FT. IN LONG SIDEWALK RUNS. 3. SIDEWALK SHALL HAVE A LIGHT BROOM FINISH ACROSS THE WALK.
- 4. EDGES AND JOINTS SHALL BE ROUNDED BY AND EDGING TOOL ACCEPTABLE TO OWNER.
- 5. CONTRACTION JOINTS SHALL BE TOOLED TO FORM SQUARE BLOCKS.
- 6. RAMP SLOPE SHALL BE NO GREATER THAN 1:12.
- 7. CONCRETE CURB / SIDEWALK SHALL BE COATED WITH A CURING COMPOUND AFTER FINISHES ARE COMPLETE.

## INTEGRAL CONCRETE SIDEWALK / CURB

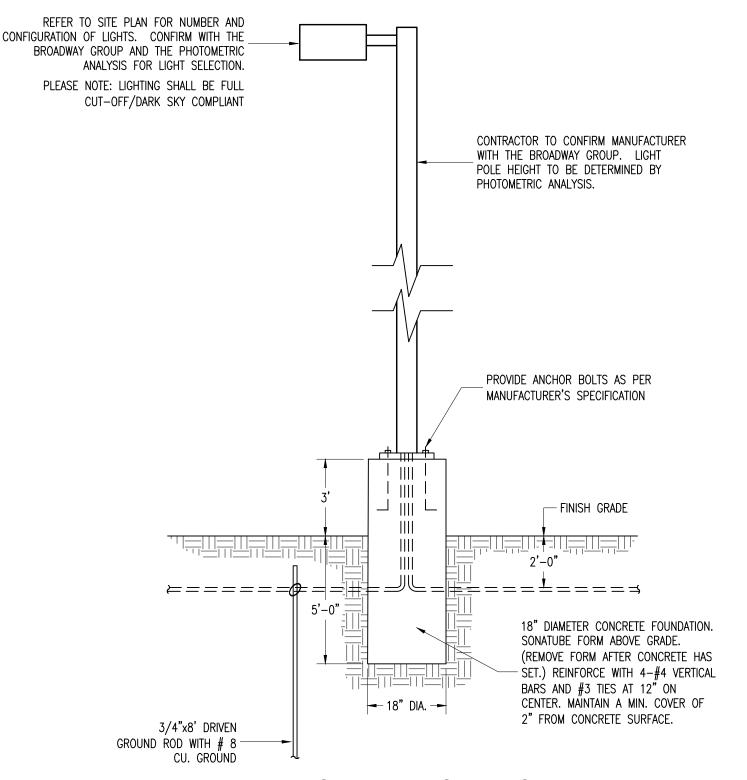

PARKING AREA LIGHTING DETAIL N.T.S.







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**CIVIL DETAILS** 




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#### E&S PLAN NOTES:

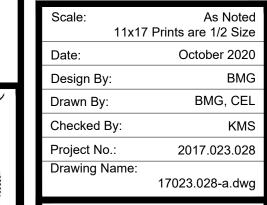- 1. ONLY LIMITED DISTURBANCE WILL BE PERMITTED TO PROVIDE ACCESS TO THE SITE FOR GRADING AND ACQUIRING BORROW TO CONSTRUCT THOSE BMPS.
- 2. EROSION AND SEDIMENT BMPS MUST BE CONSTRUCTED, STABILIZED, AND FUNCTIONAL BEFORE SITE DISTURBANCE BEGINS WITHIN THE TRIBUTARY AREAS OF THOSE BMPS.
- 3. AFTER FINAL SITE STABILIZATION HAS BEEN ACHIEVED, TEMPORARY EROSION AND SEDIMENT BMPS MUST BE REMOVED. AREAS DISTURBED DURING REMOVAL OF THE BMPS MUST BE STABILIZED IMMEDIATELY.
- 4. STOCKPILE HEIGHTS MUST NOT EXCEED 35 FEET. STOCKPILE SLOPES MUST BE 2:1 OR FLATTER.
- 5. UNTIL THE SITE IS STABILIZED, ALL EROSION AND SEDIMENT BMPS MUST BE MAINTAINED PROPERLY. MAINTENANCE MUST INCLUDE INSPECTIONS OF ALL EROSION AND SEDIMENT BMPS AFTER EACH RUNOFF EVENT AND ON A WEEKLY BASIS. ALL PREVENTATIVE AND REMEDIAL MAINTENANCE WORK, INCLUDING CLEAN OUT, REPAIR, REPLACEMENT, REGRADING, RESEEDING, REMULCHING AND RENETTING MUST BE PERFORMED IMMEDIATELY. IF EROSION AND SEDIMENT CONTROL BMPS FAIL TO PERFORM AS EXPECTED, REPLACEMENT BMPS, OR MODIFICATIONS OF THOSE INSTALLED WILL BE REQUIRED.
- 6. SITE CONTRACTOR TO BECOME CO-PERMITTEE PRIOR TO EARTHWORK ACTIVITIES COMMENCING. SITE CONTRACTOR IS RESPONSIBLE FOR ALL CONDITIONS OF THE E&S PERMITS.

#### CONSTRUCTION SEQUENCE

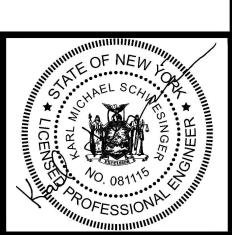
- 1. ALL PAGE NUMBERS (P. 5\*.\*\*) REFER TO THE NEW YORK STATE GUIDELINES FOR URBAN EROSION AND SEDIMENT CONTROL.
- 2. INSTALL STABILIZED CONSTRUCTION ENTRANCE (P. 5A.75). WIDTH: TWELVE (12) FT. MINIMUM, BUT NOT LESS THAN THE FULL WIDTH AT POINTS WHERE INGRESS OR EGRESS OCCURS. IF ONLY ONE ENTRANCE IS USED THE MINIMUM WIDTH SHALL BE TWENTY-FOUR (24) FEET.
- 3. STANDARD SILT FENCE (P. 5A.19) SHALL THEN BE PLACED AROUND ALL DISTURBED AREAS.
- 4. CLEAR AND GRUB THE SITE. STRIP TOPSOIL AND STOCKPILE ON-SITE WITH PERIMETER SILT FENCE AND VEGETATIVE COVER. PERFORM GRADING IN ACCORDANCE WITH MANUAL (P. 5B.49)
- 5. CONSTRUCT BUILDING FOUNDATION AND ENCLOSE BUILDING
- 6. CONSTRUCT PROPOSED STORM SEWER.
- 7. INLET PROTECTION (P. 5A.27) SHALL BE PLACED AROUND ALL STORM DRAIN INLETS. UTILIZE TYPE II IN AREAS OF EXCAVATION AND TYPE III IN PAVEMENT AREAS. CONVERT ALL FABRIC DROP INLET PROTECTION TO TYPE III IN-PAVEMENT PROTECTION UPON PAVING WITHIN PROJECT AREA
- 8. FINALIZE CONSTRUCTION OF MAIN PROJECT ELEMENTS INCLUDING INFRASTRUCTURE AND NEW PAVEMENT.
- 9. PERFORM SOIL RESTORATION TO DISTURBED AREAS OF THE SITE THAT WILL NOT BE PAVED. SOIL RESTORATION INCLUDES DEEP RIPPING THE SUBSOIL TO A MINIMUM DEPTH OF 12-INCHES, MIXING 3-INCHES OF COMPOST INTO THE SUBSOIL AND SPREADING 6-INCH OF TOPSOIL TO THE SITE.
- 10. SEED, MULCH AND SOD THE PROJECT SITE.
- 11. REMOVE ALL TEMPORARY EROSION CONTROL METHODS WHEN CONTRIBUTING DRAINAGE AREAS HAVE REACHED FINAL STABILIZATION.



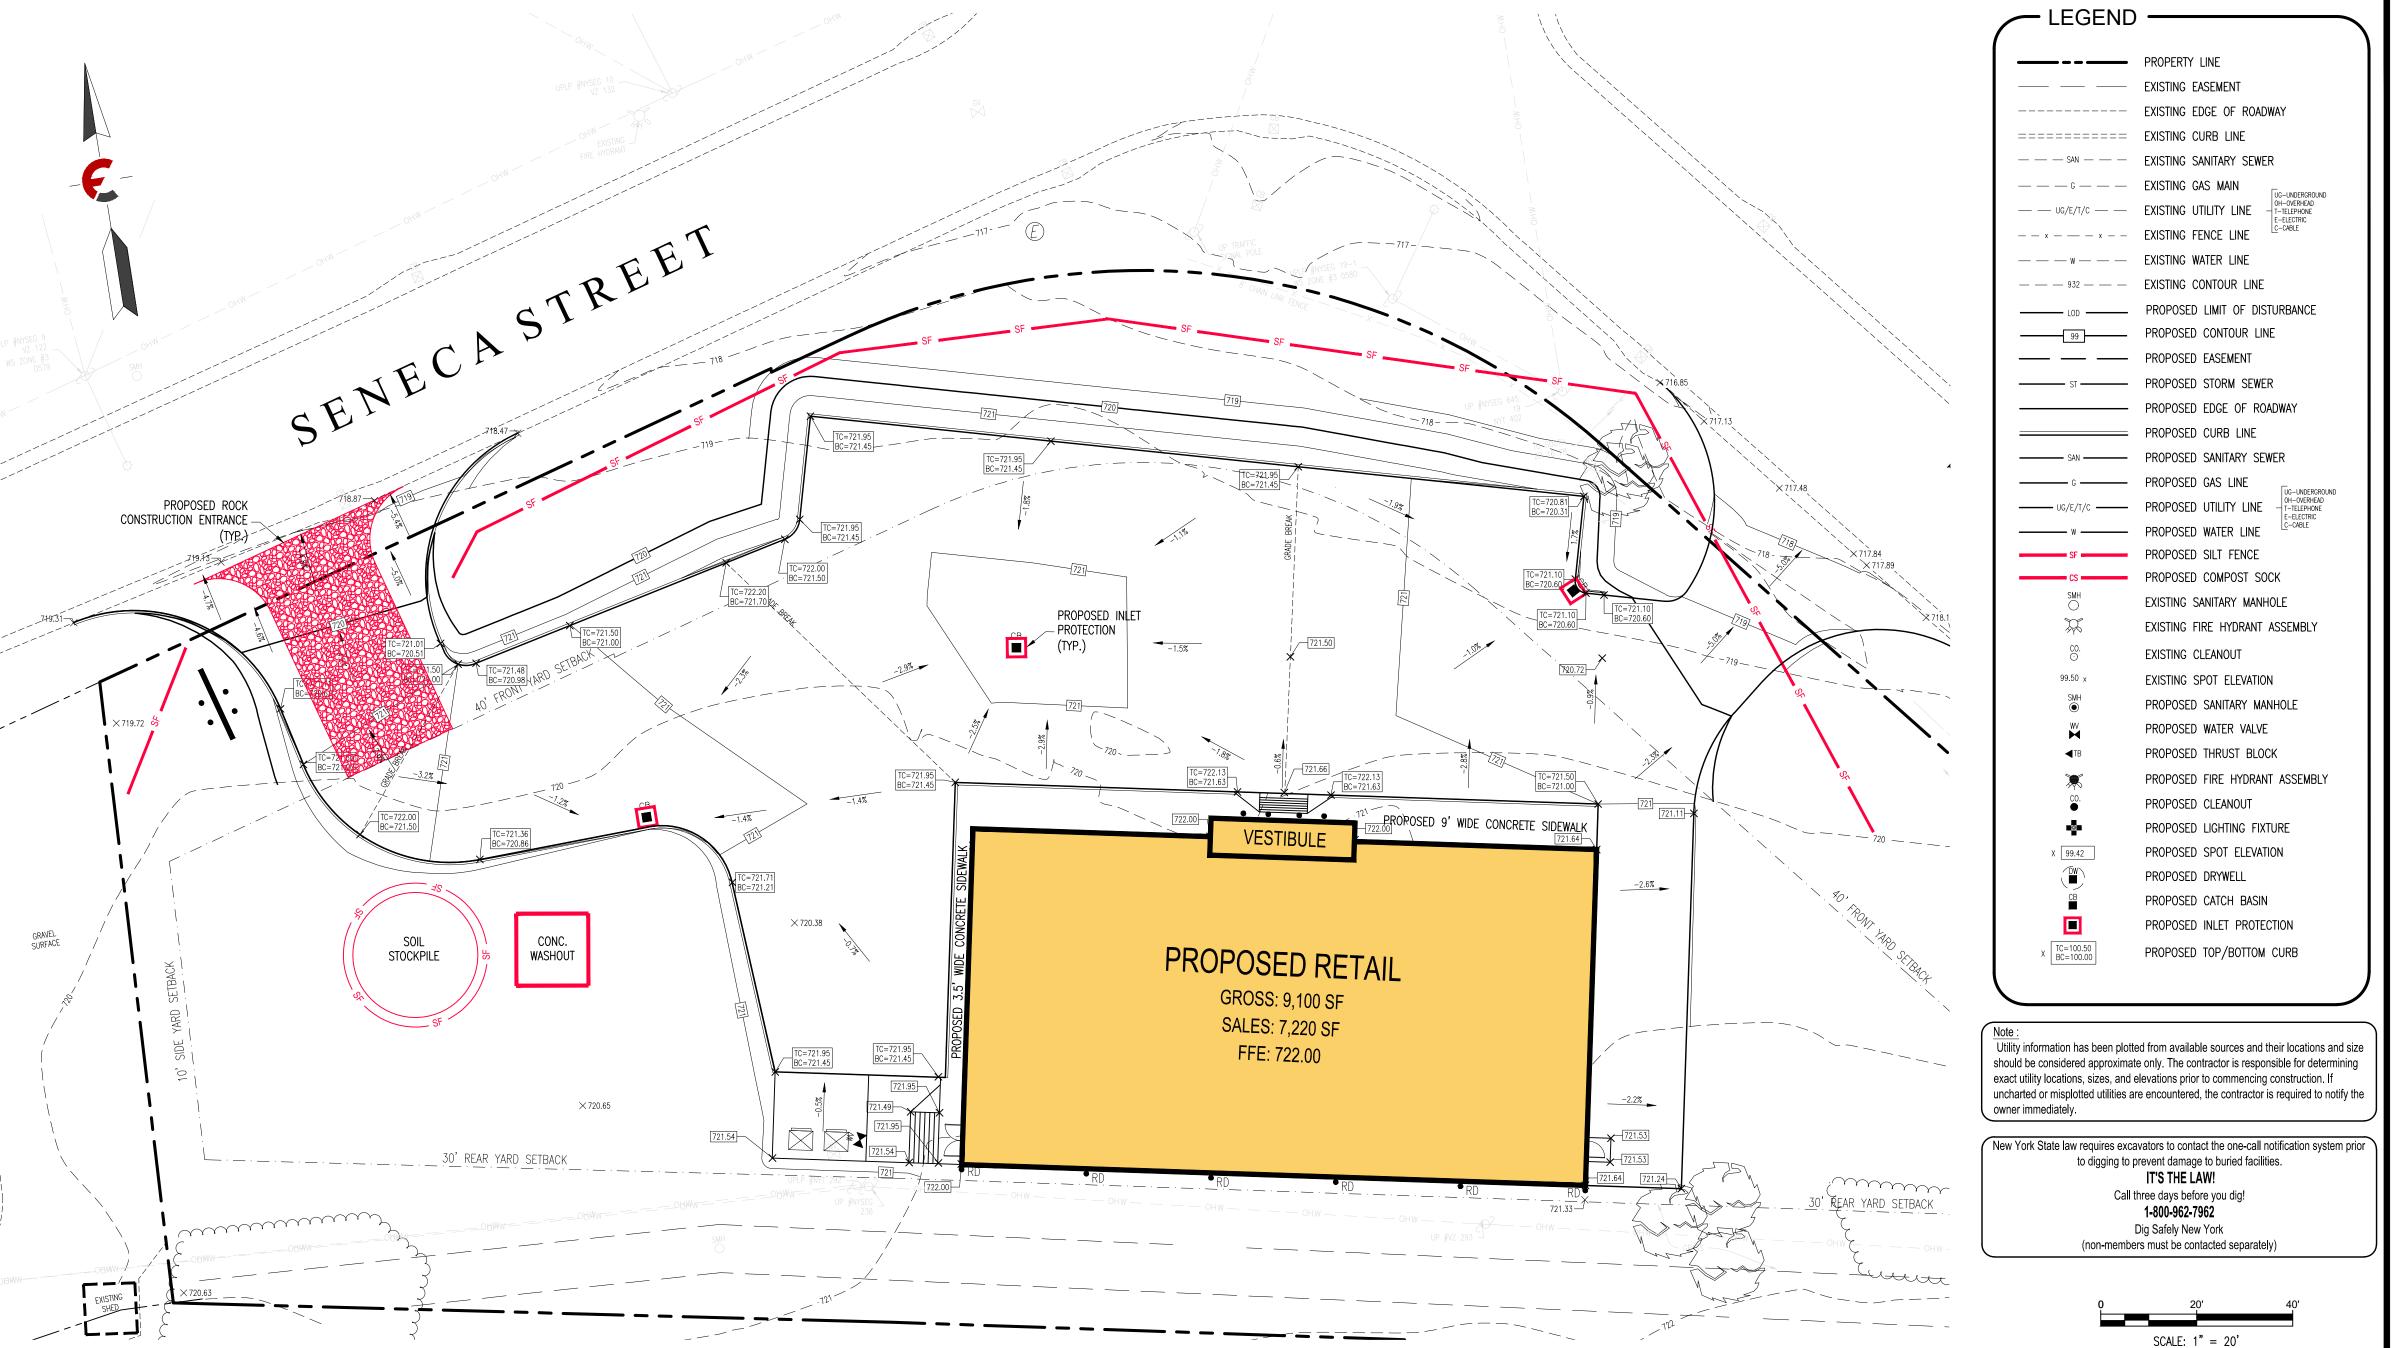

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And The Date Of Such Alteration, And
A Specific Description Of The Alteration.

The Broadway Group West Seneca (T.), Erie (Go.) New York

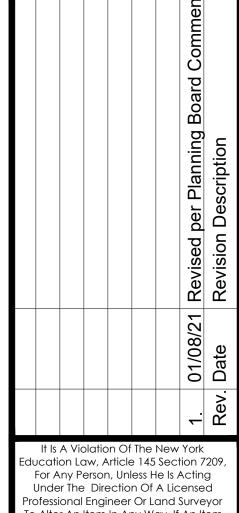

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 1" = 20'

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 Date:
 October 2020

 Design By:
 BMG

 Drawn By:
 BMG, CEL

 Checked By:
 KMS

 Project No.:
 2017.023.028

 Drawing Name:
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E&S PLAN

# STANDARD AND SPECIFICATIONS FOR LAWN AREA IMPROVEMENT

Establishing Grasses (Turf grasses)

- 1. Time of planting:
- Fall planting is preferred. Seed after August 15. In the spring plant until May 15.
- If seeding is done between May 15 and August 15, irrigation may be necessary to insure a successful seeding.
- A. Install needed water and erosion control measures and bring area to be seeded to desired grades. A minimum of 4 in topsoil is required.
- B. Prepare seedbed by loosening soil to a depth of 1 to 6 inches. C. Remove all stones over 1 inch in diameter, sticks and foreign matter from the surface.
- D. Lime to pH if 6.0 7.0. E. Fertilize as per soil test or apply 800 to 900 pounds of 5-10-10 or equivalent per acre (20 lbs./1,000 sf.).
- F. Incorporate lime and fertilizer in top 2 4 inches of topsoil. G. Smooth and firm the seedbed.
- 3. Planting: • Use a cultipacker type seeder if possible.
- If seed is to be drilled, cultipack or roll before and after seeding. Drill the seed to a depth of  $\frac{1}{8}$  to  $\frac{1}{4}$  inch. If seed is to be broadcast, cultipack or roll after seeding on loose soil.
- If hydroseeded, lime and fertilizer may be applied through the seeder

#### A. Site preparation:

Seed mixtures:

- a. Prior to mulching, install the necessary temporary or permanent erosion control (structural) practices and drainage systems within or adjacent to area to be mulched.
- b. Slope, grade and smooth the site if conventional equipment is to be used in applying and anchoring the mulch.
- c. Remove all undesirable stone and other debris depending on anticipated land use. d. Compacted or crusted soil surface should be loosened to at least 2 inches by disking or other suitable methods.
- B. Mulching Materials: • The best combination is straw (small grain) mulch applied at 2 ton/acre (90 lbs./1,000 sf.) and anchored with wood fiber


#### mulch (hydromulch) at 500 - 700 lbs./acre (11 - 17 lbs./1,000 sf.). The wood fiber mulch must be applied through a hydroseeder immediately after mulching.

SITE/USE	SPECIES % BY WEIGHT	Lbs./1,000 sf.	Lbs./Acre
Sunny Sites (well moderately well and somewhat poorly drained soils)	65% Kentucky Bluegrass Blend 20% Perennial Ryegrass 15% Fine Fescue	2.0 - 2.6 0.6 - 0.8 0.4 - 0.6 3.0 - 4.0	85 - 114 26 - 35 19 - 26 130 - 175
Sunny Droughty Sites — General recreation areas and lawns, low maintenance (somewhat excessively to excessively drained soils)	65% Fine Fescue 15% Perennial Ryegrass 20% Kentucky Bluegrass Blend	2.6 - 3.3 0.6 - 0.7 0.8 - 1.0 4.0 - 5.0	114 - 143 26 - 33 35 - 44 174 - 220

- Fertilize 3 to 4 weeks after germination by applying 1 lb. nitrogen/1,000 sf. using a complete fertilizer with a 2-1-1 or
- 4-1-3 ratio or as recommended by soil test results.
- Restrict use. New seeding's should be protected from use for 1 full year to allow development of a dense sod with good root structure.

#### 7. Maintaining Grasses

- Maintain a pH of 6.0 to 7.0.
- Fertilize in late May to early June as follows with 10-10-10 analysis fertilizer at the rate of 10 lbs./1,000 sf. and repeat in late August if sod density is not adequate. Top dress weak sod annually in the spring but at least once every 2 to 3 years.
- Aerate compacted or heavily used areas, like athletic fields, annually as soon as soil moisture conditions permit. Aerate area 6 to 8 times using a spoon or hollow tine type aeration. Do not use solid spike equipment.
- Reseed bare and thin areas annually with original species.

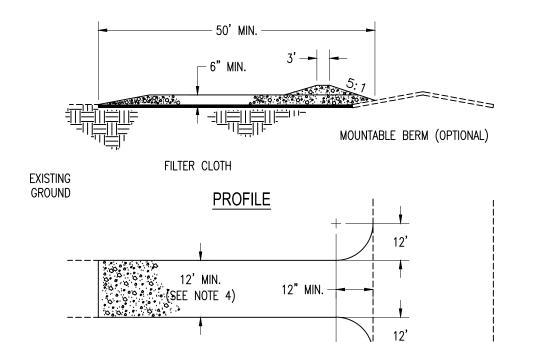

# STABILIZED CONSTRUCTION ENTRANCE


EXISTING


PAVEMENT


### CONSTRUCTION SPECIFICATIONS


PLAN VIEW

- 1. Stone size: Use 2" stone, or reclaimed or recycled concrete equivalent.
- 2. Length: As required, but no less than 50 feet.
- 3. Thickness: Not less than (6) inches.
- 4. Width: Twelve (12) ft. Minimum, but not less than the full width at points where ingress or egress occurs. If only one entrance is used the minimum width shall be twenty-four (24) feet.
- 5. Filter cloth: Will be placed over the entire area prior to placing of stone.
- 6. Surface water: All surface water flowing or diverted toward construction entrances shall be piped across the entrance. If piping is impractical, a mountable berm with 5:1 slopes is permitted.
- 7. Maintenance: The entrance shall be maintained in a condition which will prevent tracking or flowing of sediment onto public rights-of-way. This may require periodic top dressing with additional stone as conditions demand and repair and/or cleanout of any measures used to trap sediment. All sediment spilled, dropped, washed or tracked onto public rights—of—way must be removed immediately by Contractor.
- 8. Washing: Wheels shall be cleaned to remove sediment prior to entrance onto a public rights—of—way. When washing is required it shall be done on an area stabilized with stone and which drains into an approved sediment trapping device.
- 9. Periodic inspection and needed maintenance shall be provided after each rain.

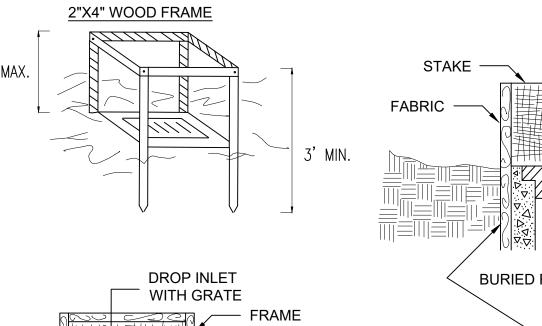

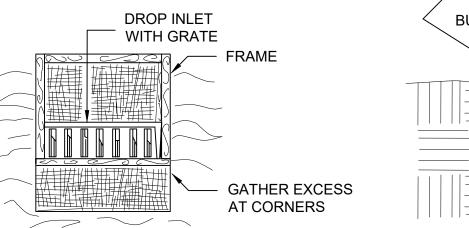

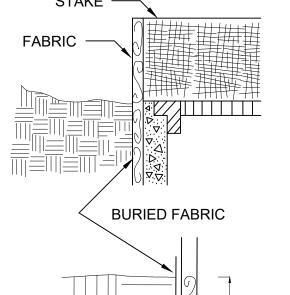


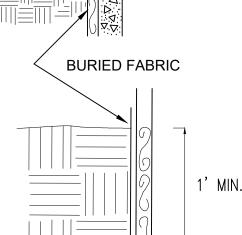



#### SPECIFICATIONS FOR SILT FENCE PROTECTION

- 1. Filter fabric shall have an EOS of 40-85.
- 2. Cut fabric from a continuous roll to eliminate joints. If joints are needed they shall be overlapped to the next stake.
- 3. Stake materials shall be 2"x4" wood or equivalent metal with a minimum length of 3 feet.
- 4. Space stakes evenly around inlet 3 feet apart and drive a minimum 18 inches deep. Spans greater than 3 feet may be bridged with the use of wire mesh behind fabric for support.
- 5. Fabric shall be embedded 1 foot minimum below around and backfilled. It shall be securely fastened to the stakes and frame.
- 6. A 2"x4" wood frame shall be completed around the crest of the fabric for over flow stability.
- 7. Maximum drainage area 1 acre.
- 8. Inspection shall be frequent and repair or replacement shall be made promptly

# FILTER FABRIC STORM DRAIN **PROTECTION**

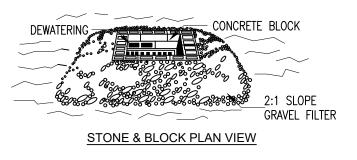


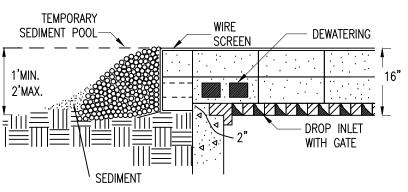

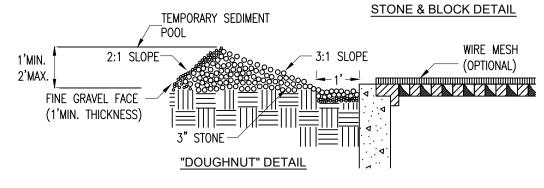

## IN-PAVEMENT INLET PROTECTION

1. LAY ONE BLOCK ON EACH SIDE OF THE STRUCTURE ON ITS SIDE FOR DEWATERING. FOUNDATION SHALL BE 2 INCHES MINIMUM BELOW REST OF INLET AND BLOCKS SHALL BE PLACED AGAINST INLET FOR SUPPORT.

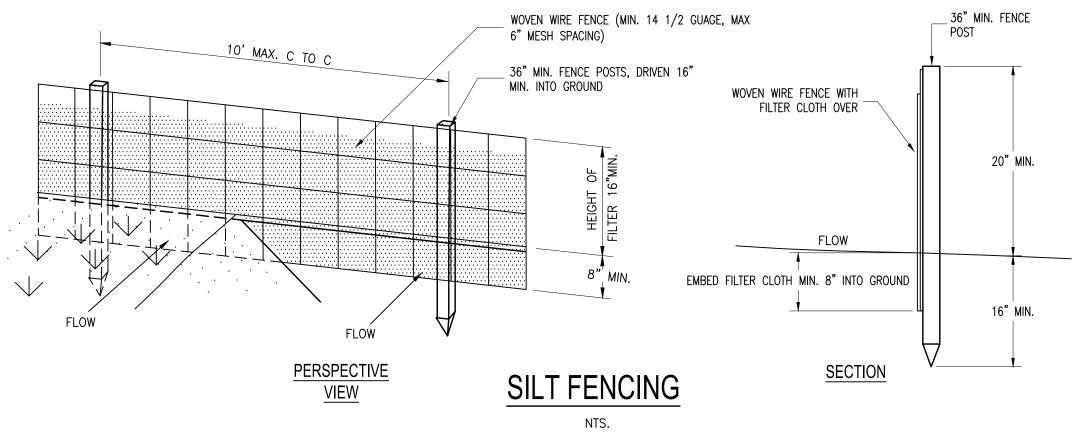


#### CONSTRUCTION SPECIFICATIONS FOR FABRICATED SILT FENCE


- 1. Woven wire fence to be fastened securely to fence posts with
- wire ties or staples. 2. Filter cloth to be fastened securely to woven wire fence with ties
- 3. When two sections of filter cloth adjoin each other they shall be over-lapped by 6" and folded.

spaced every 24" at top and mid section.

- 4. Maintenance shall be performed as needed and material removed when "bulges" develop in the silt fence.
- Posts: Steel either "t" or "u" type or 2" hardwood.
- Fence: Woven wire, 14 1/2 ga. 6" max. mesh opening filter.
- Cloth: Filter x, mirafi 100x, stabi-linka t140n or approved equal. prefabricated unit: geofab, envirofence, or approved equal.

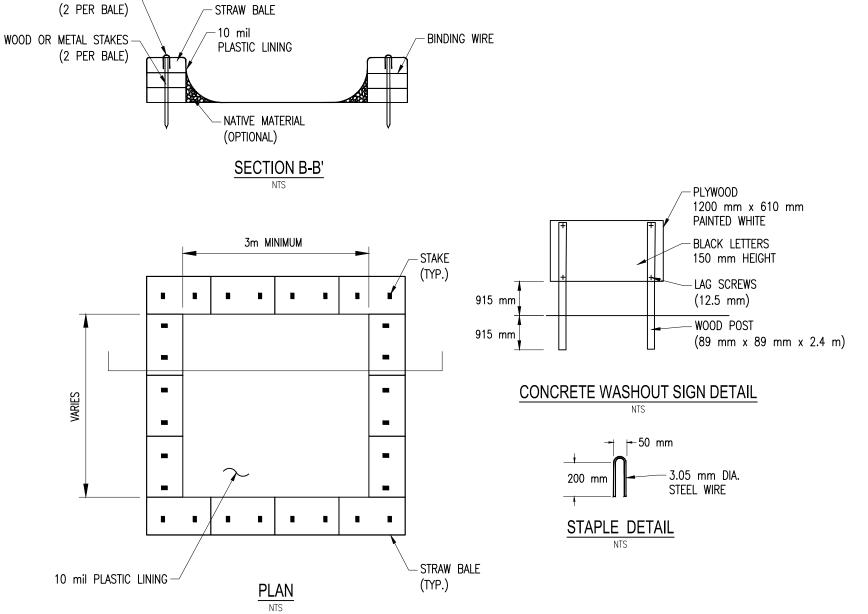




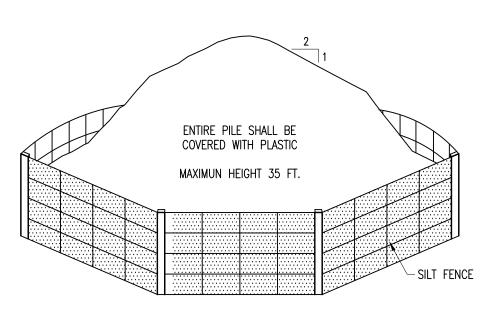


#### SOIL STOCKPILING NOTES:

1. AREA FOR STOCKPILING OPERATIONS SHALL BE DRY AND STABLE. 2. MAXIMUM SLOPE OF STOCKPILE SIDESLOPES SHALL BE 2:1. 3. UPON COMPLETION OF SOIL STOCKPILING, EACH PILE SHALL BE SURROUNDED WITH SILT FENCING AND THEN STABILIZED WITH SEED OR SECURED IMPERVIOUS COVER. 4. SEE SILT FENCE INSTALLATION DETAIL. 5. PLASTIC SHEETING SHALL BE PLACED BELOW ALL STOCKPILE AREAS.

> SOIL STOCKPILE DETAIL NOT TO SCALE

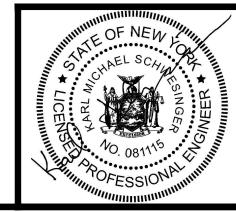

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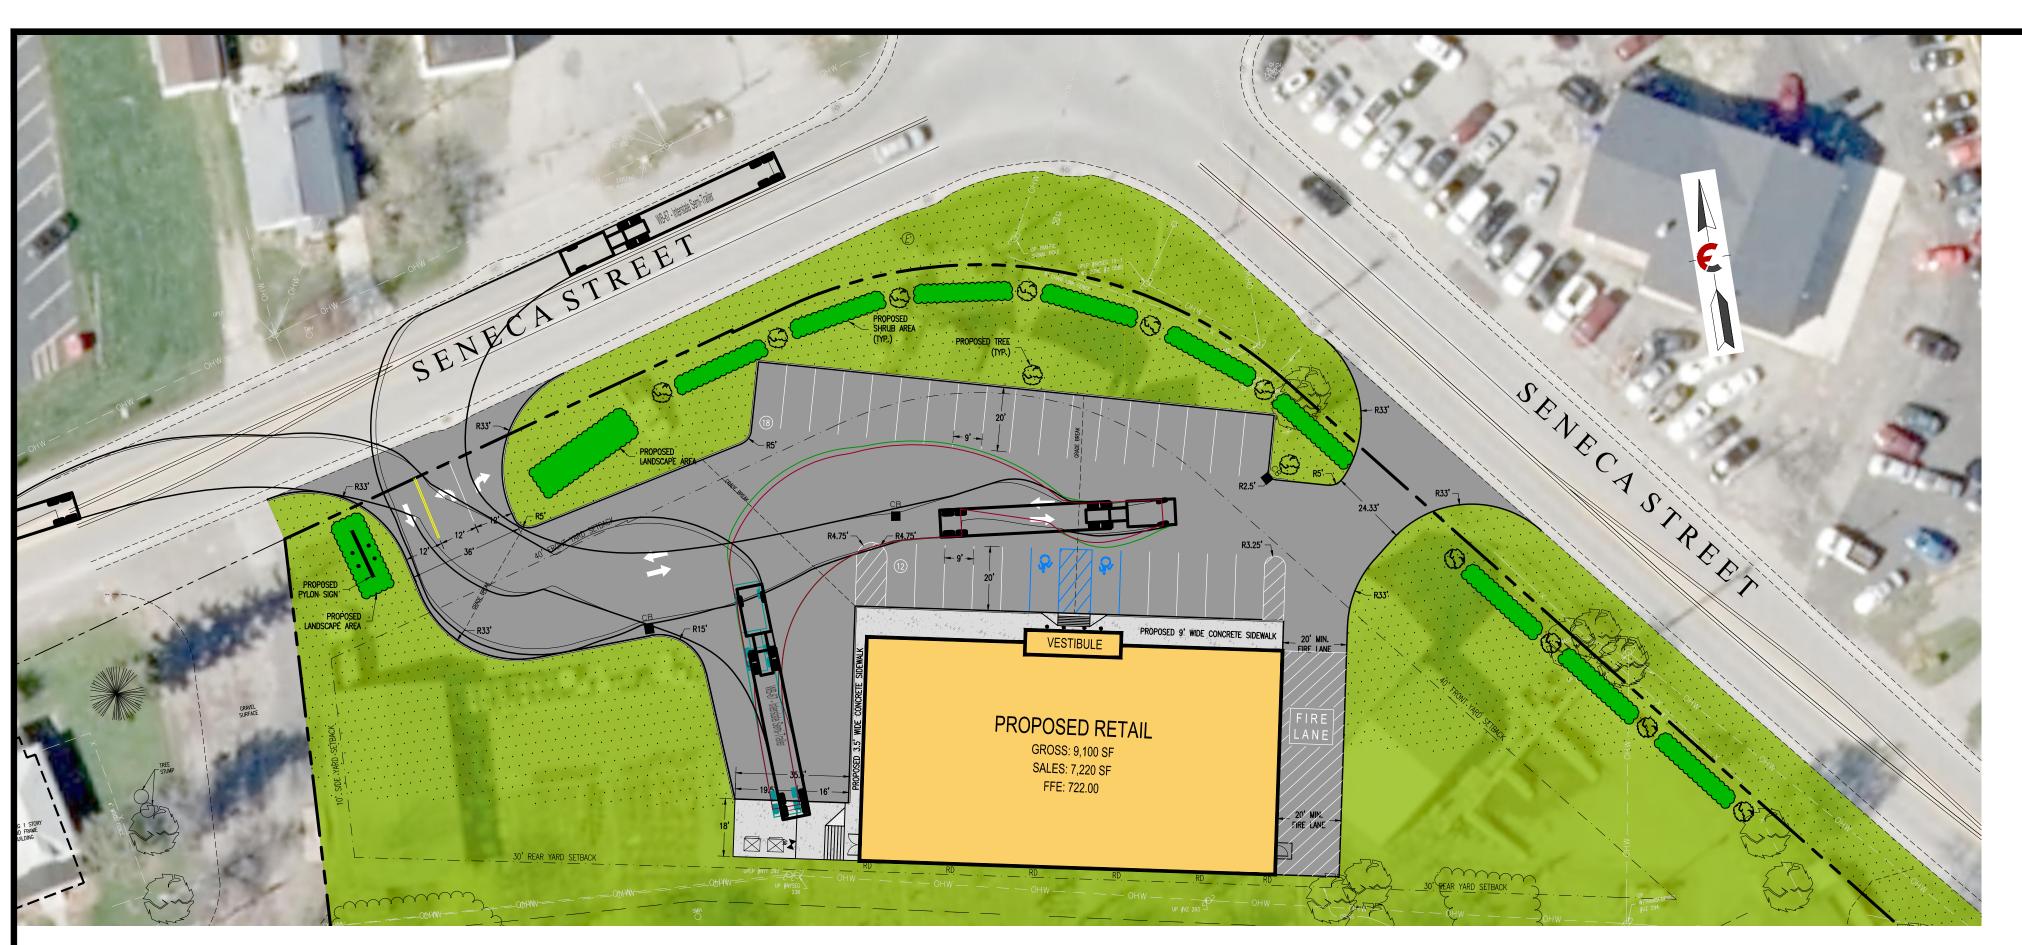
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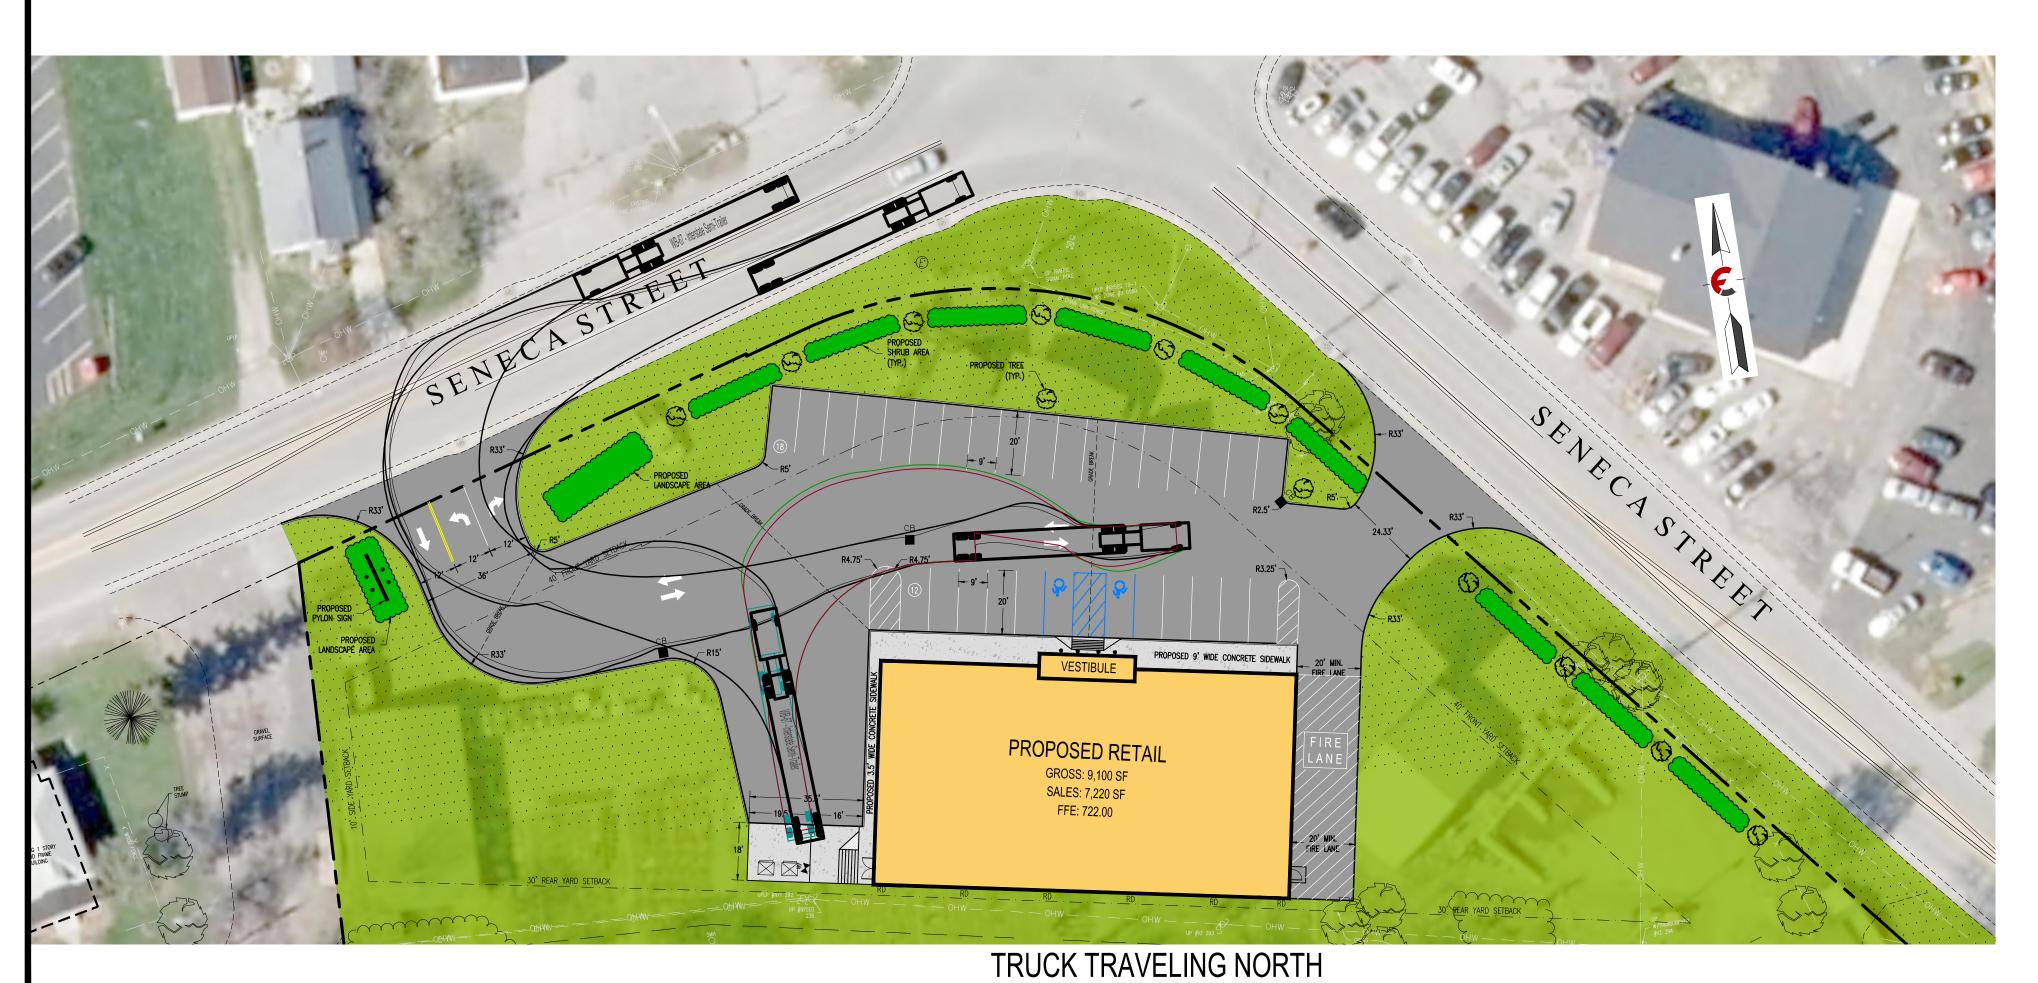
**E&S DETAILS** 

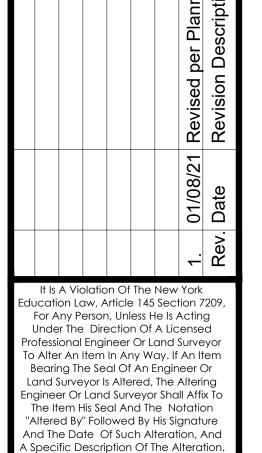


# TRUCK TRAVELING SOUTH

SCALE: 1"=30'

SCALE: 1"=30'



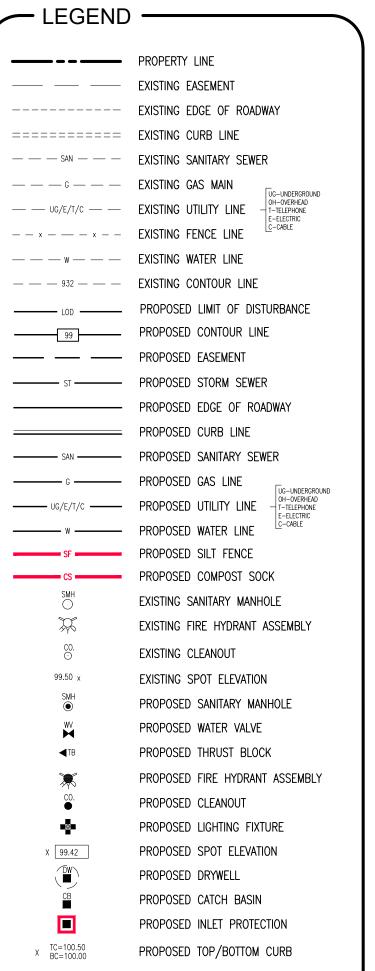


Utility information has been plotted from available sources and their locations and size should be considered approximate only. The contractor is responsible for determining exact utility locations, sizes, and elevations prior to commencing construction. If uncharted or misplotted utilities are encountered, the contractor is required to notify the

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Call three days before you dig!
1-800-962-7962 Dig Safely New York


(non-members must be contacted separately)

owner immediately.

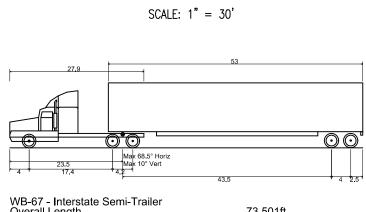

WB-67 - Interstate Semi-Trailer Overall Length Overall Width Overall Body Height Min Body Ground Clearance Max Track Width Lock-to-lock time Max Steering Angle (Virtual)

# TRUCK PROFILE

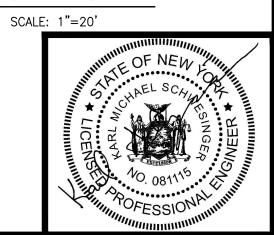

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1. O1/08/21 Rev. Date				01/08/21 Revised per Planning Board Comment	Revision Description
				01/08/21	Date
				<u> </u>	Rev.

It Is A Violation Of The New York Education Law, Article 145 Section 7209, For Any Person, Unless He Is Acting Under The Direction Of A Licensed Professional Engineer Or Land Surveyor To Alter An Item In Any Way. If An Item Bearing The Seal Of An Engineer Or Land Surveyor Is Altered, The Altering Engineer Or Land Surveyor Shall Affix To The Item His Seal And The Notation "Altered By" Followed By His Signature And The Date Of Such Alteration, And A Specific Description Of The Alteration

> dway Group **The Broa**



Scale:	As Noted
11x1	7 Prints are 1/2 Size
Date:	October 2020
Design By:	BMG
Drawn By:	BMG, CEL
	, , , , ,
Checked By:	KMS
Project No.:	2017.023.028
Drawing Name:	
-	17023.028-a.dwg

TRUCK ACCESS