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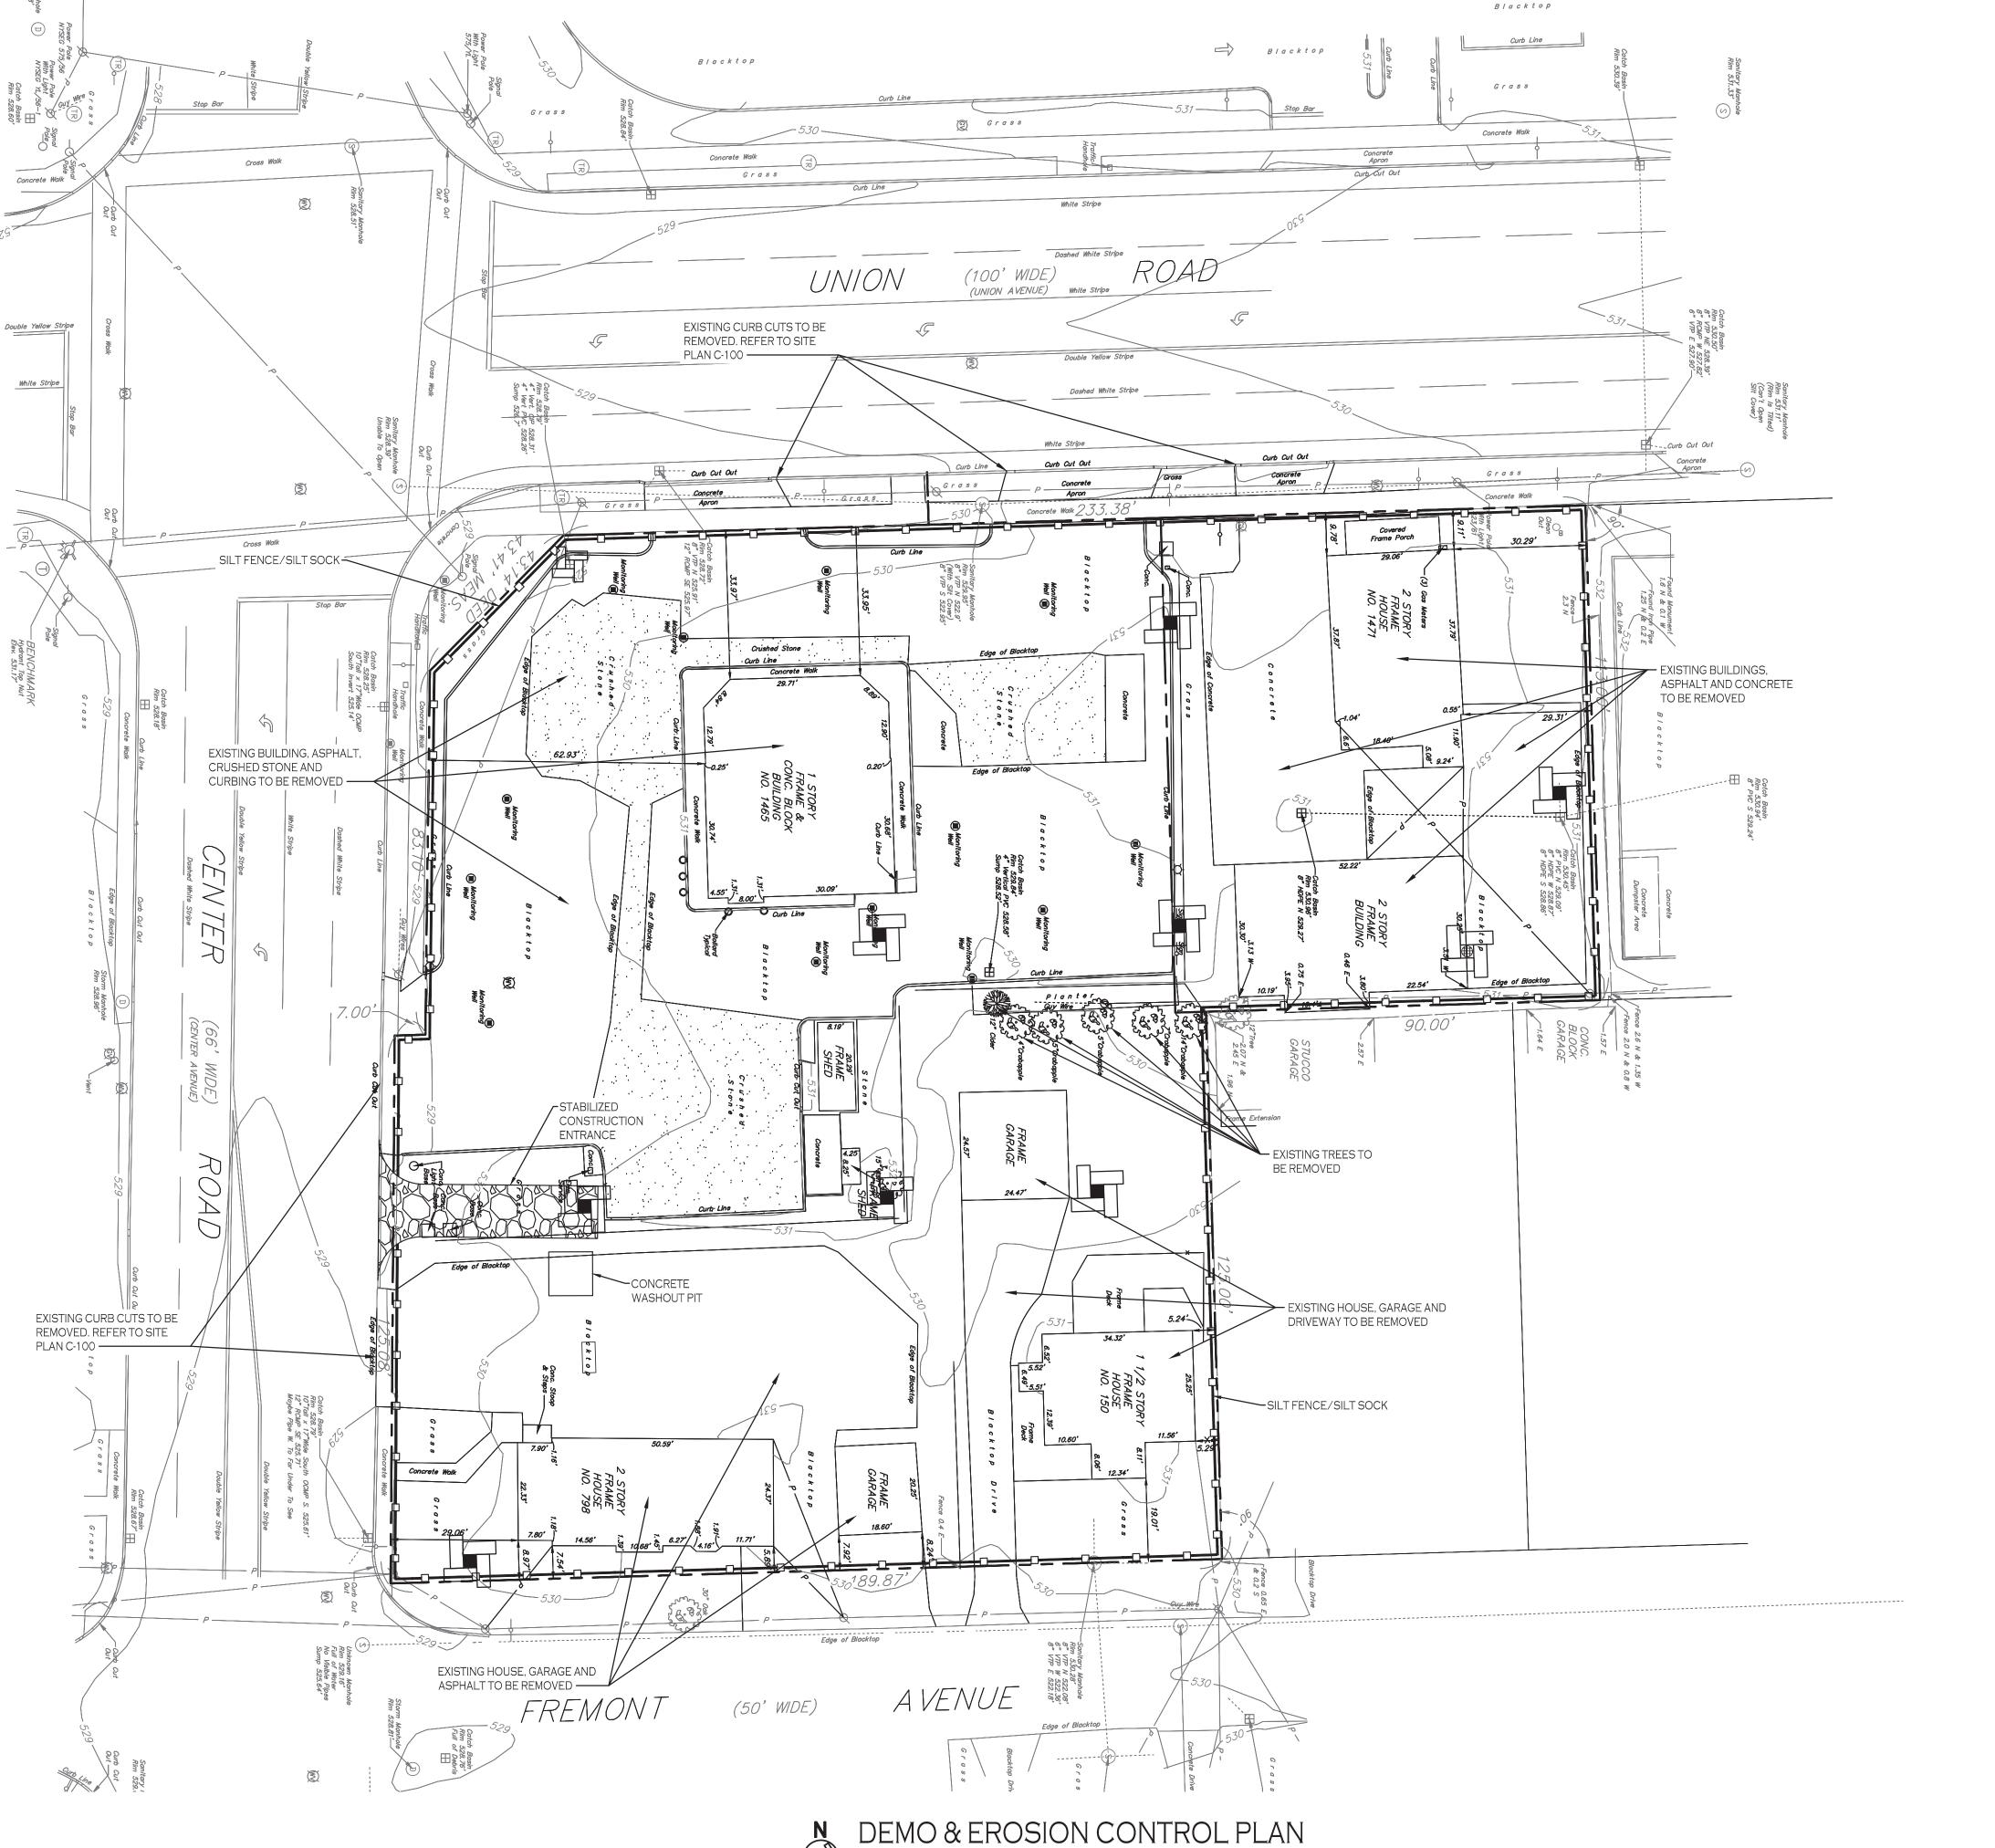
DRAWING NAME:

Demo & Erosion Control Plan

DRAWING NO.

Date:

Scale:



EROSION CONTROL NOTES

THE FOLLOWING EROSION CONTROL PROCEDURES SHALL BE ADHERED TO BY THE CONTRACTOR:

- 1. INSTALL TEMPORARY SILT FENCE BARRIERS AS DIRECTED BY THE OWNER AND AT ALL EXISTING STORMWATER CATCH BASINS WITHIN THE WORK AREA TO PREVENT SEDIMENT MIGRATION. ALL SILT FENCE BARRIERS SHALL BE INSTALLED IN ACCORDANCE WITH THE DETAILS SHOWN ON THE PLANS.
- 2. TOPSOIL SHALL BE STRIPPED AND STOCKPILED ON SITE FOR RE-USE AS DIRECTED BY THE OWNER. ALL LOCAL ORDINANCES REGARDING THE SALE OF TOPSOIL MUST BE FOLLOWED. TOPSOIL MAY NOT BE REMOVED WITHOUT A PERMIT.
- 3. ALL SILT FENCE BARRIERS SHALL BE REPLACED WHEREVER THEY BECOME CLOGGED OR
- 4. THE CONTRACTOR SHALL BE RESPONSIBLE FOR MAINTENANCE AND REMOVAL OF TEMPORARY SEDIMENTATION CONTROLS.
- 5. THE CONTRACTOR MUST CONTROL DUST DURING CONSTRUCTION. DURING EARTHWORK OPERATIONS, WATER-SPREADING EQUIPMENT SHALL BE PROVIDED BY THE CONTRACTOR, AND SPREAD WATER AS NECESSARY AND AS DIRECTED BY THE OWNER IN ORDER TO CONTROL DUST.
- 6. DIRT OR DEBRIS LEFT ON LOCAL PUBLIC ROADS AS A RESULT OF THIS CONSTRUCTION PROJECT SHALL BE REMOVED AND ROAD SURFACES CLEANED BY THE CONTRACTOR ON A DAILY BASIS.
- 7. ALL DISTURBED AREAS (EXCEPT AREAS TO BE PAVED OR BUILT UPON) SHALL BE TOPSOILED TO A MINIMUM 4" DEPTH AND SEEDED IMMEDIATELY AFTER FINE GRADING TAKES PLACE AND AS SOON AS PHYSICALLY POSSIBLE.
- 8. THE CONTRACTOR IS RESPONSIBLE FOR THE MAINTENANCE OF DOWNSTREAM STORM SEWERS, DITCHES, AND CULVERTS. SILT BUILDUP FOUND TO BE A RESULT OF THIS SITE CONSTRUCTION WORK SHALL BE REMOVED FROM DOWNSTREAM CULVERTS BY THE CONTRACTOR AT NO ADDITIONAL EXPENSE TO THE OWNER OR THE TOWN/CITY.
- 9. ALL SOIL EROSION AND SEDIMENT CONTROL DEVICES AND MATERIALS SHALL BE IN PLACE PRIOR TO BEGINNING EARTHWORK OPERATIONS AND SHALL BE MAINTAINED UNTIL THE NEW SLOPES ARE STABILIZED WITH SEEDING AND/OR SLOPE PROTECTION, AS DIRECTED BY THE ENGINEER.
- 10. INSTALL TEMPORARY SILT FENCE AROUND THE BASE OF STOCKPILES.
- 11. THE PROFESSIONAL CERTIFYING COMPLIANCE TO NYSDEC PHASE II STORMWATER REGULATION REQUIREMENTS MUST INSPECT AT A MINIMUM WEEKLY AND SHALL PROVIDE THESE INSPECTION REPORT WITH A WRITTEN CERTIFICATION OF CONSTRUCTION COMPLIANCE TO THE TOWN OF WEST SENECA WEEKLY.
- 12. THE ENGINEER OF RECORD FOR THIS PROJECT CERTIFIES THAT THESE DESIGN PLANS MEET THE REQUIREMENTS AND ARE IN COMPLIANCE WITH THE NEW YORK STORMWATER MANAGEMENT DESIGN MANUAL AND NYSDEC PHASE II STORMWATER REGULATION REQUIREMENTS. DUE TO SOIL DISTURBANCE BEING GREATER THAN ONE ACRE, A NYSDEC SPDES PERMIT MUST BE OBTAINED BEFORE ANY ON-SITE DISTURBANCE IS MADE.

- 1. THE CONTRACTOR SHALL TAKE PRECAUTIONS TO PROTECT THOSE ITEMS TO REMAIN, SUCH AS TREES, PROPERTY CORNER PINS, UTILITY POLES, VALVES, HYDRANTS, CURBS, MANHOLES AND CATCH BASINS.
- 2. TEMPORARY SILT FENCE AND STRAW BALES TO BE INSTALLED AS DIRECTED BY THE OWNERS FIELD REPRESENTATIVE. MAINTAIN UNTIL VEGATATION IS ESTABLISHED AND PAVEMENT IS INSTALLED.
- 3. FOR THOSE STRUCTURES TO BE DEMOLISHED, ALL EXISTING UTILITY SERVICES SHALL BE ABANDONED IN ACCORDANCE WITH LOCAL REGULATIONS, ALL METERS SHALL BE RETURNED TO PROPER OWNERS.
- 4. THE CONTRACTOR SHALL INSTALL STABILIZED CONSTRUCTION ENTRANCES WHERE ACCESSING THE SITE FROM PAVED ROADWAYS.
- 5. THE CONTRACTOR SHALL INSTALL TEMPORARY TRAFFIC CONTROL DEVICES IN ACCORDANCE WITH NYS M.U.T.C.D. STANDARDS PRIOR TO STARTING WORK.


DEMO & EROSION CONTROL LEGEND:

PROPOSED SILT FENCE/SILT SOCK

PROTECTION

INSTALL STORM DRAINAGE INLET

NOTE: BOUNDARY AND TOPOGRAPHIC INFORMATION PROVIDED BY OTHERS, CARMINA WOOD MORRIS, D.P.C. ASSUMES NO RESPONSIBILITY FOR ITS ACCURACY.

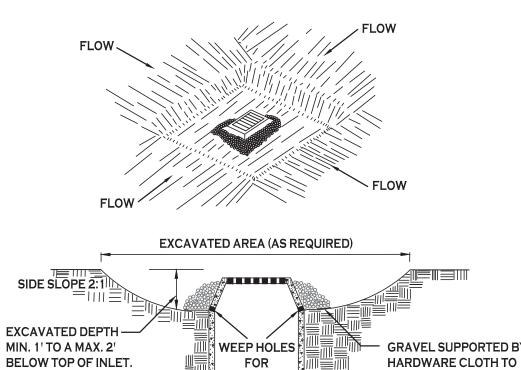

CONSTRUCTION SPECIFICATIONS

DEWATERING

- 1. CLEAR THE AREA OF ALL DEBRIS THAT WILL HINDER EXCAVATION.
- 2. GRADE APPROACH TO THE INLET UNIFORMLY AROUND THE BASIN.
- 3. WEEP HOLES SHALL BE PROTECTED BY GRAVEL.
- 4. UPON STABILIZATION OF CONTRIBUTING DRAINAGE AREA, SEAL WEEP HOLES, FILL BASIN WITH STABLE SOIL TO FINAL GRADE, COMPACT IT PROPERLY AND STABILIZE WITH PERMANENT SEEDING.


ALLOW DRAINAGE AND

RESTRICT SEDIMENT

MOVEMENT.

MAXIMUM DRAINAGE AREA 1 ACRE

INLET PROTECTION DETAIL 1 NOT TO SCALE

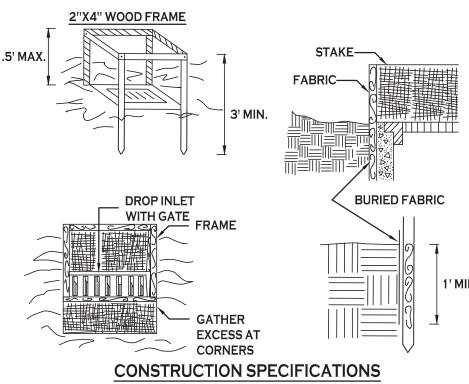

- 1. FILTER FABRIC SHALL HAVE AN EOS OF 40-85. BURLAP MAY BE USED FOR SHORT TERM APPLICATIONS.
- 2. CUT FABRIC FROM A CONTINUOUS ROLL TO ELIMINATE JOINTS. IF JOINTS ARE NEEDED THEY WILL BE OVERLAPPED TO THE NEXT STAKE.
- 3. STAKE MATERIALS WILL BE STANDARD 2" x 4" WOOD OR EQUIVALENT. METAL WITH A MINIMUM LENGTH OF 3 FEET.
- 4. SPACE STAKES EVENLY AROUND INLET 3 FEET APART AND DRIVE A MINIMUM 18 INCHES DEEP. SPANS GREATER THAN 3 FEET MAY BE BRIDGED WITH THE USE OF WIRE MESH BEHIND THE FILTER FABRIC FOR SUPPORT.
- 5. FABRIC SHALL BE EMBEDDED 1 FOOT MINIMUM BELOW GROUND AND BACKFILLED. IT SHALL BE SECURELY FASTENED TO THE STAKES AND FRAME.
- 6. A 2" x 4" WOOD FRAME SHALL BE COMPLETED AROUND THE CREST OF THE FABRIC FOR OVER FLOW STABILITY.

MAXIMUN DRAINAGE AREA 1 ACRE

INLET PROTECTION DETAIL 2 NOT TO SCALE


- CONCRETE BLOCK - 2:1 SLOPE GRAVEL FILTER STONE & BLOCK PLAN VIEW --- WIRE SCREEN **TEMPORARY** SEDIMENT POOL-DROP INLET **WITH GATE** STONE & BLOCK DETAIL **TEMPORARY** - SEDIMENT POOL WIRE MESH (OPTIONAL) 2'MAX FINE GRAVEL FACE (1'MIN. THICKNESS) "DOUGHNUT" DETAIL

CONSTRUCTION SPECIFICATIONS

- 1. LAY ONE BLOCK ON EACH SIDE OF THE STRUCTURE ON ITS SIDE FOR DEWATERING. FOUNDATION SHALL BE 2 INCHES MINIMUM BELOW REST OF INLET AND BLOCKS SHALL BE PLACED AGAINST INLET FOR
- 2. HARDWARE CLOTH OR 1/2" WIRE MESH SHALL BE PLACED OVER BLOCK OPENINGS TO SUPPORT
- 3. USE CLEAN STONE OR GRAVEL 1/2-3/4 INCH IN DIAMETER PLACED 2 INCHES BELOW TOP OF THE BLOCK ON A 2:1 SLOPE OR FLATTER.
- 4. FOR STONE STRUCTURES ONLY, A 1 FOOT THICK LAYER OF THE FILTER STONE WILL BE PLACED AGAINST THE 3 INCH STONE AS SHOWN ON THE DRAWINGS.

MAXIMUM DRAINAGE AREA 1 ACRE

INLET PROTECTION DETAIL 3 NOT TO SCALE

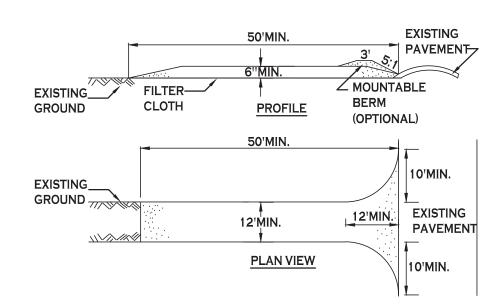



CONSTRUCTION SPECIFICATIONS

- 1. STONE SIZE USE 2" STONE, OR RECLAIMED OR RECYCLED CONCRETE EQUIVALENT.
- 2. LENGTH NOT LESS THAN 50 FEET (EXCEPT ON A SINGLE RESIDENCE LOT WHERE A 30 FOOT MINIMUM LENGTH WOULD APPLY).
- 3. THICKNESS NOT LESS THAN SIX (6) INCHES.
- 4. WIDTH TWELVE (12) FOOT MINIMUM, BUT NOT LESS THAN THE FULL WIDTH AT POINTS WHERE INGRESS OR EGRESS OCCURS. TWENTY-FOUR (24) FOOT IF SINGLE ENTRANCE
- 5. FILTER CLOTH WILL BE PLACED OVER THE ENTIRE AREA PRIOR TO PLACING OF
- 6. SURFACE WATER ALL SURFACE WATER FLOWING OR DIVERTED TOWARD CONSTRUCTION ENTRANCES SHALL BE PIPED ACROSS THE ENTRANCE. IF PIPING IS IMPRACTICAL, A MOUNTABLE BERM WITH 5:1 SLOPES WILL BE PERMITTED.
- 7. MAINTENANCE THE ENTRANCE SHALL BE MAINTAINED IN A CONDITION WHICH WILL PREVENT TRACKING OR FLOWING OF SEDIMENT ONTO PUBLIC RIGHTS-OF-WAY, ALL SEDIMENT SPILLED, DROPPED, WASHED OR TRACTED ONTO PUBLIC RIGHTS-OF-WAY MUST BE REMOVED IMMEDIATELY.
- 8. WHEN WASHING IS REQUIRED, IT SHALL BE DONE ON A AREA STABILIZED WITH STONE AND WHICH DRAINS INTO AN APPROVED SEDIMENT TRAPPING DEVICE.
- 9. PERIODIC INSPECTION AND NEEDED MAINTENANCE SHALL BE PROVIDED AFTER EACH

STABILIZED CONSTRUCTION ENTRANCE DETAIL

NOTE: INSTALL ONE OF THE INLET PROTECTION OPTIONS SHOWN PRIOR TO CONSTRUCTION

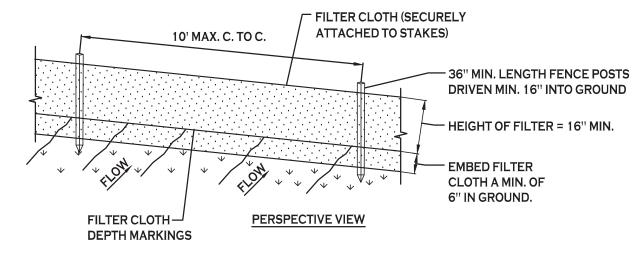


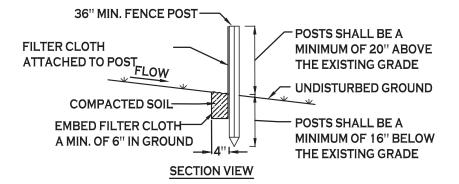

CONSTRUCTION SPECIFICATIONS

- 1. WOVEN FENCE TO BE FASTENED SECURELY TO FENCE POSTS WITH WIRE TIES OR STAPLES. POSTS SHALL BE STEEL EITHER "T" OR "U" TYPE OR HARDWOOD.
- 2. WHEN TWO SECTIONS OF FILTER CLOTH ADJOIN EACH OTHER THEY SHALL BE OVER-LAPPED BY SIX INCHES AND FOLDED. FILTER CLOTH SHALL BE EITHER FILTER X, MIRAFI 100X, STABILINKA T140N, OR APPROVED EQUIVALENT.
- 3. MAINTENANCE SHALL BE PERFORMED AS NEEDED AND MATERIAL REMOVED WHEN "BULGES" DEVELOP IN THE SILT FENCE.

SILT FENCE DETAIL NOT TO SCALE

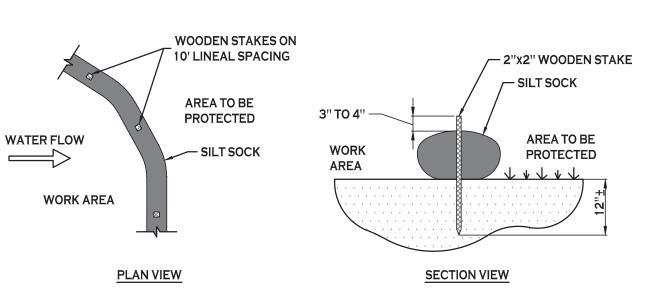


NOTES:

OF CONSTRUCTION PROJECT.

CONTRACTOR SHALL REMOVE SEDIMENT COLLECTED AT THE BASE OF THE SILT SOCK WHEN IT HAS REACHED ¹/₂ OF THE EXPOSED HEIGHT OF THE SILT SOCK. ALTERNATIVELY, RATHER THAN CREATE A SOIL DISTURBING ACTIVITY, THE ENGINEER MAY CALL FOR ADDITIONAL SILT SOCK TO BE ADDED AT AREAS OF HIGH SEDIMENTATION, PLACED IMMEDIATELY ON TOP OF THE EXISTING SEDIMENT LADEN SILT SOCK.

> SILT SOCK DETAIL NOT TO SCALE

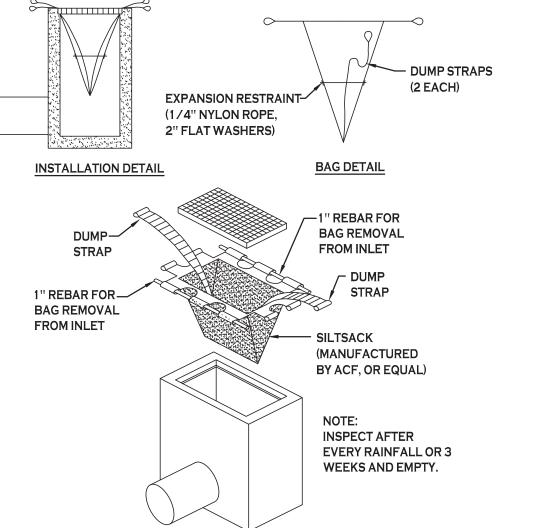

SILT SACK DETAIL NOT TO SCALE



for

Drawn by: Scale:

DRAWING NAME: Demo & Erosion **Control Details**

8/24/21

A. Pandolfe

As Noted

uilding

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DRAWING NO.

CONTRACTOR SHALL INSPECT AND MAINTAIN SILT SOCK AS NEEDED DURING THE DURATION

SITE DATA SITE AREA = PARCEL 1 (0.25 ACRES) & PARCEL 2 (0.97 ACRES) ZONED: C-2 (S) (COMMERCIAL DISTRICT) - UNION ROAD CORRIDOR BUILDING AREAS: 2-STORY (3,080 SF FOOTPRINT) OFFICE BUILDING & 3,057 SF RESTAURANT REQUIRED PROVIDED FRONT: 20 FT MAX. 5.0 FT SIDE: 5 FT MIN. 11.30 FT 30 FT MIN. 22.0 FT* REQUIRED **PROVIDED** FRONT: N/A N/A SIDE (ABUTTING R DISTRICT) 10 FT MIN. 10.0 FT 10 FT MIN. 10.0 FT 47 SPACES* 82 SPACES PARKING (9' x 18'): MAX. BUILDING HEIGHT: 40 FT < 40 FT

PARKING CALCULATION:

*VARIANCE REQUIRED

"PROFESSIONAL OFFICE" (PARCEL 1)
1 SPACE PER 100 SF OF GROSS FLOOR AREA 6,160 SF / 100 = <u>62 SPACES REQUIRED</u>

"RESTAURANT" (PARCEL 2) 2 SPACES PER 5 SEATS 50 SEATS / 5 * 2 = 20 SPACES REQUIRED

82 TOTAL SPACES REQUIRED

- 1. ALL RADII SHALL BE 3'-0" UNLESS OTHERWISE
- 2. ALL DISTURBED AREAS: SHALL HAVE 4" MIN. OF
- TOPSOIL & SEED. 3. ALL DIMENSIONS FROM PROPERTY LINES SHALL BE MEASURED PERPENDICULAR TO THE PROPERTY
- 4. CENTER ENTRANCE SIDEWALKS ON DOOR
- OPENINGS. 5. BUILDING DIMENSIONS ARE APPROXIMATE, REFER TO ARCHITECTURAL DRAWINGS FOR LAYOUT

GENERAL NOTES:

RELOCATE EXISTING SIGN

INSTALL "NO LEFT TURN" SIGN, M.U.T.C.D. SIGN NO. R3-2

9 EDGE OF PAVEMENT

1 1 DECORATIVE WALL

10 PAINTED TRAFFIC ARROWS

(12) LIGHT POLE FOUNDATION

(11) 6-FT BOARD ON BOARD FENCE


DIMENSIONS.

- 1. INSTALL ALL MATERIALS TO MANUFACTURER'S RECOMMENDATIONS AND BEST STANDARDS OF TRADE INVOLVED.
- 2. SUBSTITUTIONS SHALL BE MADE ONLY WITH OWNER'S APPROVAL AND BE OF EQUIVALENT QUALITY TO WHAT IS SPECIFIED.
- 3. WORK SHALL BE COMPLETED IN STRICT ACCORDANCE WITH ALL LOCAL CODES AND OSHA
- SAFETY RULES AND REGULATIONS. 4. VERIFY ALL EXISTING CONDITIONS AND DIMENSIONS AT THE SITE. NOTIFY OWNER & ENGINEER
- OF DISCREPANCIES IN CONDITIONS SHOWN ON DRAWINGS PRIOR TO PROCEEDING WITH THE 5. CONTRACTOR SHALL BE RESPONSIBLE FOR PROTECTION OF ANY EXISTING STRUCTURES TO
- REMAIN AND ANY FINISH MATERIAL INSTALLED WHILE WORKING ON OTHER COMPONENTS. 6. CONTRACTOR SHALL KEEP JOB FREE OF DEBRIS AND MAKE FINAL CLEANUP TO
- SATISFACTION OF OWNER.
- 7. CONTRACTOR SHALL ASCERTAIN THE LOCATION OF ALL UTILITIES PRIOR TO CONSTRUCTION SO THAT THIS WORK WILL NOT DISTURB EXISTING LINES AND/OR INSTALLATIONS.
- COORDINATE ALL WORK WITH THE APPLICABLE UTILITY COMPANIES. 8. CONTRACTOR SHALL OBTAIN AND PAY FOR ALL REQUIRED PERMITS NECESSARY TO PERFORM

SITE LEGEND PROPERTY LINE ____ PROPOSED CONCRETE CURB PROPOSED CONCRETE SIDEWALK PROPOSED ASPHALT PAVEMENT 3\ LANDSCAPED AREA - SEE LANDSCAPE PLAN, IF NO PLANTINGS, INSTALL TOPSOIL & SEED PROPOSED SIGN PROPOSED PARKING NUMBER PROPOSED LIGHT POLE

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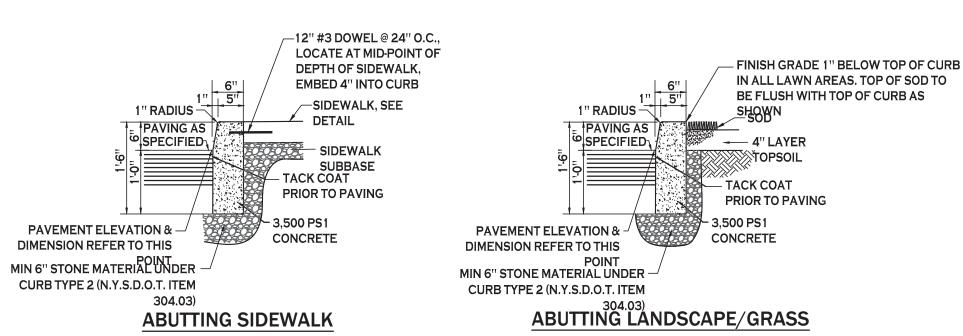
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8/24/21 Drawn by: A. Pandolfe As Noted

Scale: **DRAWING NAME:**

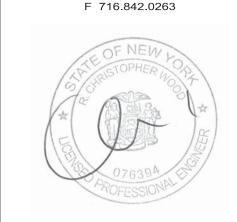Site Plan

DRAWING NO.



1. CONTROL JOINTS TO BE 2" DEEP AT 15'-0" O.C. - SEE SPECIFICATIONS FOR FURTHER JOINT REQUIREMENTS NYSDOT 702-0700.

2. WHERE THE CURB DROPS (IS FLUSH WITH ASPHALT) THE DEPTH OF CURB BELOW GRADE SHALL BE INCREASED TO 1'-6" AND OTHER DIMENSIONS ADJUSTED ACCORDINGLY.

TYPE "A" CONCRETE CURB - 1

PARKING

ANY TIME

 \leftrightarrow

HANDICAPPED PAVEMENT MARKINGS - 5

CENTER TO

CENTER

DUMPSTER /

6' HIGH BOARD ON— 5' WIDE SIDEWALK

BOARD FENCE, SEE TO ACCESS GATE,

VIEW

____ 1" X 6" BOARD

___ 2" X 6" TOP RAILS

3-20# NAILS ATTACHED

TO RAIL POST (EACH SIDE)

2" X 6" CENTER RAILS

_ 2" X 6" BOTTOM RAILS

3,000 PSI CONC.

SECTION A-A

- 3" Ø GALVANIZED STEEL POST,

12" DIA. HOLE, FILL WITH

- 2'-0" GRAVEL FILL

TREATED PINE.

1. ALL WOODEN FENCE MATERIAL TO BE PRESSURE

2. CENTER, BOTTOM AND TOP RAILS TO BE FASTENED

3. ATTACH EACH 1" X 6" BOARD TO RAILS USING (3)

GALVANIZED NAILS AT EACH RAIL LOCATION.

4. WOOD POSTS CAN BE SUBSTITUTED FOR STEEL.

SIMPSON PIPE GRIP TIES OR EQUAL. ALL

HARDWARE TO BE GALVANIZED.

TO 3" Ø GALVANIZED STEEL FENCE POSTS USING

8'-0" O.C. 12' LONG (8' HIGH FENCE) 8'-0" O.C. 10' LONG (6' HIGH FENCE)

EXTEND TO

ASPHALT DRIVE

CONCRETE CURB OR EDGE

2'-0" (TYP) 45° (TYP)/

3" DIAMETER

6" Ø PIPE BOLLARD SET IN CONTRETE 3'

(TYP. OF 4)

<u>@</u> <u>@</u>

BELOW GRADE, EXTEND 4' ABOVE GRADE,

FILL W/CONCTRETE, PAINT OSHA YELLOW

GALVANIZED STEEL POST

OF PAVEMENT (SEE PLAN).

12" X 18" RED ON WHITE (M.U.T.C.D. SIGN NO. P1-1C),

MOUNTED, SEE SITE PLAN) FOR INSTALLATION IN

NO PARKING SIGN (SEE DETAIL), LOCATE

PAVEMENT, SEE HANDICAPPED PARKING SIGN DETAIL.

7' ABOVE GRADE, MOUNT ON 2"Ø PIPE

AS SHOWN ON SITE PLAN

SIGN (SEE DETAIL)

FACING PARKING AISLE (MAY BE BUILDING

HANDICAPPED PARKING

TRAFFIC YELLOW 4" WIDE

PAINTED LINE (TYP)

HANDICAP SYMBOL - 5A

INTERNATIONAL

-6" DIAMETER STEEL PIPE

SUPPLIED BY OWNER

(TYP. EACH SIDE)

1' x 1' CHAMFER (TYP.

EACH SIDE)

SLEEVE FOR 3/4" DROP

CONCRETE, 1 1/2" RECESS

PROVIDE 1 FOR EACH SIDE

EDGE OF CONCRETE

-ROD, AT GRADE WITH

TYP.

OF GATE

— DOUBLE GATE - CHAIN LINK FENCE

DROP ROD (120° SWING MIN.)

-3' WIDE CHAIN LINK FENCE GATE &


STRIPS, GATE TO HAVE LATCHING

MECHANISM TO KEEP CLOSED WHEN

FRAME WITH VINYL SCREENING

NOT BEING ACCESSED

W/VINYL SCREENING STRIPS AND

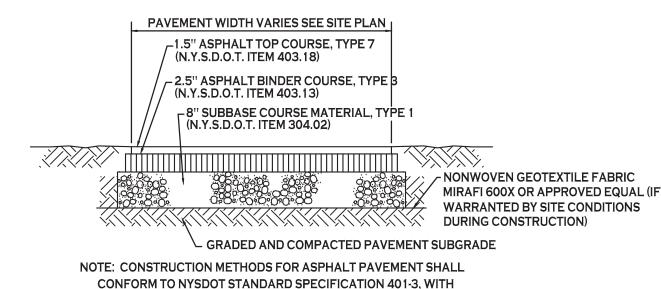

SUBBASE CONSTRUCTION METHODS CONFORMING TO NYSDOT

STANDARD DUTY ASPHALT SECTION - 2

STANDARD SPECIFICATION 304-3.

WHITE REFLECTIVE

SYMBOL TO BE CENTERED IN PARKING SPACE

INTERNATIONAL

HANDICAP SYMBOL - 5A

12'-0"

CENTER TO

CENTER

OPENING - FACE TO

DROP ROD -

FRONT

VIEW

DUMPSTER ENCLOSURE - 9

NOT TO SCALE

FRAME

FACE

DOUBLE GATE

LATCH —

ALL WELDED JOINTS

TO MAKE SOLID

FRAME

- SAFETY BLUE

BACKGROUND


NEW CONCRETE (MIN. 3500 PSI)

– SIDEWALK - 4" MIN. THK. **EXPANSION JOINT** DRIVEWAY - 6" MIN THK. W/W.W.F.6X6/10X10 1/2" RECESS SLOPE - GRASS AREA EXISTING SIDEWALK \ 1/4"/FT **PAVEMENT** FORM SUBBASE-- STONE SUBBASE MATERIAL TYPE 2 (N.Y.S.D.O.T. ITEM 304.03) MIN. 4" THK (SIDEWALK) MIN. 5" THK (DRIVEWAY)


CONTROL JOINTS TO BE AT 5'-0" O.C., BOTH WAYS WHERE APPLICABLE, SEE SPECIFICATIONS FOR FURTHER JOINT REQUIREMENTS NYSDOT 702-0700.

- 2. CONCRETE SIDEWALK AND DRIVEWAY MATERIAL SHALL CONFORM TO NYSDOT STANDARD SPECIFICATION 501 AND CONSTRUCTION METHODS SHALL CONFORM TO **NYSDOT STANDARD SPECIFICATION 608-3.**
- 3. SUBBASE GRADE SHALL FOLLOW THE PROPOSED GRADE OF THE SIDEWALK AND SLOPE AWAY FROM BUILDING WHERE APPLICABLE, PROVIDE CONTINUOUS STONE PATH TO CURB UNDERDRAIN WHERE PROVIDED.
- 4. FULL DEPTH EXPANSION JOINTS SHALL BE INSTALLED EVERY 20' O.C., BOTHWAYS WHERE APPLICABLE. SEE SPECIFICATIONS FOR FURTHER JOINT REQUIREMENTS
- 5. SEE CURB DETAIL FOR DOWLING REQUIREMENTS WHERE ABUTTING CURB.
- 6. INSTALL 6" LONG #3 DOWELS @ 12" O.C. WHERE SIDEWALK ABUTS A BUILDING WALL AT AN ENTRANCE, THICKEN SIDEWALK TO 6" AT BUILDING WALL AND INSTALL DOWEL CENTERED IN THE 6" DEPTH. DOWELS AND THICKENING OF SIDEWALK SHALL EXTEND 18" EITHER SIDE OF ENTRANCE.
- 7. INSTALL 1/2" PREMOLDED EXPANSION JOINT WITH BACKER ROD & SEALANT WHERE SIDEWALK ABUTS BUILDING OR OTHER STRUCTURE.

CONCRETE SIDEWALK - 3 NOT TO SCALE

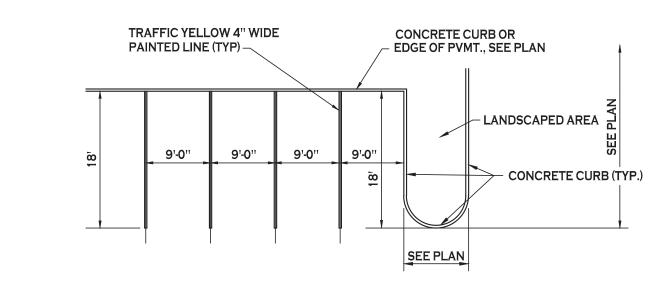

90° PARKING STALL LAYOUT - 4

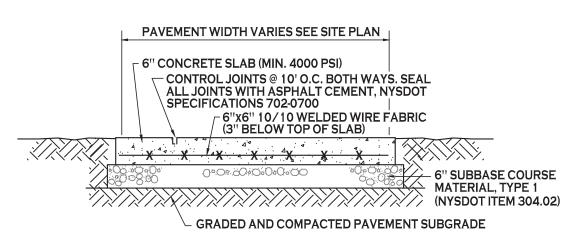

NOTE: CONCRETE PAVEMENT MATERIAL SHALL CONFORM TO NYSDOT STANDARD SPECIFICATION 501 AND CONSTRUCTION METHODS SHALL CONFORM TO NYSDOT STANDARD SPECIFICATION 502-3.

NOTE: TACTILE WARNING

OR CURRENT UPDATE

DEVICES SHALL BE PER ICC/ANSI

A117.1-1998, SECTION 705.3.1.2

EXTERIOR CONCRETE SLAB ON GRADE - 8

NOT TO SCALE


- 2" SQR. GALVANIZED PUNCH TUBE (BLDG. WALL) OR-DOME SECTION BACKFILL, TOPSOIL & SEED 1:12 (6" WIDE CURB) — SLOPE SLOPE - GRADE TC 99.90 BC 99.40 TOP OF CONCRETE BC 99.40 - 3,500 PS1 CONCRETE BC 99.35 - 1'-6" DIA. CONCRETE BASE DOME SPACING **TACTILE WARNING**

FIELD, COLOR TO

CONTRAST WITH RAMP—

NOTE: ELEVATIONS & DIMENSIONS SHOWN ARE TO ILLUSTRATE GRADE CHANGE ONLY, SEE SITE & GRADING PLAN FOR ACTUAL DATUM & DIMENSIONS

HANDICAPPED PAVEMENT RAMP - 7 NOT TO SCALE

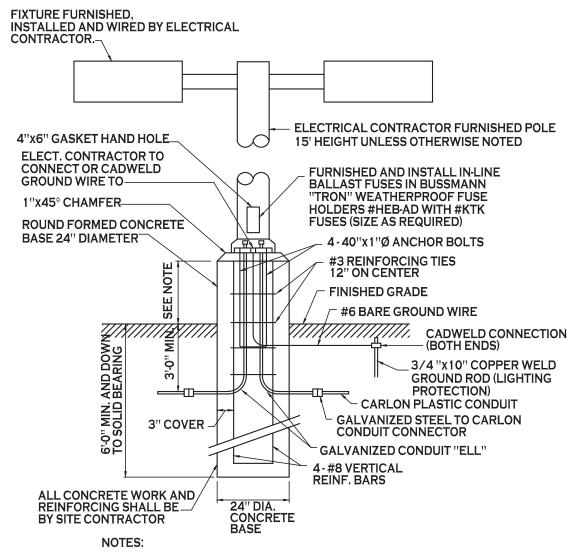

1. FOR LOCATIONS OF FOUNDATIONS SEE SITE PLAN 2. FOR LIGHT FIXTURE ORDERING INFORMATION SEE SITE LIGHTING PLAN 3. LIGHT POLE BASE EXPOSURE ABOVE GRADE SHALL BE: IN CURBED ISLANDS: 6" ABOVE TOP OF CURB ELEVATION IN PAVEMENT: 3' ABOVE GRADE IN NON-CURBED GRASS AREAS: 6" ABOVE GRADE

LIGHT POLE FOUNDATION - 12 NOT TO SCALE

CHAIN LINK FENCE GATE NOTES:

— FENCE GATE POST 4"Ø

STANDARD WEIGHT, SCH. 40.

HOT DIPPED GALVANIZED W/

MIN. 1.8 OZ/SF OF ZINC (TYP.)

- DOUBLE GATE - CHAIN LINK

STRIPS AND DROP ROD

FENCE W/VINYL SCREENING

1. GATE POST FOOTINGS TO BE MIN. 36" DEEP x (4x) POST DIAMETER, EXTEND POST TO WITHIN 6" OF BOTTOM.

HANDICAPPED PARKING SIGN


PARKING


1. HANDICAPPED PARKING SIGN SHALL CONFORM WITH CURRENT STATE AND LOCAL CODES AND REGULATIONS.

HANDICAP PARKING SIGN - 6

M.U.T.C.D. SIGN NO. P4-6C -

- 2. GATE FRAMES TO BE 2" SQ. GALVANIZED STEEL, WEIGHING 2.60 LB/FT IN ACCORDANCE WITH ASTM F
- 3. CHAIN LINK FENCE FABRIC SHALL BE 2" MESH, 9 GAUGE, ZINC COATED STEEL CORE WIRE. INSTALL MESH WITH HOOK BOLTS AND TENSION BARS ON ALL 4 SIDES, ATTACH AT 15" MAX.
- 4. DOUBLE GATE LATCH TO BE FORKED TYPE CAPABLE OF RETAINING GATE IN CLOSED POSITION AND HAVE PROVISION FOR PAD LOCK. LATCH SHALL BE OPERABLE FROM EITHER SIDE OF GATE.
- 5. ALL HARDWARE TO BE HOT DIPPED GALVANIZED STEEL TO SUIT GATE SIZE.

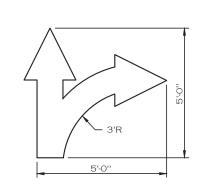

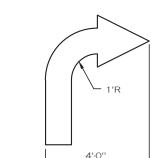

PAINTED TRAFFIC ARROWS - 10

6-FT BOARD ON BOARD FENCE - 11 NOT TO SCALE

GRADE -

Wood **Morris** 487 Main Street Suite 600 Buffalo, New York 14203 P 716.842.3165 F 716.842.0263

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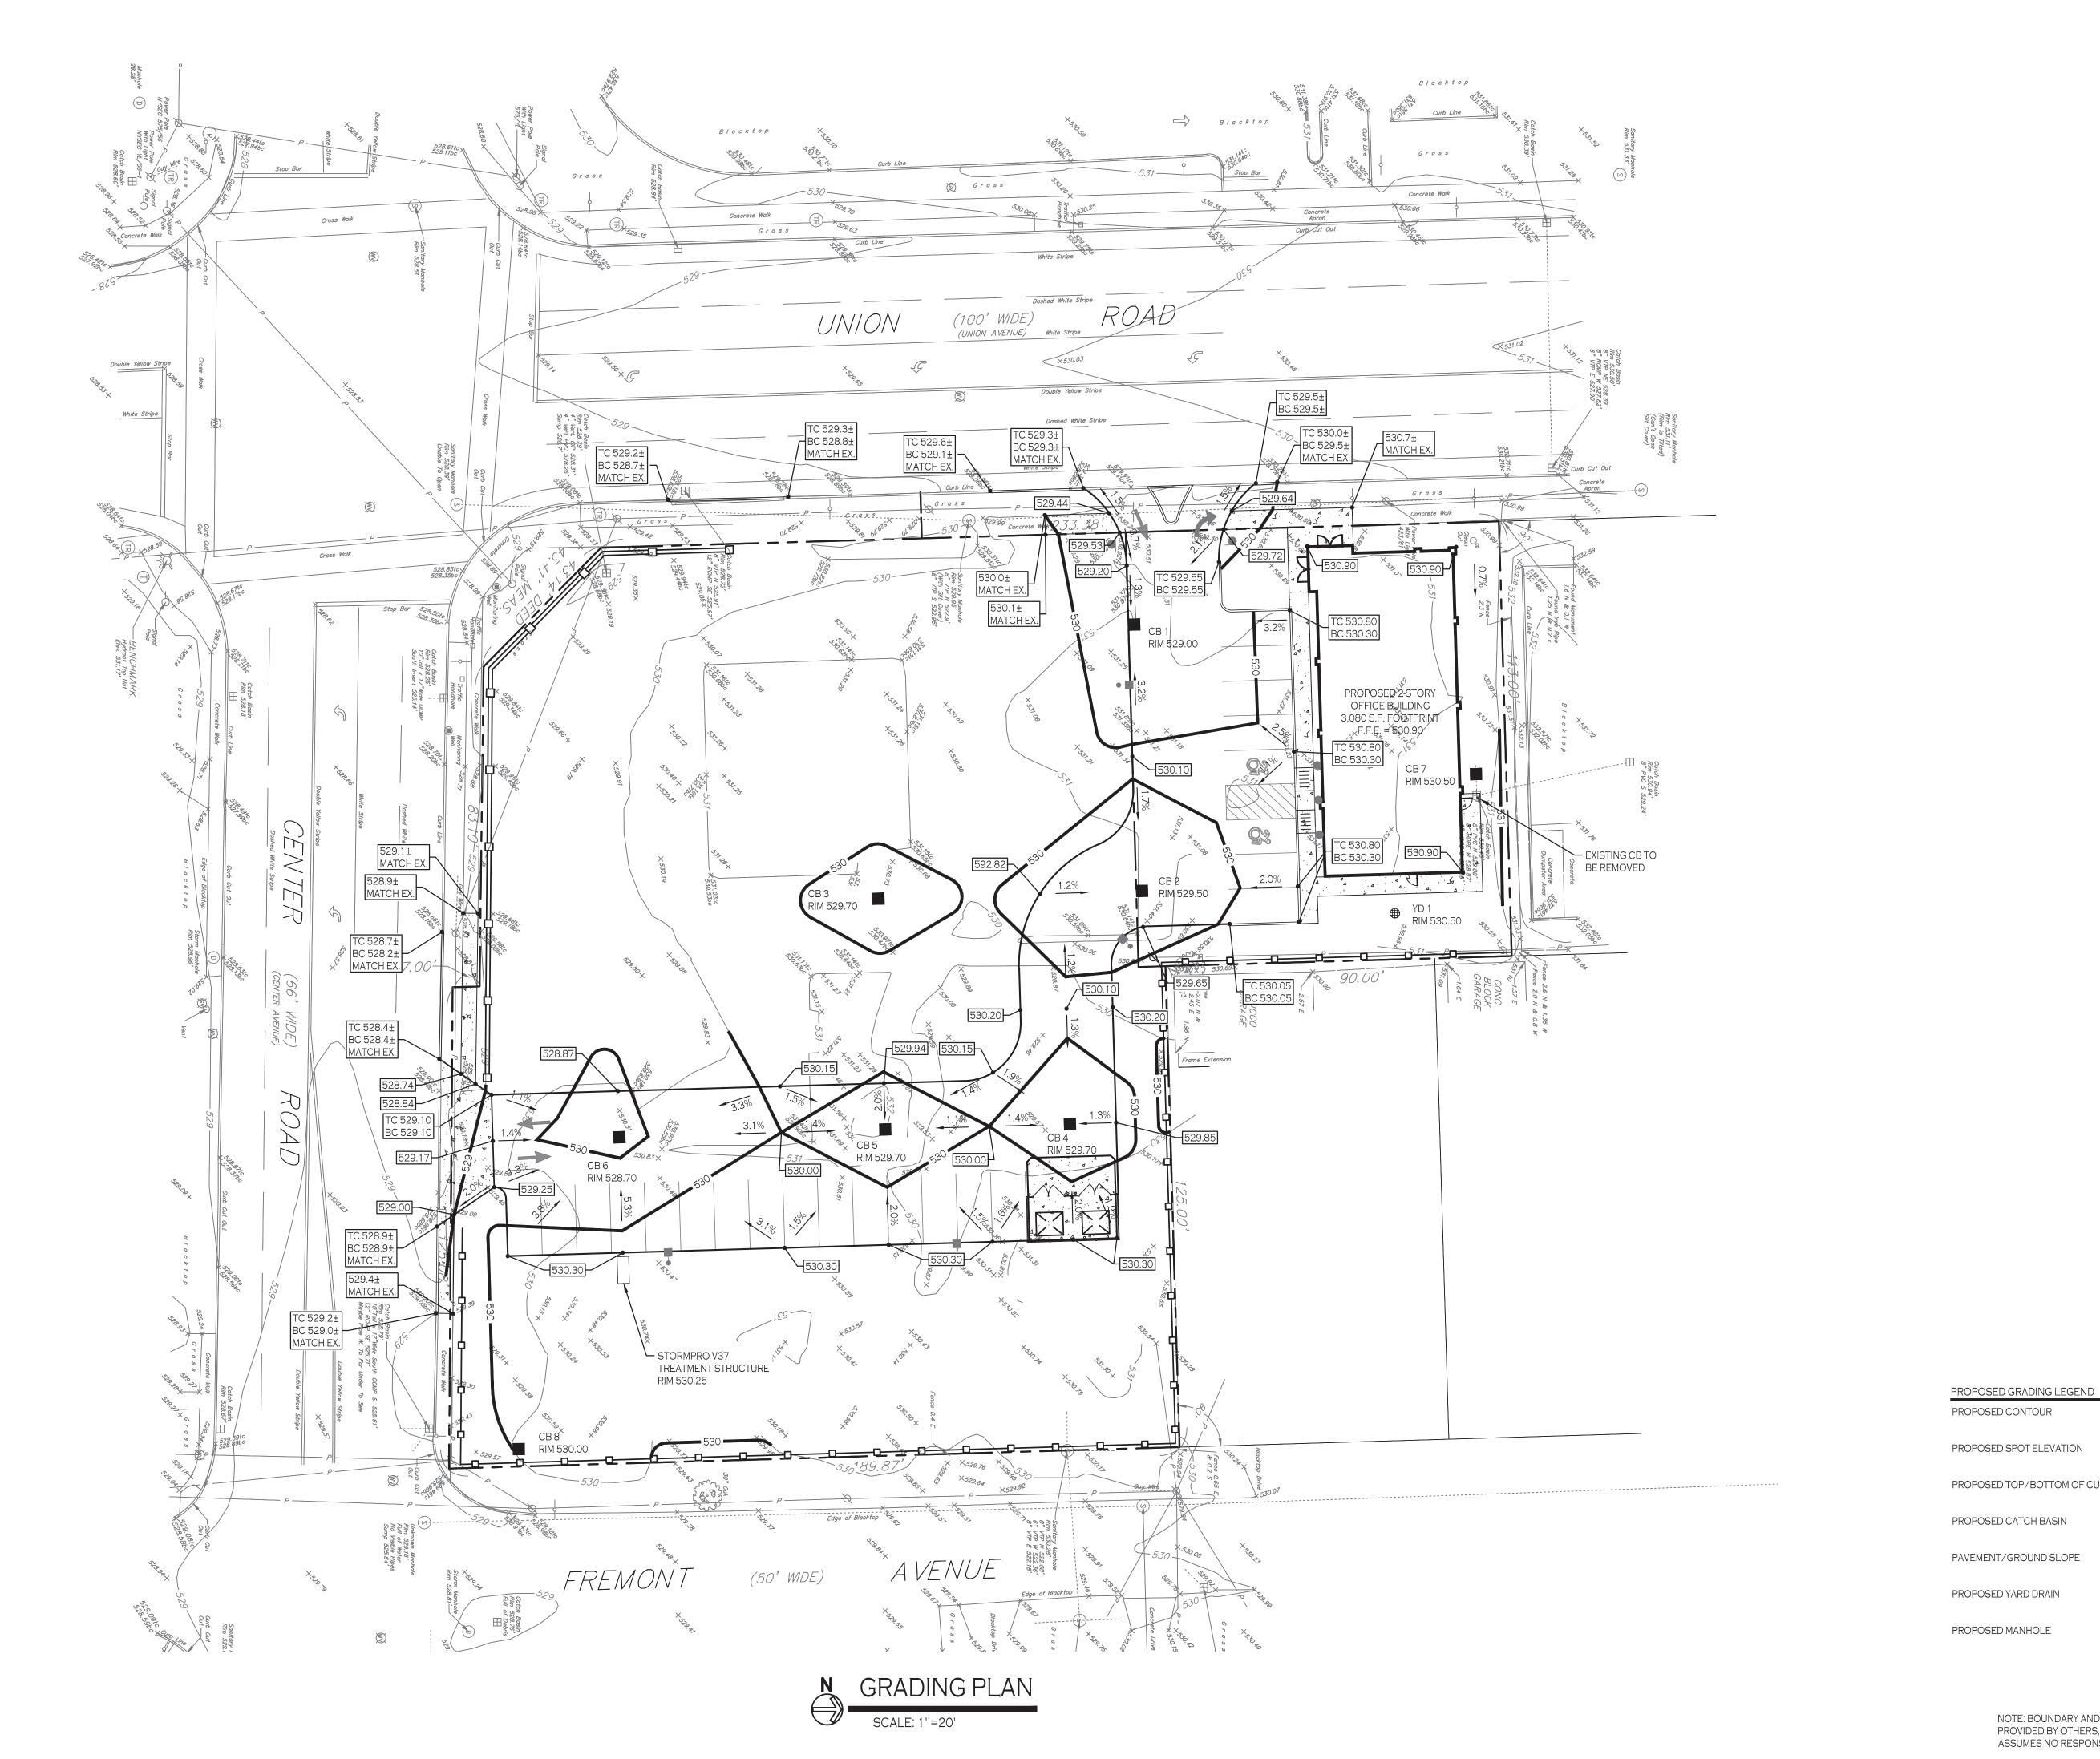
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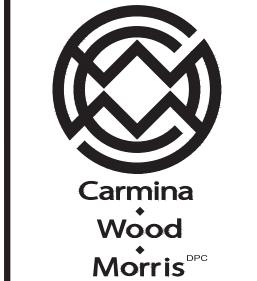
8/24/21 Drawn by: A. Pandolfe As Noted


DRAWING NAME Site Details

Scale:

DRAWING NO.





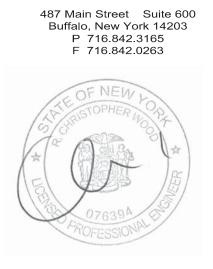

Building

8/24/21 A. Pandolfe As Noted Date: Drawn by: Scale:

DRAWING NAME:

Grading Plan

DRAWING NO.

Project no.: 20.150

NOTE: BOUNDARY AND TOPOGRAPHIC INFORMATION PROVIDED BY OTHERS, CARMINA WOOD MORRIS, D.P.C. ASSUMES NO RESPONSIBILITY FOR ITS ACCURACY.

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100.80

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PROPOSED CONTOUR

PROPOSED SPOT ELEVATION


PROPOSED CATCH BASIN

PAVEMENT/GROUND SLOPE

PROPOSED YARD DRAIN

PROPOSED MANHOLE

PROPOSED TOP/BOTTOM OF CURB ELEV.

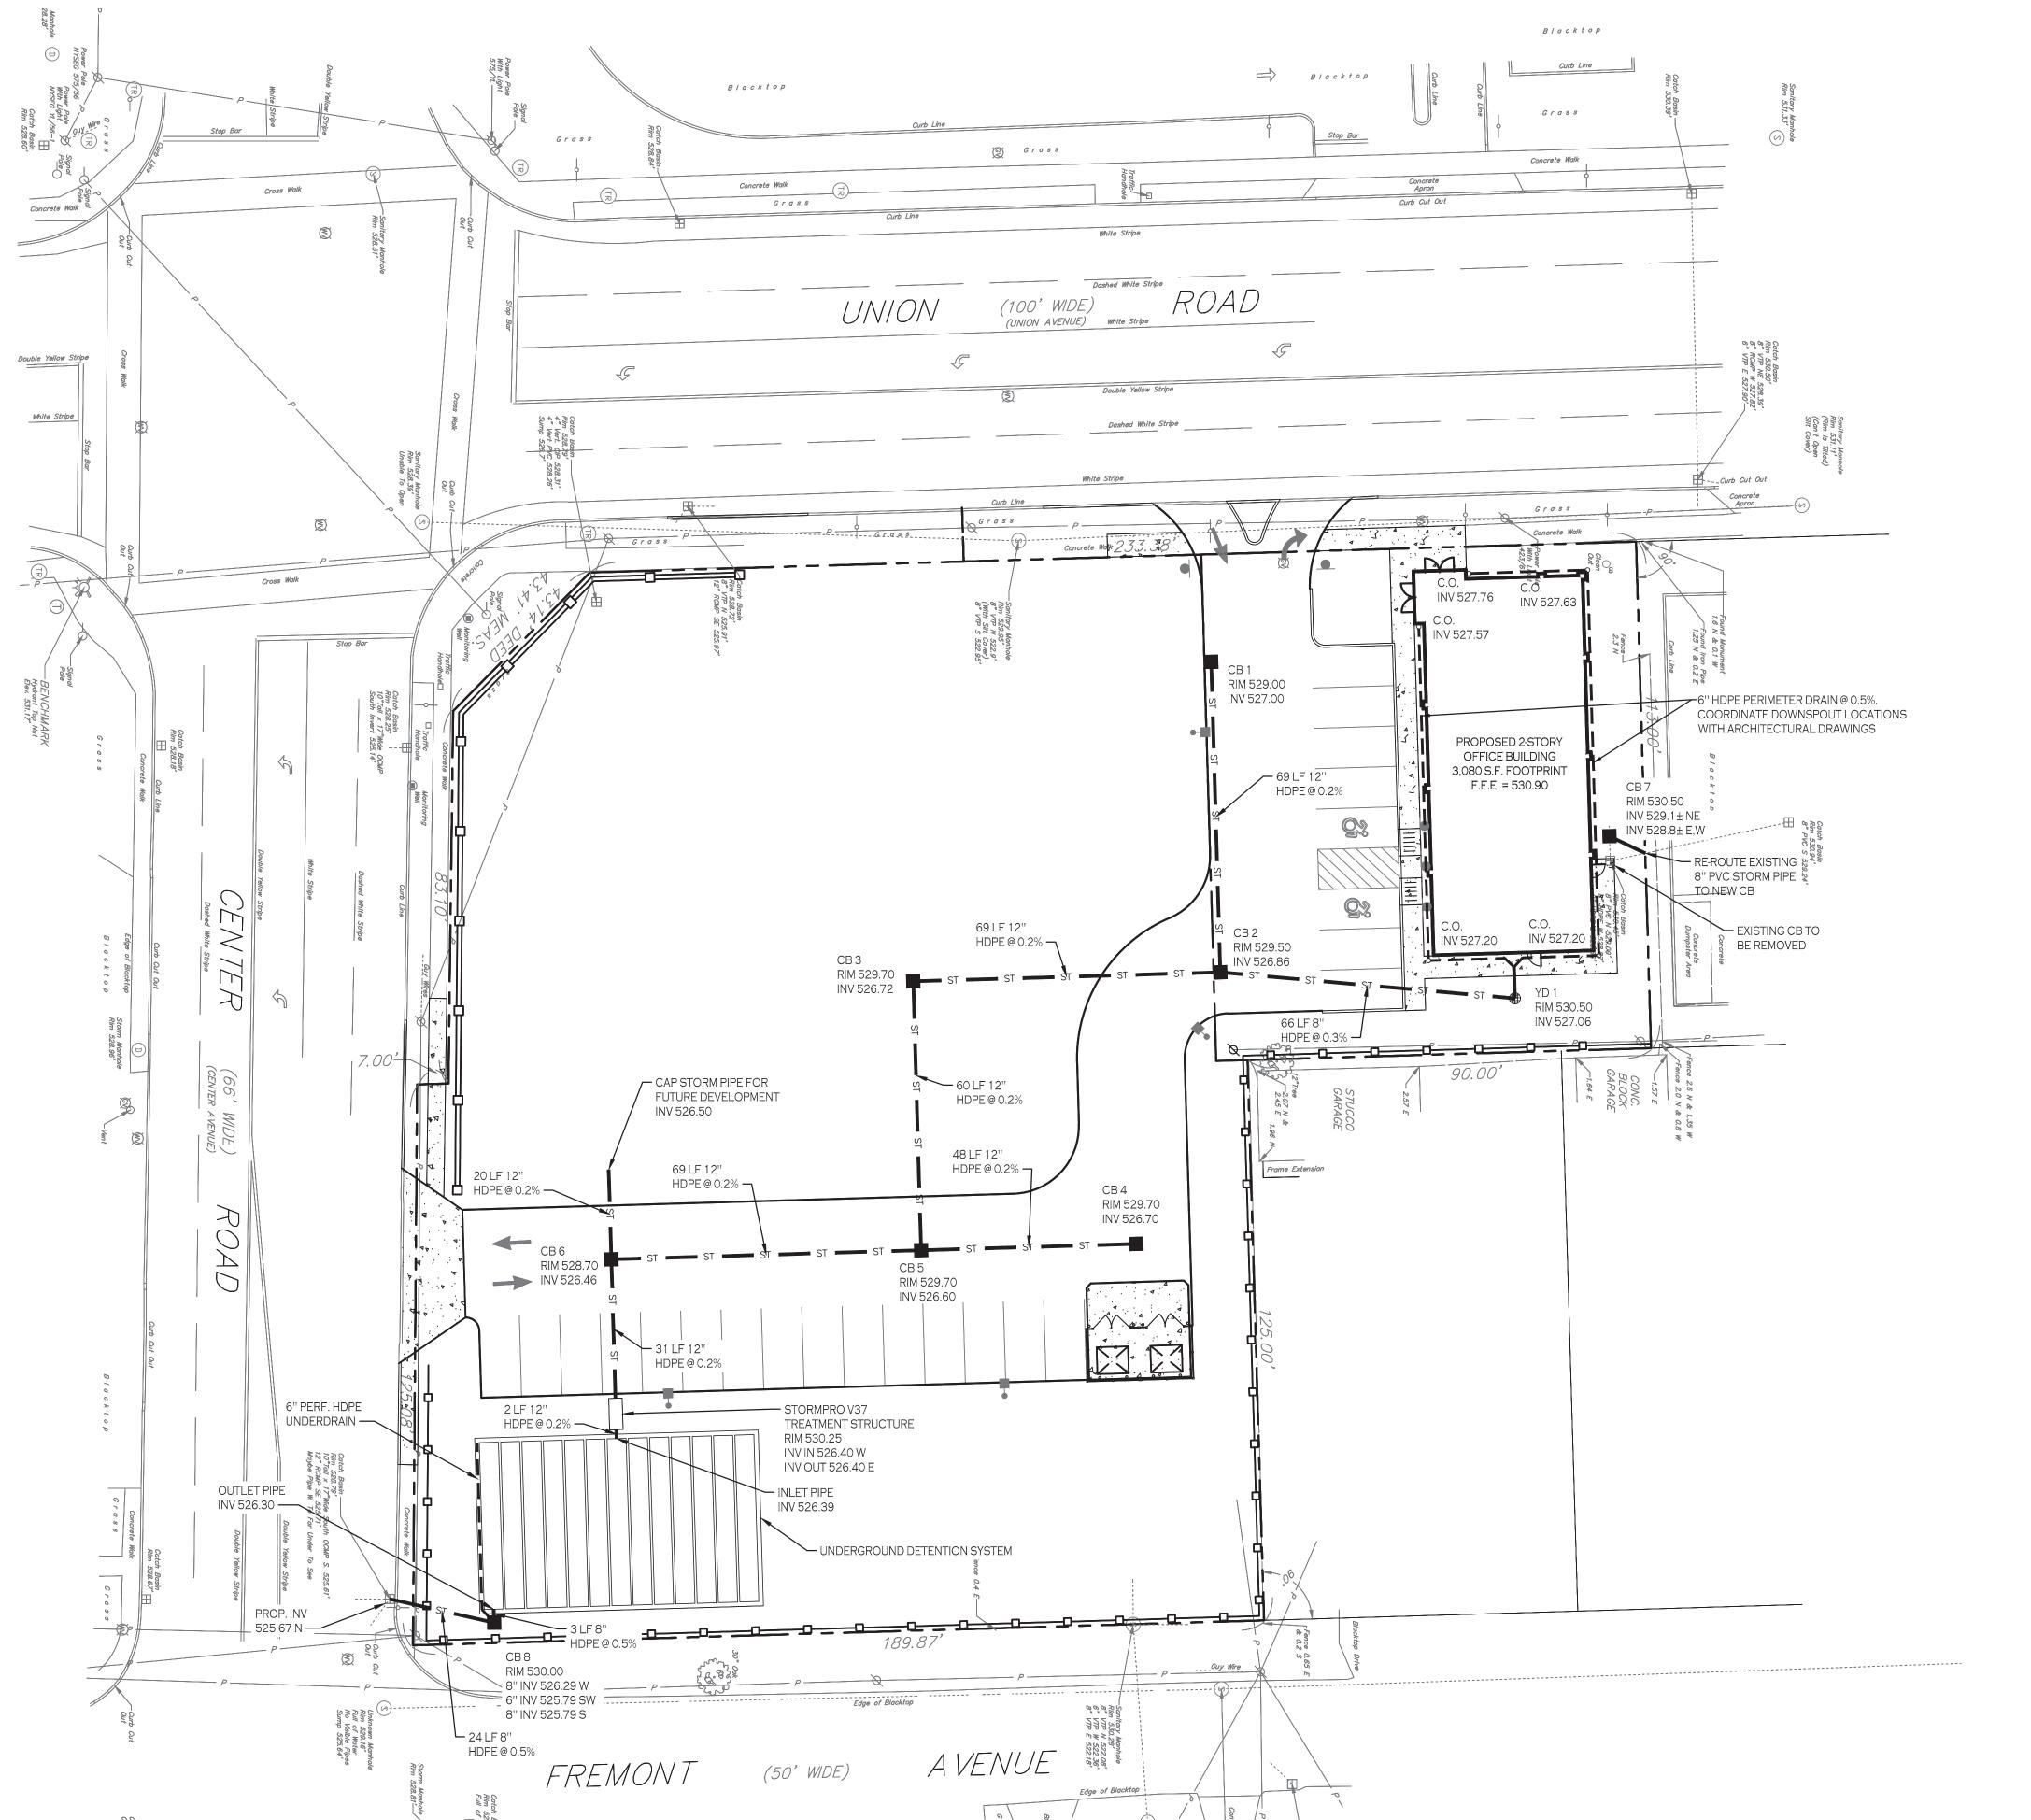

DRAINAGE PLAN

SCALE: 1"=20"

UNDERGROUND DETENTION SYSTEM:

ADS_STORMTECH SC-740 +CAP (ADS STORMTECH® SC-740 WITH CAP LENGTH)

51.0" WIDE + 6.0" SPACING = 57.0" C-C ROW SPACING

5 CHAMBERS/ROW x 7.12' LONG + 0.81' CAP LENGTH X 2 = 37.22' ROW LENGTH +12.0" END STONE x 2 = 39.22' BASE LENGTH

13 ROWS x 51.0" WIDE + 6.0" SPACING x 12 + 12.0" SIDE STONE x 2 = 63.25' BASE WIDTH

6.0" BASE + 30.0" CHAMBER HEIGHT + 6.0" COVER = 3.50' FIELD HEIGHT

65 CHAMBERS x 45.9 CF = 2,986.1 CF CHAMBER STORAGE

8,681.6 CF FIELD - 2,986.1 CF CHAMBERS = 5,695.5 CF STONE x 40.0% VOIDS = 2,278.2 CF STONE STORAGE

CHAMBER STORAGE + STONE STORAGE = 5,264.3 CF = 0.121 AF

OVERALL STORAGE EFFICIENCY = 60.6%

OVERALL SYSTEM SIZE = 39.22' x 63.25' x 3.50'

65 CHAMBERS 321.5 CY FIELD 210.9 CY STONE

UNDERGROUND DETENTION SUMMARY

(65) ADS STORMTECH SC-740 CHAMBERS
TOP OF STONE ELEV = 529.30
TOP OF CHAMBER ELEV = 528.80
BOTTOM OF CHAMBER ELEV = 526.30
BOTTOM OF STONE ELEV = 525.80
TOTAL STORAGE = 5,264 CF

STORMWATER DETENTION SUMMARY:

EVENT 1-YEAR 10-YEAR	EX. RUNOFF (CFS) 2.03 3.83	PROP. RUNOFF (CFS) 0.97 1.69	ELEVATION (FEET) 526.62 527.36	STORAGE (CF) 1,140 2,570
25-YEAR	4.81	2.05	527.84	3,423
100-YEAR	6.75	2.83	529.19	5,155

PROPOSED UTILITY LEGEND	
PROPOSED STORM SEWER	— ST —
PROPOSED SANITARY SEWER	— SA —
PROPOSED WATERLINE	— w —
PROPOSED CATCH BASIN	■ СВ
PROPOSED YARD DRAIN	● YD
PROPOSED MANHOLE	• MH
PROPOSED HYDRANT ASSEMBLY	
PROPOSED GATE VALVE	⊕ GV

NOTE: FOR PROPOSED VALVE BOXES, CLEANOUTS, ETC., INSTALL A 3,000 PSI CONCRETE COLLAR AROUND THE ITEM AT GRADE. THE COLLAR SHALL BE A MINIMUM OF 6" WIDER, ON ALL SIDES, THAN THE BOX, CLEANOUT, ETC. THE COLLAR SHALL BE A MINIMUM OF 6" THICK.

NOTE: BOUNDARY AND TOPOGRAPHIC INFORMATION PROVIDED BY OTHERS, CARMINA WOOD MORRIS, D.P.C. ASSUMES NO RESPONSIBILITY FOR ITS ACCURACY.



Carmina
Wood

Morris^D



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REVISIONS:
No. Description

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It Plans for:

Site Development Plans for Proposed Office

by:


8/24/21
A. Pandolfe
As Noted

Drawn by: A. P. Scale: As

Drainage Plan

DRAWING NO.

Project no.: 20.150

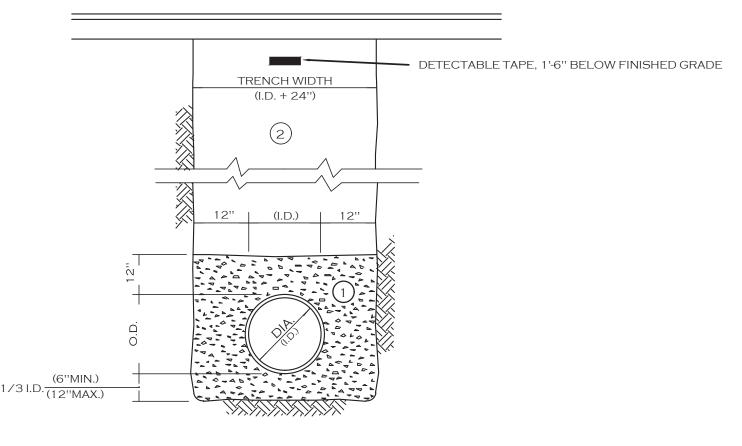

NOTES:

A. PIPE INSTALLATION SHALL BE IN ACCORDANCE WITH MANUFACTURERS RECOMMENDATIONS.

B. TRENCHING OPERATIONS SHALL INCLUDE ALL NECESSARY DEWATERING.

- C. TRENCH DETAILS ARE ONLY SHOWN FOR PURPOSES OF MATERIAL PLACEMENT AND MAXIMUM PAY LIMITS.
- D. AN OSHA APPROVED MOVABLE PROTECTIVE TRENCH SHIELD SHALL BE USED IN ALL UNSHEETED TRENCH AREAS.

<u>MATERIALS</u>

PIPE BEDDING MATERIAL (NYSDOT 1985 EDITION)


NO. 1 CRUSHED STONE OR CRUSHED GRAVEL WITH A GRADATION CONFORMING WITH NYSDOT SECTION 703-02. THE MATERIAL SHALL BE WELL GRADED WITH NO PARTICLES LARGER THAN ONE INCH AND HAVING A MAXIMUM GRADATION MEETING THE LIMITS DESCRIBED IN THE SPECIFICATIONS. THE BEDDING SHALL BE COMPACTED IN 6" LIFTS WITH EQUIPMENT ACCEPTABLE TO THE PIPE MANUFACTURER.

NO SLAG SHALL BE ALLOWED FOR MATERIAL (1)

TYPE 2 CRUSHED STONE OR CRUSHED GRAVEL WITH A GRADATION CONFORMING WITH NYSDOT SECTION 304-2.02 TYPE 2. THE MATERAIL SHALL BE WELL GRADED WITH NO PARTICLES LARGER THAN TWO INCHES AND HAVING A MAXIMUM GRADATION MEETING THE LIMITS DESCRIBED IN THE SPECIFICATIONS. THE BEDDING SHALL BE COMPACTED IN 6" LIFTS WITH EQUIPMENT ACCEPTABLE TO THE PIPE MANUFACTURER.

NO SLAG SHALL BE ALLOWED FOR MATERIAL (2)

STORM SEWER TRENCH SECTION **IN PAVED AREAS**

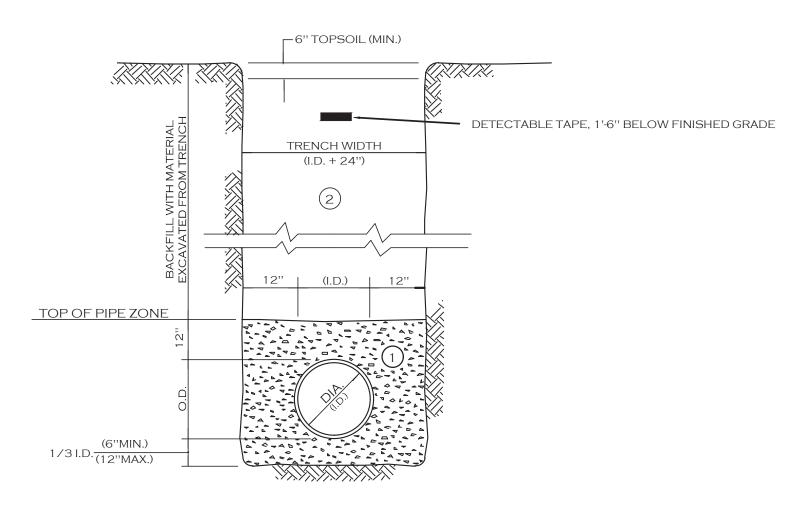

- A. PIPE INSTALLATION SHALL BE IN ACCORDANCE WITH MANUFACTURERS RECOMMENDATIONS.
- B. TRENCHING OPERATIONS SHALL INCLUDE ALL NECESSARY DEWATERING.
- C. TRENCH DETAILS ARE ONLY SHOWN FOR PURPOSES OF MATERIAL
- D. AN OSHA APPROVED MOVABLE PROTECTIVE TRENCH SHIELD SHALL BE USED IN ALL UNSHEETED TRENCH AREAS.

MATERIALS

PLACEMENT AND MAXIMUM PAY LIMITS.


PIPE BEDDING MATERIAL (NYSDOT 1985 EDITION)

NO. 1 CRUSHED STONE OR CRUSHED GRAVEL WITH A GRADATION CONFORMING WITH NYSDOT SECTION 703-02. THE MATERIAL SHALL BE WELL GRADED WITH NO PARTICLES LARGER THAN ONE INCH AND HAVING A MAXIMUM GRADATION MEETING THE LIMITS DESCRIBED IN THE SPECIFICATIONS. THE BEDDING SHALL BE COMPACTED IN 6" LIFTS WITH EQUIPMENT ACCEPTABLE TO THE PIPE MANUFACTURER.


NO SLAG SHALL BE ALLOWED FOR MATERIAL (1)


(2) BACKFILL MATERIAL SHALL BE NATIVE SOIL CONTAINING NO UNSUITABLE MATERIAL COMPACTED IN 6" LIFTS.

STORM SEWER TRENCH SECTION **IN UNPAVED AREAS**

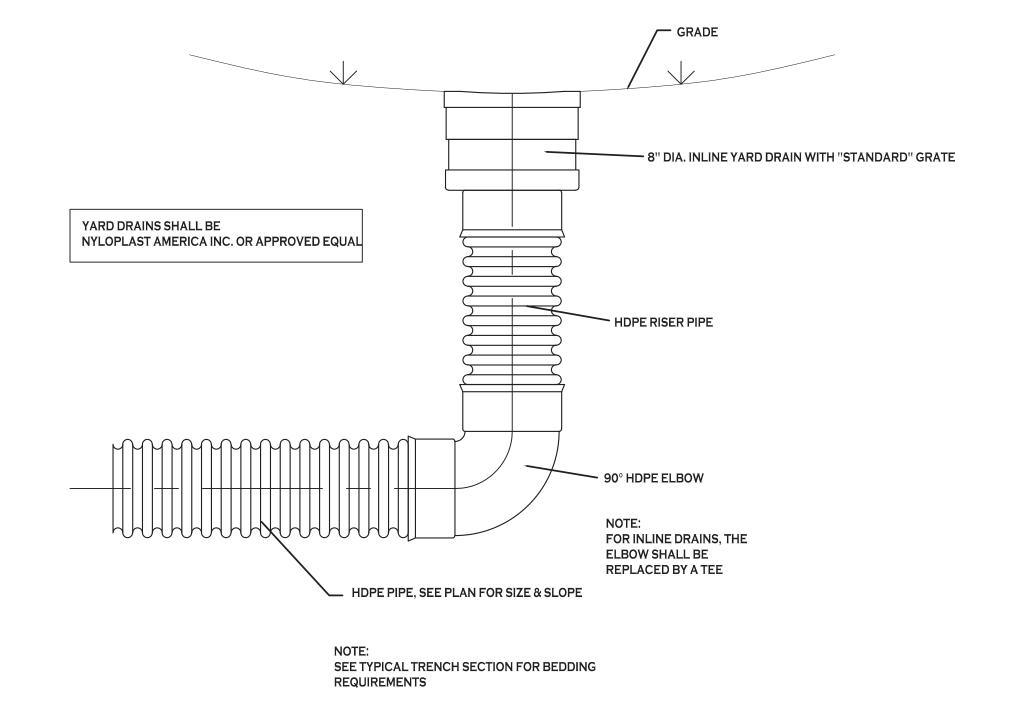


TYPICAL YARD DRAIN DETAIL

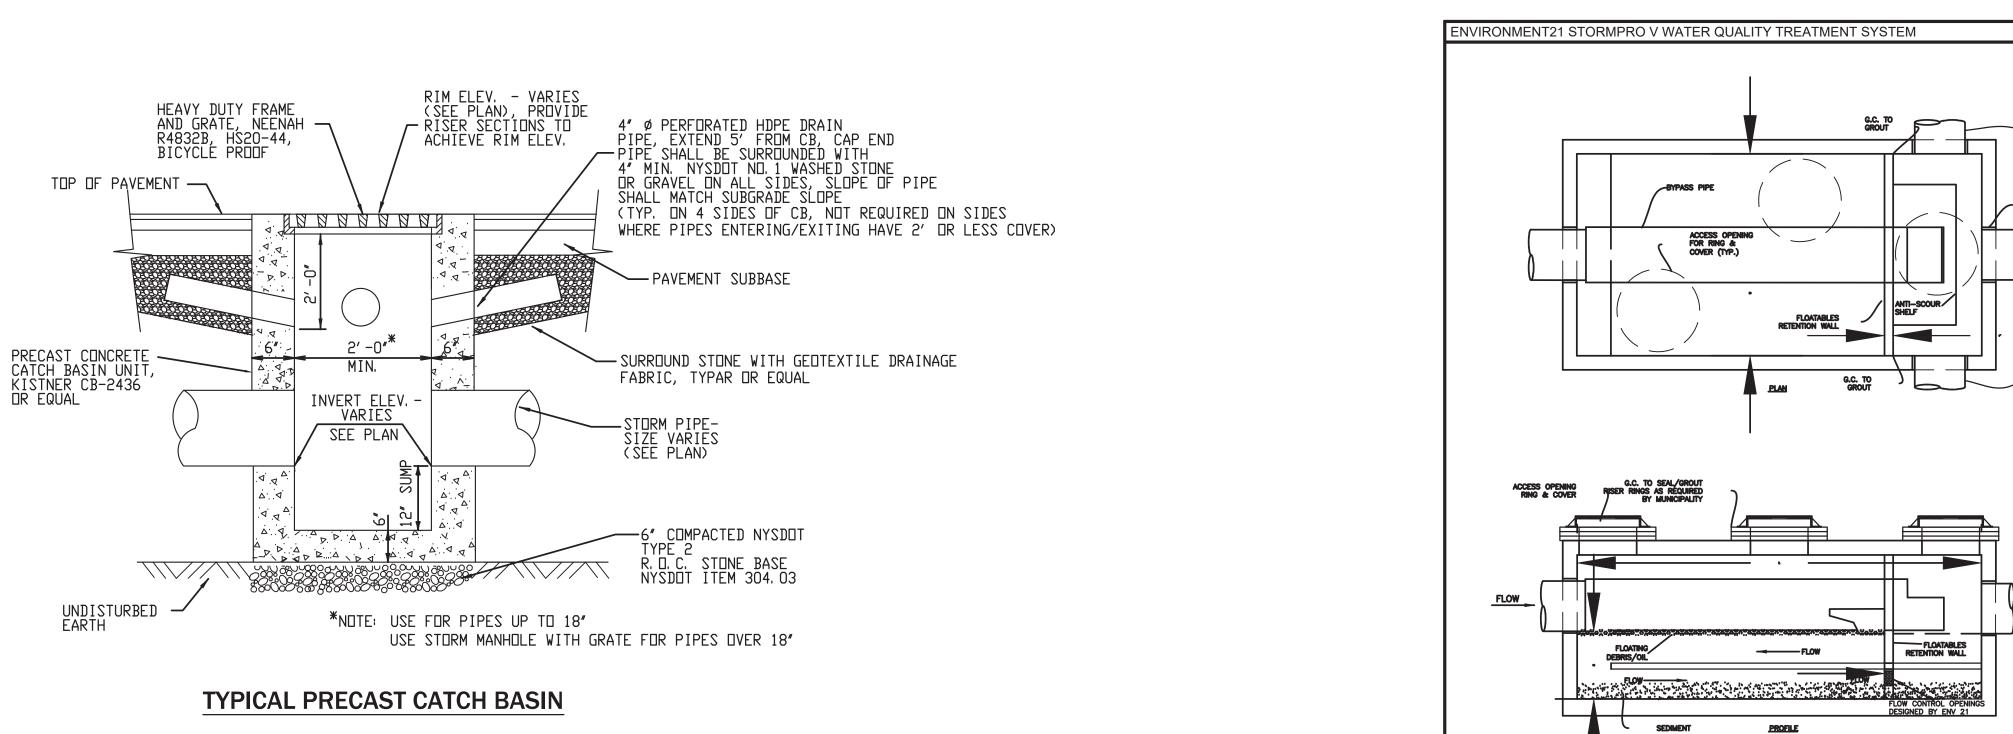

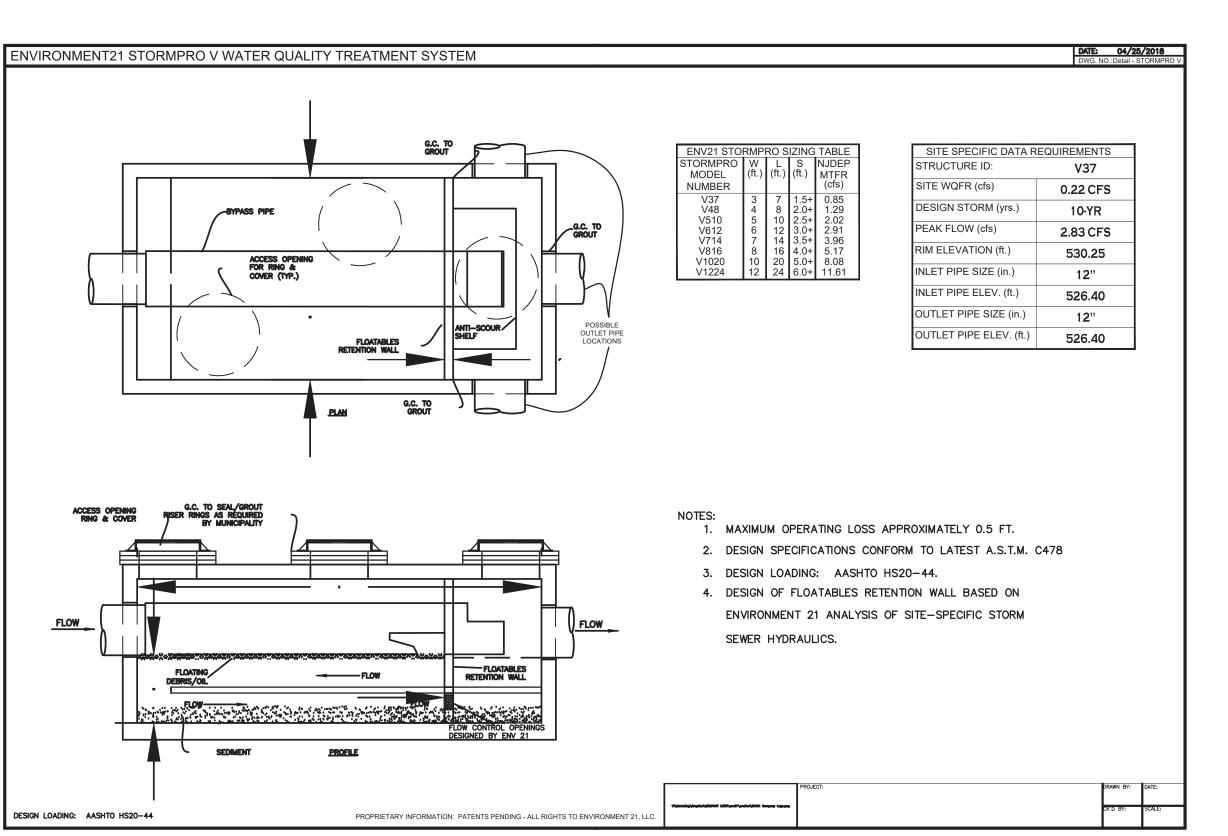



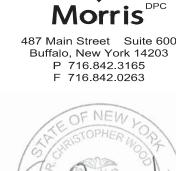



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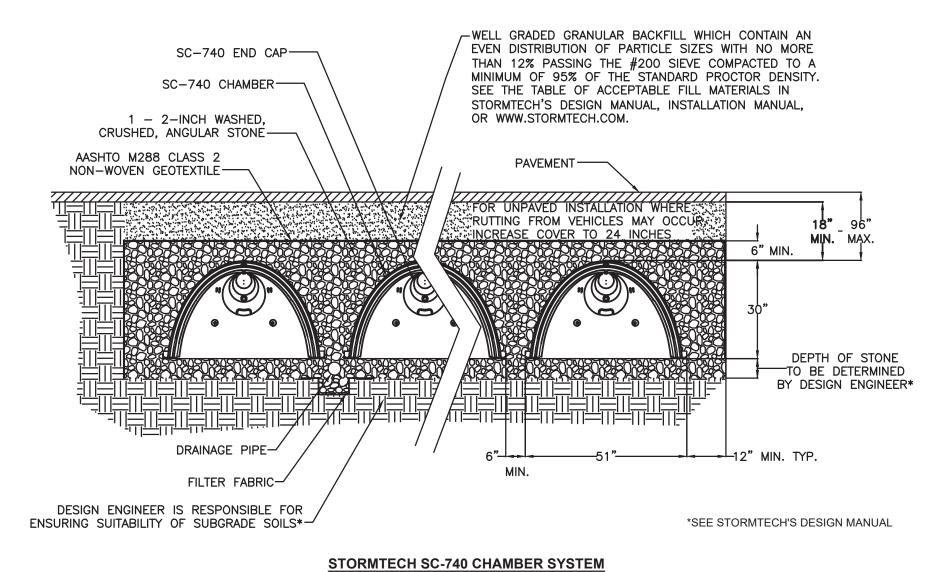
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8/24/21 Date:

Drawn by: A. Pandolfe Scale: As Noted DRAWING NAME:


Drainage Details

DRAWING NO.



TYPICAL CROSS SECTION W/ UNDERDRAIN DETAIL NOT TO SCALE


SC-740 TECHNICAL SPECIFICATION

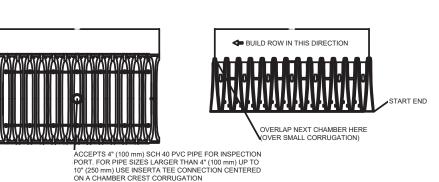









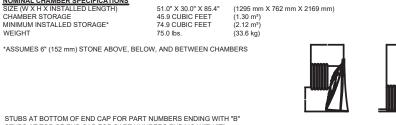


PART#	STUB	Α	В	С
SC740EPE06T / SC740EPE06TPC	6" (150 mm)	10.9" (277 mm)	18.5" (470 mm)	
C740EPE06B / SC740EPE06BPC	0 (130 mm)			0.5" (13 mm)
SC740EPE08T /SC740EPE08TPC	8" (200 mm)	12.2" (310 mm)	16.5" (419 mm)	
SC740EPE08B / SC740EPE08BPC	0 (200 111111)			0.6" (15 mm)
SC740EPE10T / SC740EPE10TPC	10" (250 mm)	13.4" (340 mm)	14.5" (368 mm)	
SC740EPE10B / SC740EPE10BPC	10 (230 11111)			0.7" (18 mm)
SC740EPE12T / SC740EPE12TPC	12" (300 mm)	14.7" (373 mm)	12.5" (318 mm)	
SC740EPE12B / SC740EPE12BPC	12 (300 11111)			1.2" (30 mm)
SC740EPE15T / SC740EPE15TPC	15" (375 mm)	18.4" (467 mm)	9.0" (229 mm)	
SC740EPE15B / SC740EPE15BPC	15 (57511111)			1.3" (33 mm)
SC740EPE18T / SC740EPE18TPC	18" (450 mm)	19.7" (500 mm)	5.0" (127 mm)	
SC740EPE18B / SC740EPE18BPC	16 (450 11111)			1.6" (41 mm)
SC740EPE24B*	24" (600 mm)	18.5" (470 mm)		0.1" (3 mm)

* FOR THE SC740EPE24B THE 24" (600 mm) STUB LIES BELOW THE BOTTOM OF THE END CAP APPROXIMATELY 1.75" (44 mm). BACKFILL MATERIAL SHOULD BE REMOVED FROM BELOW THE N-12 STUB SO THAT THE FITTING SITS LEVEL. NOTE: ALL DIMENSIONS ARE NOMINAL

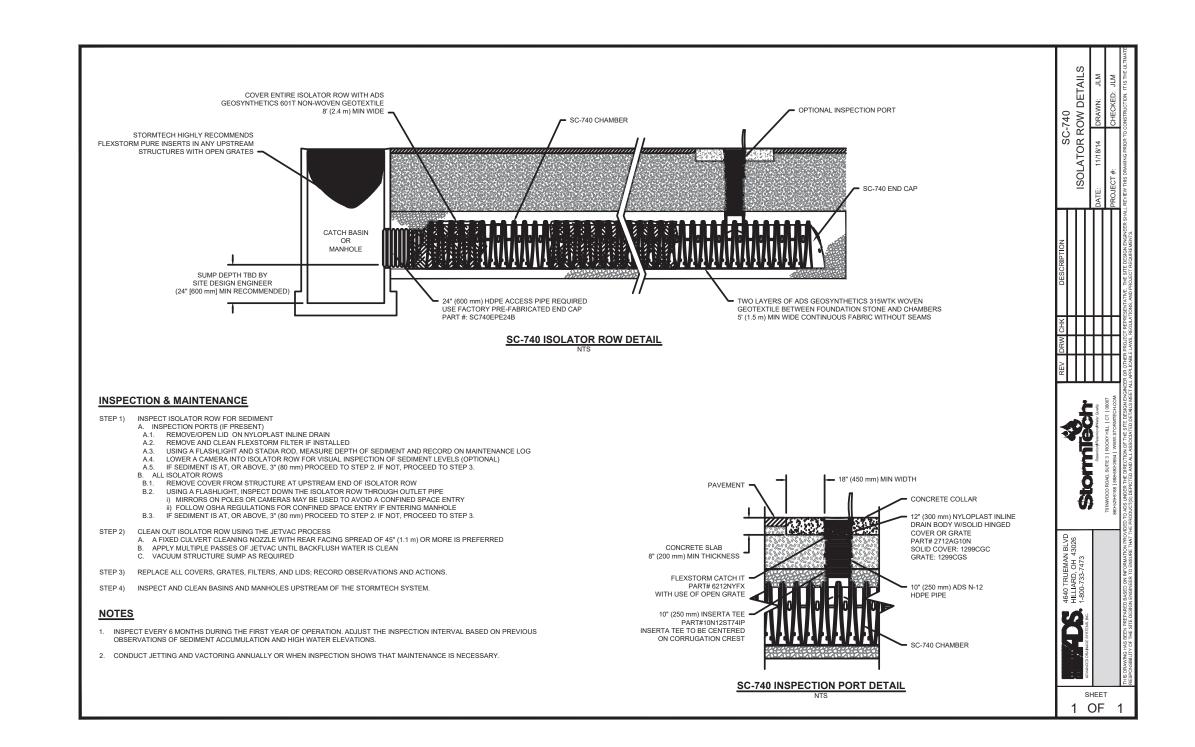

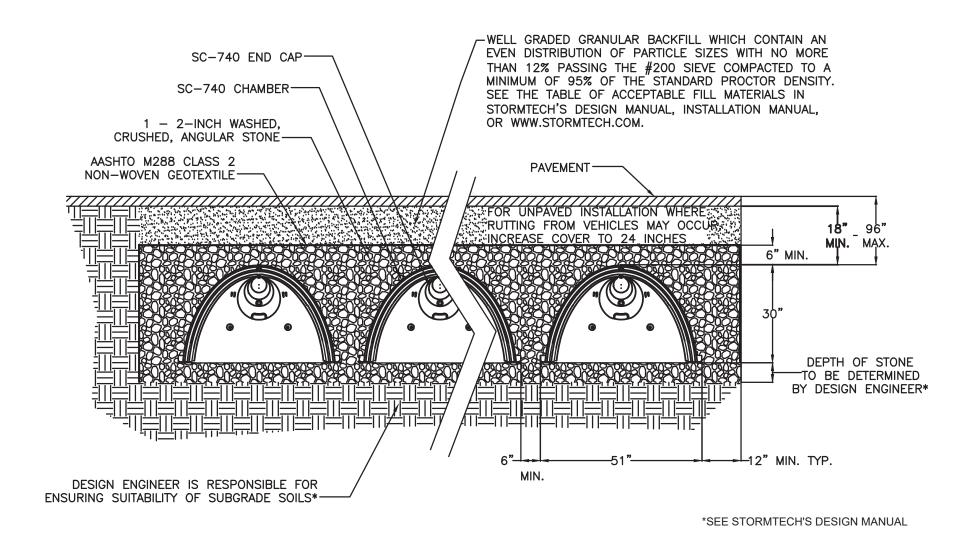

STORMTECH SC-740 CHAMBER SYSTEM TYPICAL CROSS SECTION DETAIL NOT TO SCALE

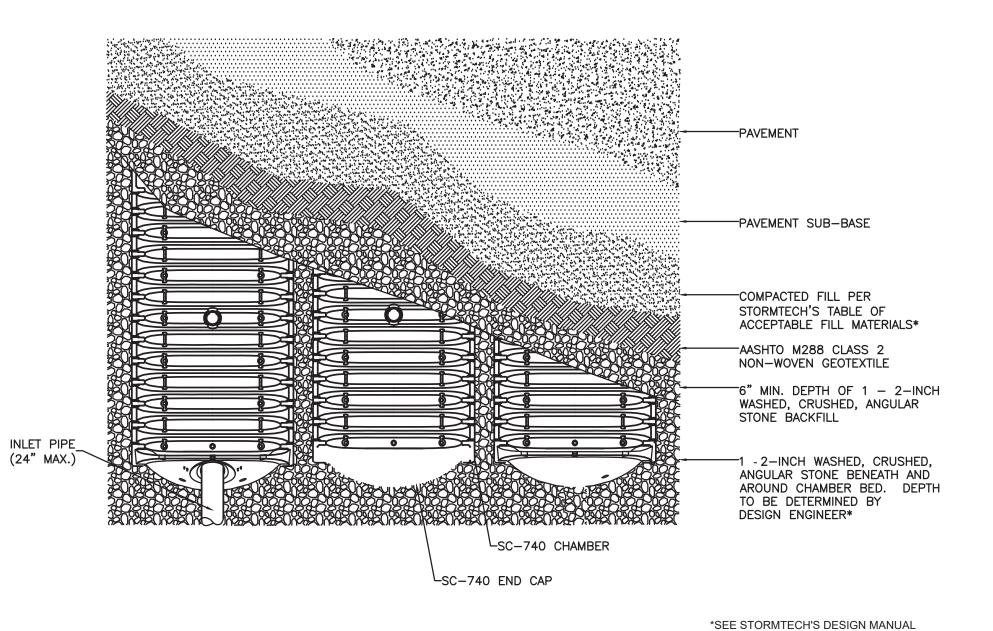

STORMTECH SC-740 CHAMBER SYSTEM PLAN VIEW DETAIL NOT TO SCALE

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Morris[®]

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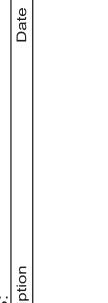
8/24/21 Drawn by: A. Pandolfe As Noted

DRAWING NAME: Underground **Detention Details**

DRAWING NO.

Date:

Scale:



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Morris

487 Main Street Suite 600 Buffalo, New York 14203 P 716.842.3165

F 716.842.0263

No. Descri

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Date:
Drawn by:

Drawn by:
Scale:


A. Pandolfe
As Noted

8/24/21

Utility Plan

DRAWING NO.

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- ALL SANITARY SEWER CONSTRUCTION SHALL CONFORM TO TOWN OF WEST SENECA SPECIFICATIONS AND DETAILS, AND ERIE COUNTY DEPARTMENT OF HEALTH RULES AND REGULATIONS.
- 2. PRIOR STARTING ANY WORK ASSOCIATED WITH OR NEAR EXISTING SANITARY MANHOLES, THE CONTRACTOR SHALL MEET WITH THE TOWN OF WEST SENECA SEWER DEPARTMENT TO DISCUSS AND AGREE TO THE WORK.
- 3. FILL SHALL BE PLACED AND SATISFACTORILY COMPACTED PRIOR TO INSTALLATION OF UTILITIES, AND MUST BE APPROVED BY THE SUPERVISING PROJECT ENGINEER. ANY EXCESS FILL OR SPOILS ARE TO BE HAULED OFF SITE BY SITE CONTRACTOR.
- 4. ALL SANITARY SEWER CONSTRUCTION IS TO CONFORM TO ERIE COUNTY DEPARTMENT OF HEALTH RULES AND REGULATIONS.
- 5. ALL OTHER REQUIRED PERMITS BY THE STATE OF NEW YORK, COUNTY OF ERIE AND TOWN OF WEST SENECA ARE THE RESPONSIBILITY OF THE CONTRACTOR/DEVELOPER.
- 1. FOR ALL SANITARY SEWERS, INSTALL SELECT FILL IN PAVED AREAS, EXTEND 5' MIN. BEYOND PAVEMENT LIMITS
- 2. BUILDINGS TO HAVE A 6" HOUSE TRAP, VENT AND CLEANOUT INSTALLED AT ENTRANCE POINT. INVERT ELEVATION TO BE 5' MIN. BELOW F.F.E. OF THE BUILDING. PIPE TO BE 6" SDR-35 PVC @ 1.0% MIN WITH MIN 4' OF COVER. ADD ADDITIONAL CLEANOUTS @ 100' MAX. SPACING FOR 6" LATERALS OVER 90' IN LENGTH.
- 3. COORDINATE GAS & ELEC. METER BANK LOCATIONS ON BUILDINGS WITH M.E.P. PLANS & UTILITY CO.'S.
- 4. COORDINATE LOCATION OF CTV & TELEPHONE SERVICE TO BUILDINGS WITH M.E.P. PLANS AND UTILITY CO.'S.
- 5. ANY EXISTING UTILITIES WHICH ARE TO BE ABANDONED AND FALL UNDER PAVEMENT OR BUILDINGS SHALL BE REMOVED VS. BEING ABANDONED UNLESS THOSE UTILITIES ARE FILLED WITH FLOWABLE FILL.
- 6. EXISTING GAS SERVICES TO REMAIN UNLESS OTHERWISE NOTED. ANY PORTIONS TO BE RELOCATED SHALL BE COORDINATED WITH NATIONAL FUEL GAS.
- 7. ALL UNDERGROUND TELEPHONE SERVICES SHALL REMAIN AND BE PROTECTED DURING CONSTRUCTION.
- 8. A MINIMUM OF 10 FEET HORIZONTAL AND 18 INCHES OF VERTICAL SEPARATION MUST BE MAINTAINED BETWEEN ALL SANITARY SEWER AND WATER SERVICES.
- 9. ERIE COUNTY WATER AUTHORITY (ECWA) IS TO BE NOTIFIED A MINIMUM OF 48-HOURS PRIOR TO STARTING THE CONNECTION TO THE NEW WATER SERVICE.
- CONNECTION TO THE NEW WATER SERVICE.
- 10. SELECT BACKFILL IS REQUIRED FOR ALL UTILITIES (GAS, WATER, STORM, SANITARY) THAT CROSS THROUGH PAVEMENT AREAS.
- 11. ALL CONDUITS ARE TO BE SUPPLIED AND INSTALLED BY SITE CONTRACTOR AND TO BE ENCASED IN STONE

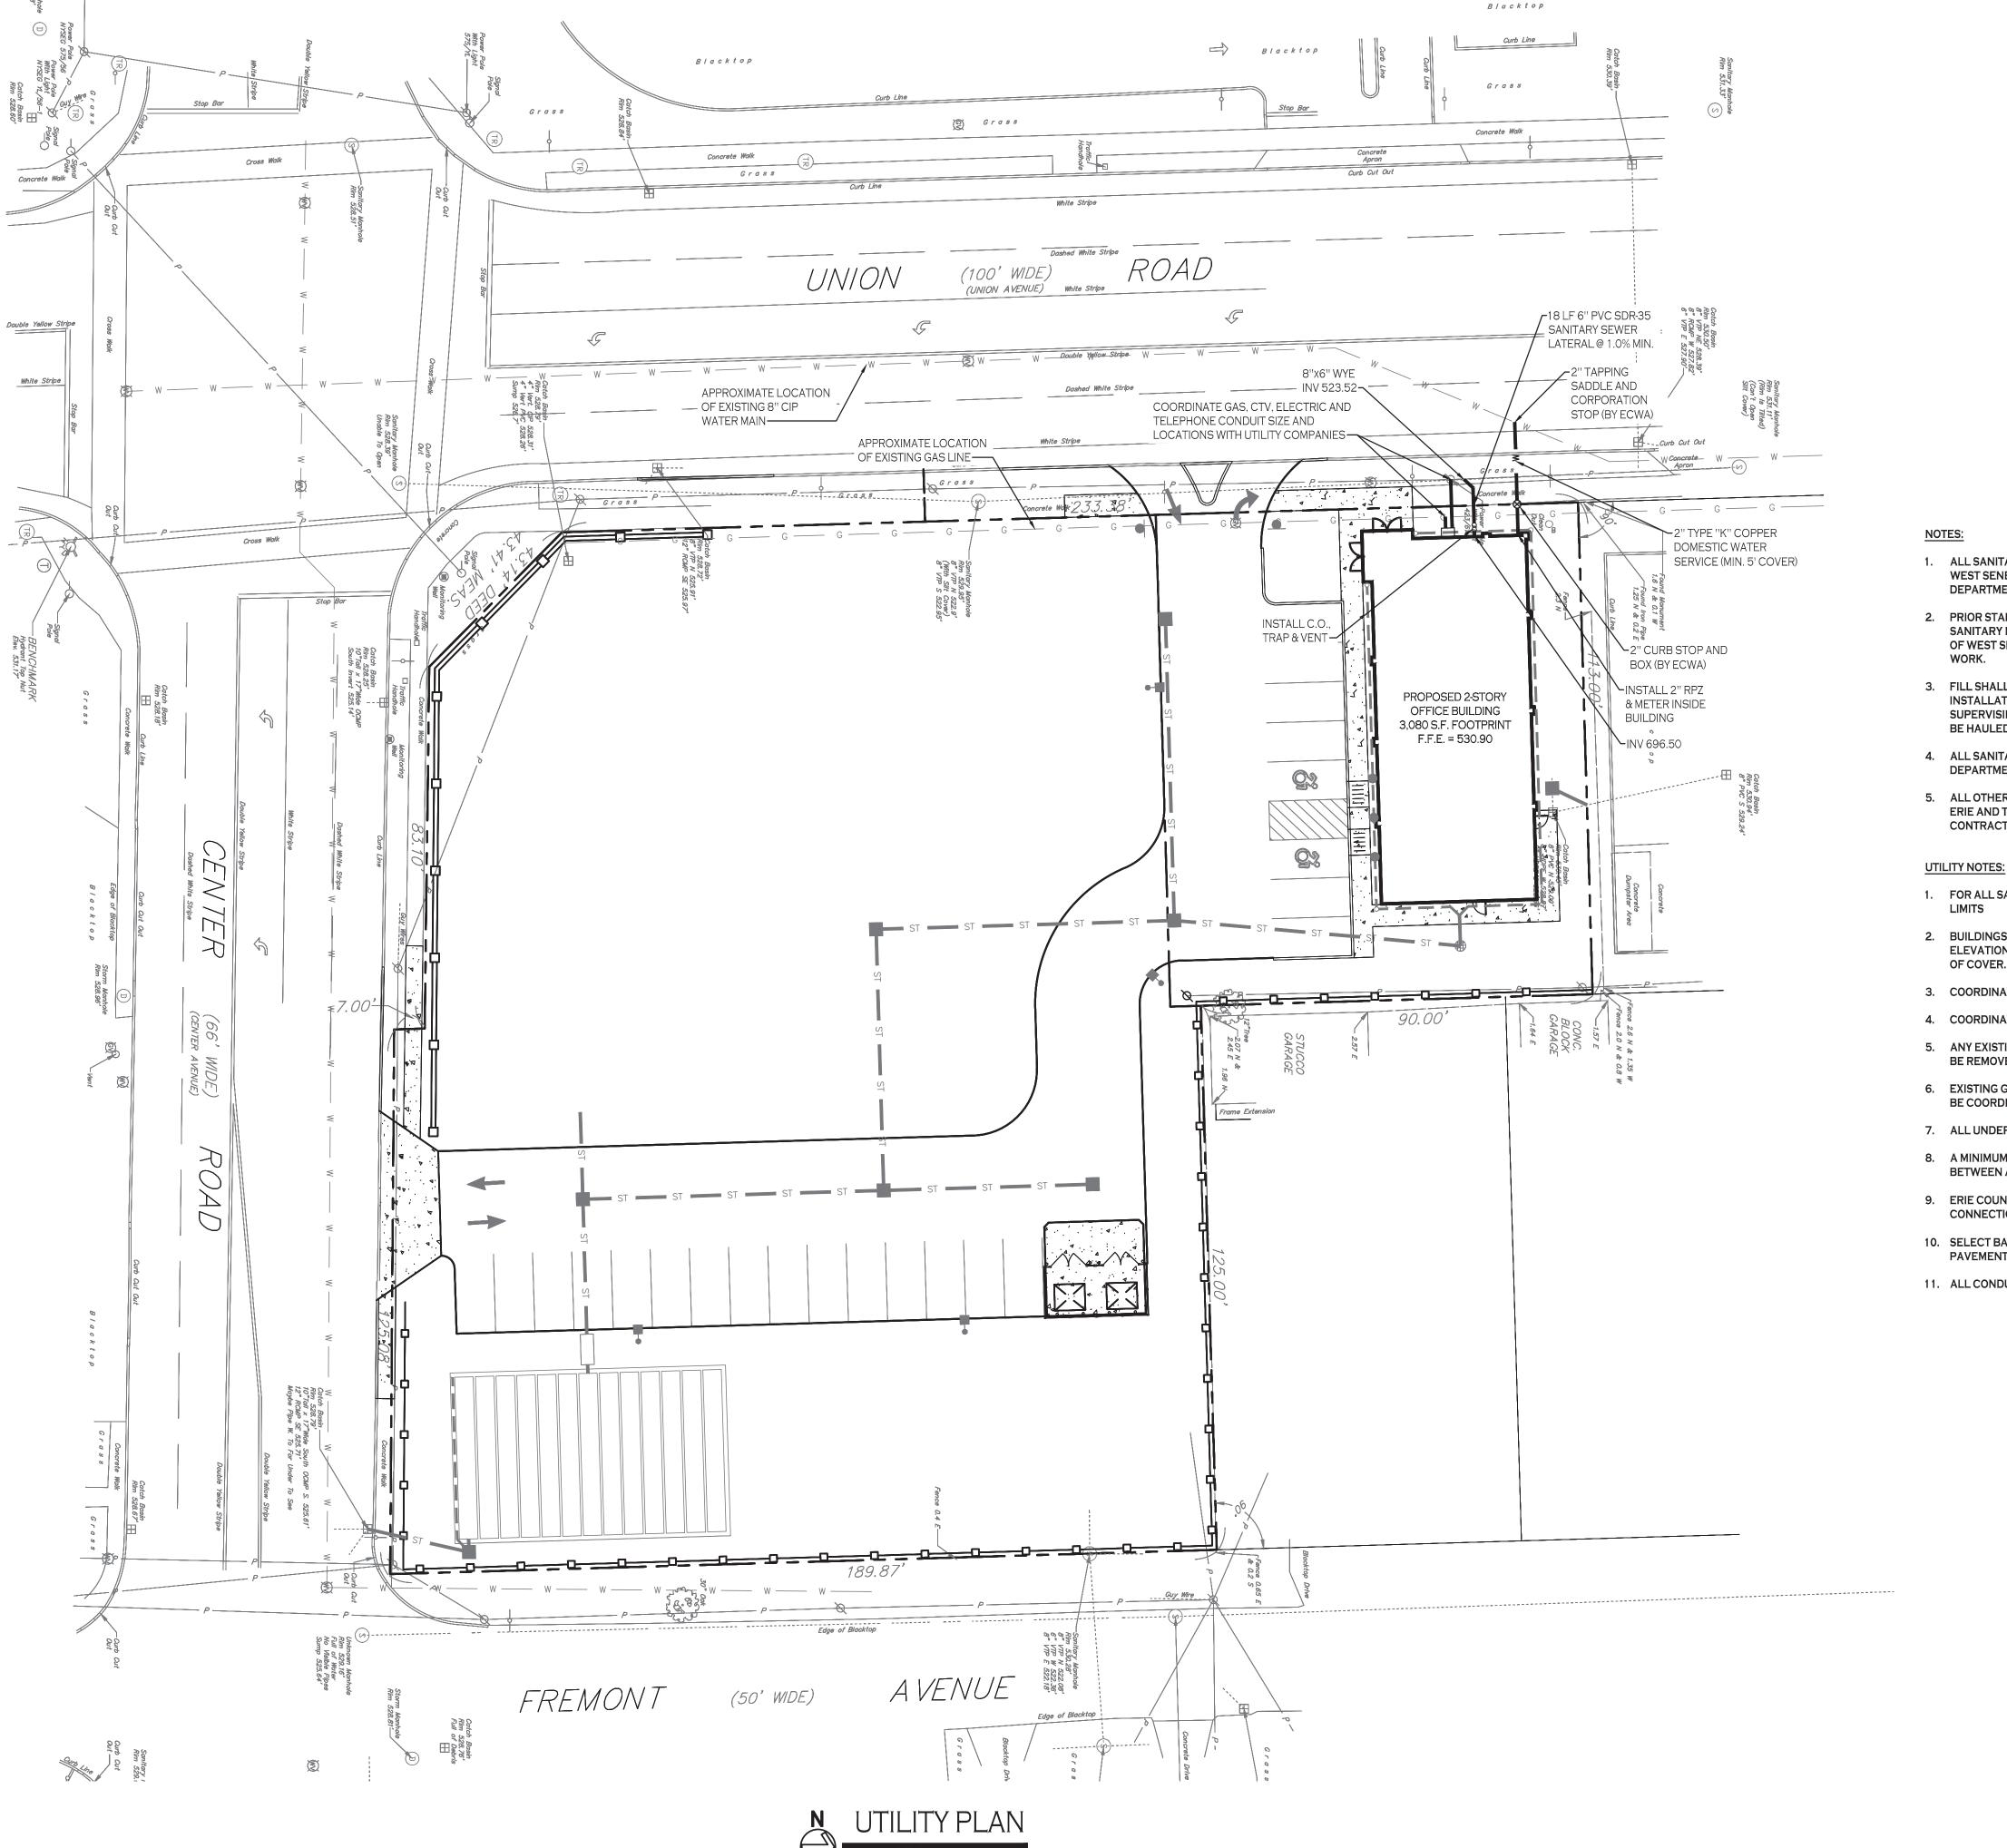PROPOSED STORM SEWER — ST —

PROPOSED SANITARY SEWER — SA —

PROPOSED WATERLINE — W —

PROPOSED CATCH BASIN ■ CB

PROPOSED YARD DRAIN ● YD

PROPOSED MANHOLE • MH


PROPOSED HYDRANT ASSEMBLY

PROPOSED GATE VALVE

PROPOSED UTILITY LEGEND

NOTE: FOR PROPOSED VALVE BOXES, CLEANOUTS, ETC., INSTALL A 3,000 PSI CONCRETE COLLAR AROUND THE ITEM AT GRADE. THE COLLAR SHALL BE A MINIMUM OF 6" WIDER, ON ALL SIDES, THAN THE BOX, CLEANOUT, ETC. THE COLLAR SHALL BE A MINIMUM OF 6" THICK.

NOTE: BOUNDARY AND TOPOGRAPHIC INFORMATION PROVIDED BY OTHERS, CARMINA WOOD MORRIS, D.P.C. ASSUMES NO RESPONSIBILITY FOR ITS ACCURACY.

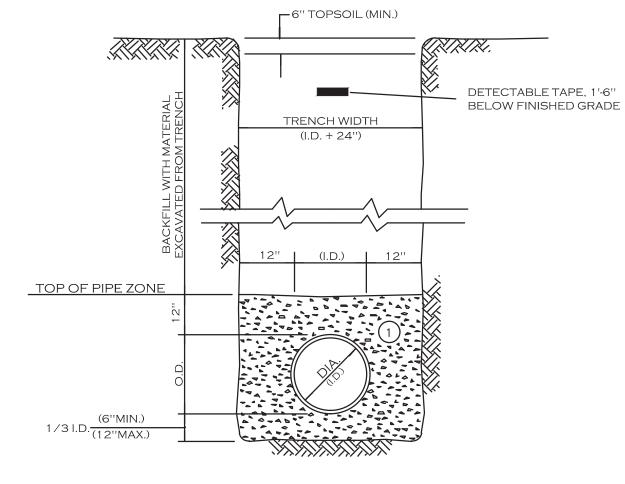


- A. PIPE INSTALLATION SHALL BE IN ACCORDANCE WITH MANUFACTURERS RECOMMENDATIONS.
- B. TRENCHING OPERATIONS SHALL INCLUDE ALL NECESSARY DEWATERING.
- C. TRENCH DETAILS ARE ONLY SHOWN FOR PURPOSES OF MATERIAL
- D. AN OSHA APPROVED MOVABLE PROTECTIVE TRENCH SHIELD SHALL BE USED IN ALL UNSHEETED TRENCH AREAS.

MATERIALS

PLACEMENT AND MAXIMUM PAY LIMITS.

- PIPE BEDDING MATERIAL (NYSDOT LATEST EDITION) 1) NO.1 CRUSHED STONE WITH A GRADATION CONFORMING WITH NYSDOT SECTION 703-02. THE CRUSHED STONE SHALL BE WELL GRADED WITH NO PARTICLES LARGER THAN 1" AND HAVING A MAXIMUM GRADATION MEETING THE LIMITS DESCRIBED IN THE SPECIFICATIONS. THE BEDDING SHALL BE COMPACTED IN 6" LIFTS WITH EQUIPMENT ACCEPTABLE TO THE PIPE MANUFACTURER.
- SELECT MATERIAL BACKFILL (NYSDOT LATEST EDITION) NO.2 RUN OF CRUSHER STONE OR NO.2 RUN OF CRUSHER GRAVEL WITH A GRADATION CONFORMING WITH NYSDOT SECTION 304-2.02 TYPE 4 AND NYSDOT SECTION 703-02. (COMPACTED IN 6"LIFTS TO 90% NOTE: SLAG SHALL NOT BE ALLOWED FOR MATERIALS (1) AND (2)

UTILITY TRENCH SECTION IN UNPAVED AREAS

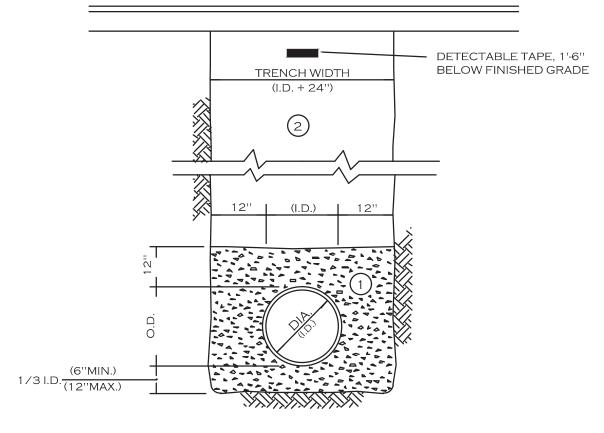



- A. PIPE INSTALLATION SHALL BE IN ACCORDANCE WITH MANUFACTURERS
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- C. TRENCH DETAILS ARE ONLY SHOWN FOR PURPOSES OF MATERIAL PLACEMENT AND MAXIMUM PAY LIMITS.
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MATERIALS


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 - SELECT MATERIAL BACKFILL (NYSDOT LATEST EDITION)
- NO.2 RUN OF CRUSHER STONE OR NO.2 RUN OF CRUSHER GRAVEL WITH A GRADATION CONFORMING WITH NYSDOT SECTION 304-2.02 TYPE 4 AND NYSDOT SECTION 703-02. (COMPACTED IN 6"LIFTS TO 90% NOTE: SLAG SHALL NOT BE ALLOWED FOR MATERIALS (1) AND (2)


UTILITY TRENCH SECTION IN PAVED AREAS



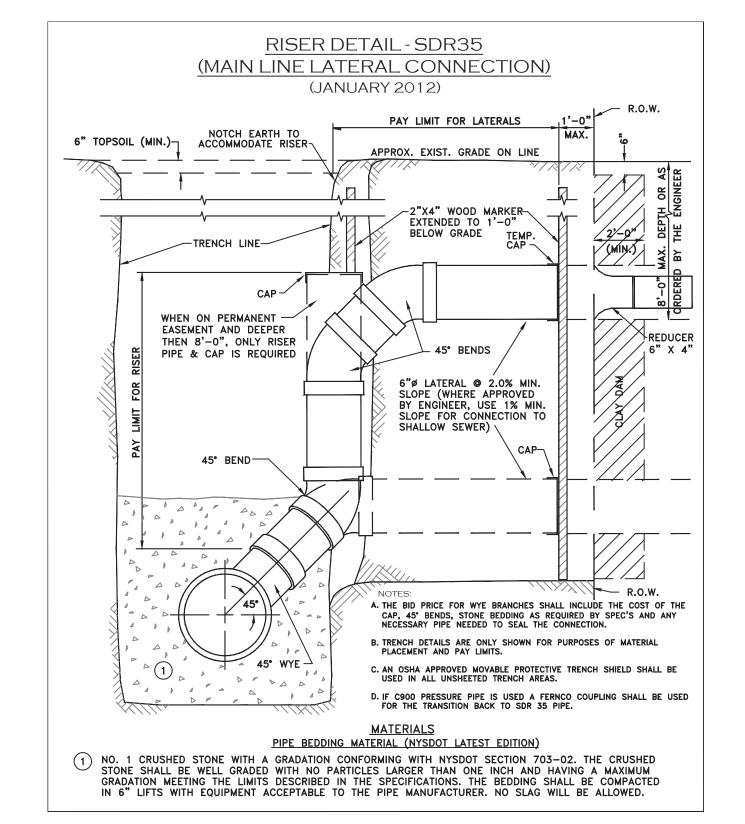


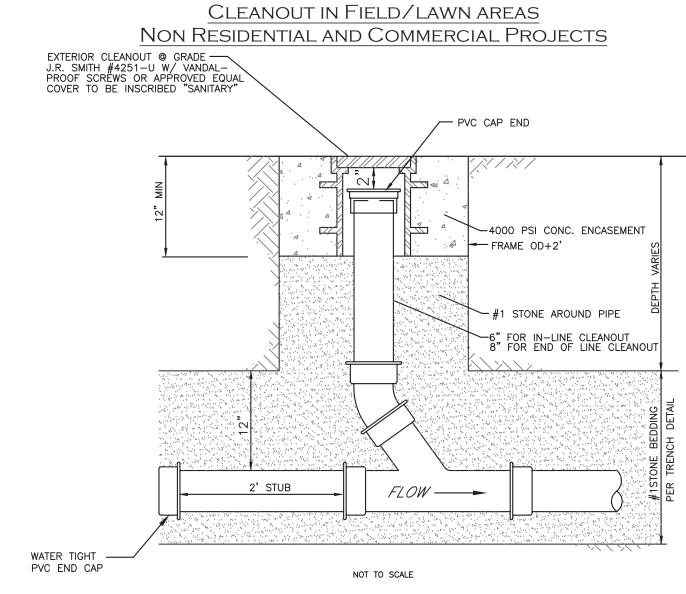

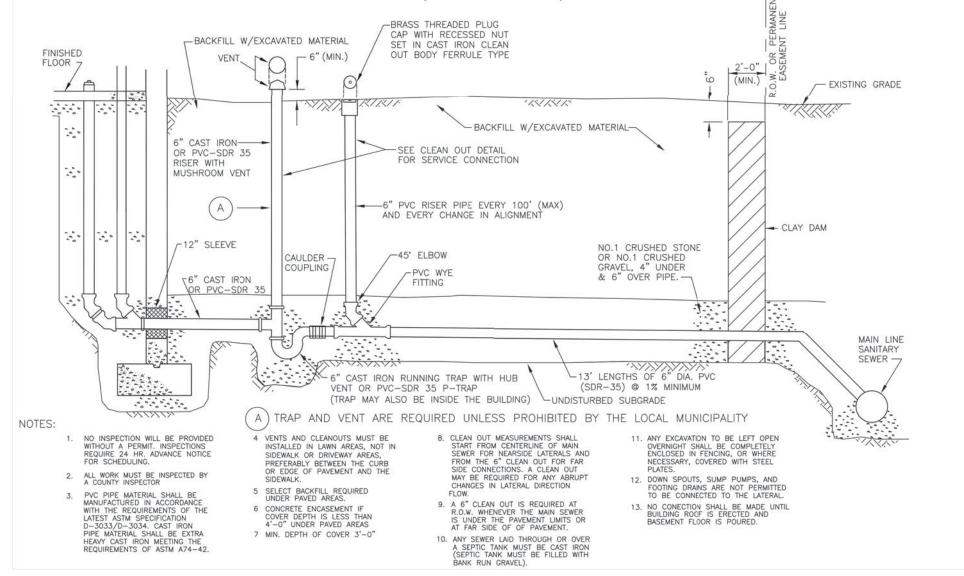

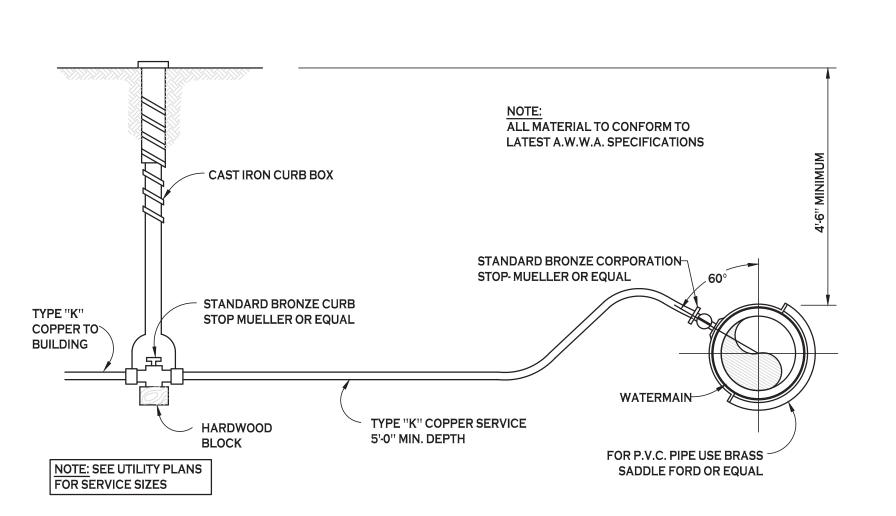

TYPICAL WATER SERVICE LINE INSTALLATION NOT TO SCALE

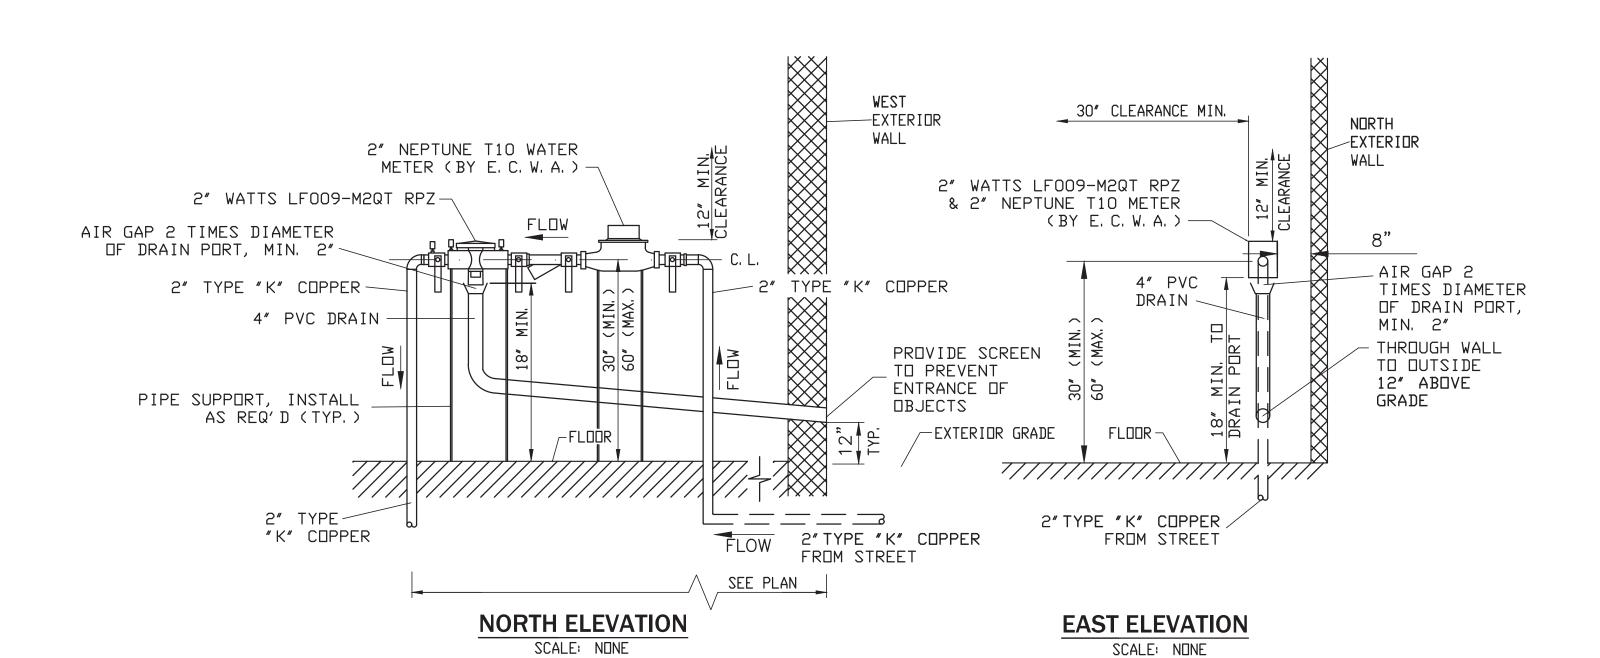

2" DOMESTIC SERVICE BACKFLOW PREVENTER INSTALLATION

SCALE: NONE

1. NO TAPS TO BE MADE UPSTREAM OF RPZ & METER. HEAT, LIGHT AND ELECTRIC TO BE PROVIDED AT RPZ LOCATION. 3. COORDINATE LOCATION WITH ARCHITECTURAL PLANS.



Wood **Morris** 487 Main Street Suite 600 Buffalo, New York 14203 P 716.842.3165

F 716.842.0263



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Developr

Date: Drawn by: A. Pandolfe

8/24/21


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Utility Details


DRAWING NO.

Project no.: 20.150

LANDSCAPE PLAN

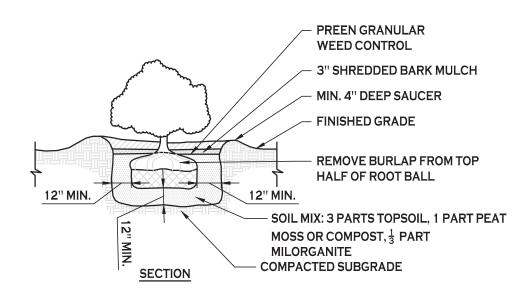

SHRUB PLANTING DETAIL NOT TO SCALE

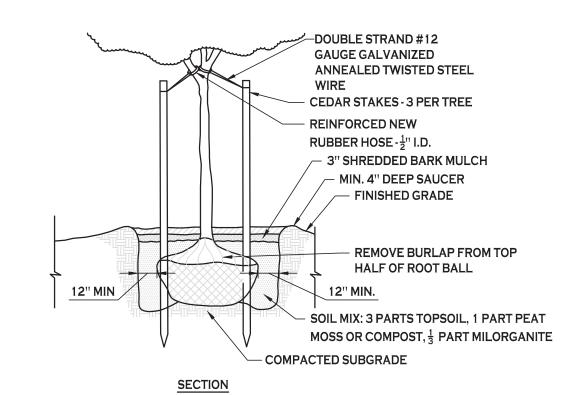

TREE PLANTING DETAIL NOT TO SCALE

PLANTING SCHEDULE

KEY	QTY.	BOTANICAL NAME	COMMON NAME	MIN. SIZE	REMARKS
		DECIDUOUS TREES			
GT	2	GLEDITSIA TRIACANTHOS	SHADEMASTER LOCUST	2.5" CAL.	
AxF	3	ACER x FREEMANII 'AUTUMN BLAZE'	AUTUMN BLAZE MAPLE	2.5" CAL.	
		EVERGREEN TREES			
PP	15	PICEA PUNGENS 'GLAUCA'	COLORADO BLUE SPRUCE	6' - 7' HT.	
		SHRUBS			
вх	11	BUXUS 'GREEN MOUND'	GREEN MOUND BOXWOOD	NO. 3 CONT.	2 ¹ O.C.
FxI	3	FORSYTHIA x INTERMEDIA 'KOLGOLD'	MAGICAL GOLD FORSYTHIA	NO. 5 CONT. (24" HT. MIN.)	3-4' O.C.
	•				
		ORNAMENTAL GRASSES / PERRENIALS			
CxA	11	CALAMAGROSTIS x ACUTIFLORA 'KARL FOERSTER'	KARL FOERSTER FEATHER REED GRASS	NO. 3 CONT.	3-4' O.C.

PLANTING NOTES:

- 1. ALL INTERIOR LANDSCAPED AREAS SHALL HAVE A MINIMUM PLANTING SOIL DEPTH OF TWO (2) FEET AND BE FREE FROM ALL FORMS OF CONSTRUCTION DEBRIS AND FOREIGN MATERIAL.
- 2. ALL TREE PIT SAUCERS, SHRUB BEDS, ORNAMENTAL GRASS BEDS, AND PERENNIAL FLOWER BEDS SHALL RECEIVE THREE (3) INCHES DEPTH OF DARK SHREDDED HARDWOOD BARK MULCH.
- 3. ALL SEASONAL FLOWER BEDS SHALL BE A MINIMUM OF SIXTEEN (16) INCHES
- DEEP. SOIL TO BE INSTALLED BY SITE CONTRACTOR.
- 4. ALL DECIDUOUS AND EVERGREEN TREES SHALL BE STAKED WITH THREE (3) TREE STAKES AS PER TREE PLANTING DETAIL.
- 5. ALL DISTURBED UNSURFACED AREAS WITHIN THE NYSDOT ROW MUST BE RESTORED USING ITEM 610.1401 TOPSOIL - REUSE ON-SITE MATERIALS OR ITEM 610.1402 TOPSOIL - ROADSIDE AND ITEM 610.1602 TURF ESTABLISHMENT · LAWNS AND COMPLY WITH NYSDOT STANDARD SPECIFICATION SECTION 713 - LANDSCAPE DEVELOPMENT MATERIALS. ALSO REFER TO NYSDOT STANDARD SPECIFICATION SECTION 610 - GROUND VEGETATION - PREPARATION, ESTABLISHMENT AND MANAGEMENT.

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Wood




Morris


8/24/21 A. Pandolfe As Noted Drawn by:

DRAWING NAME: Landscape Plan

DRAWING NO.

Project no.: 20.150

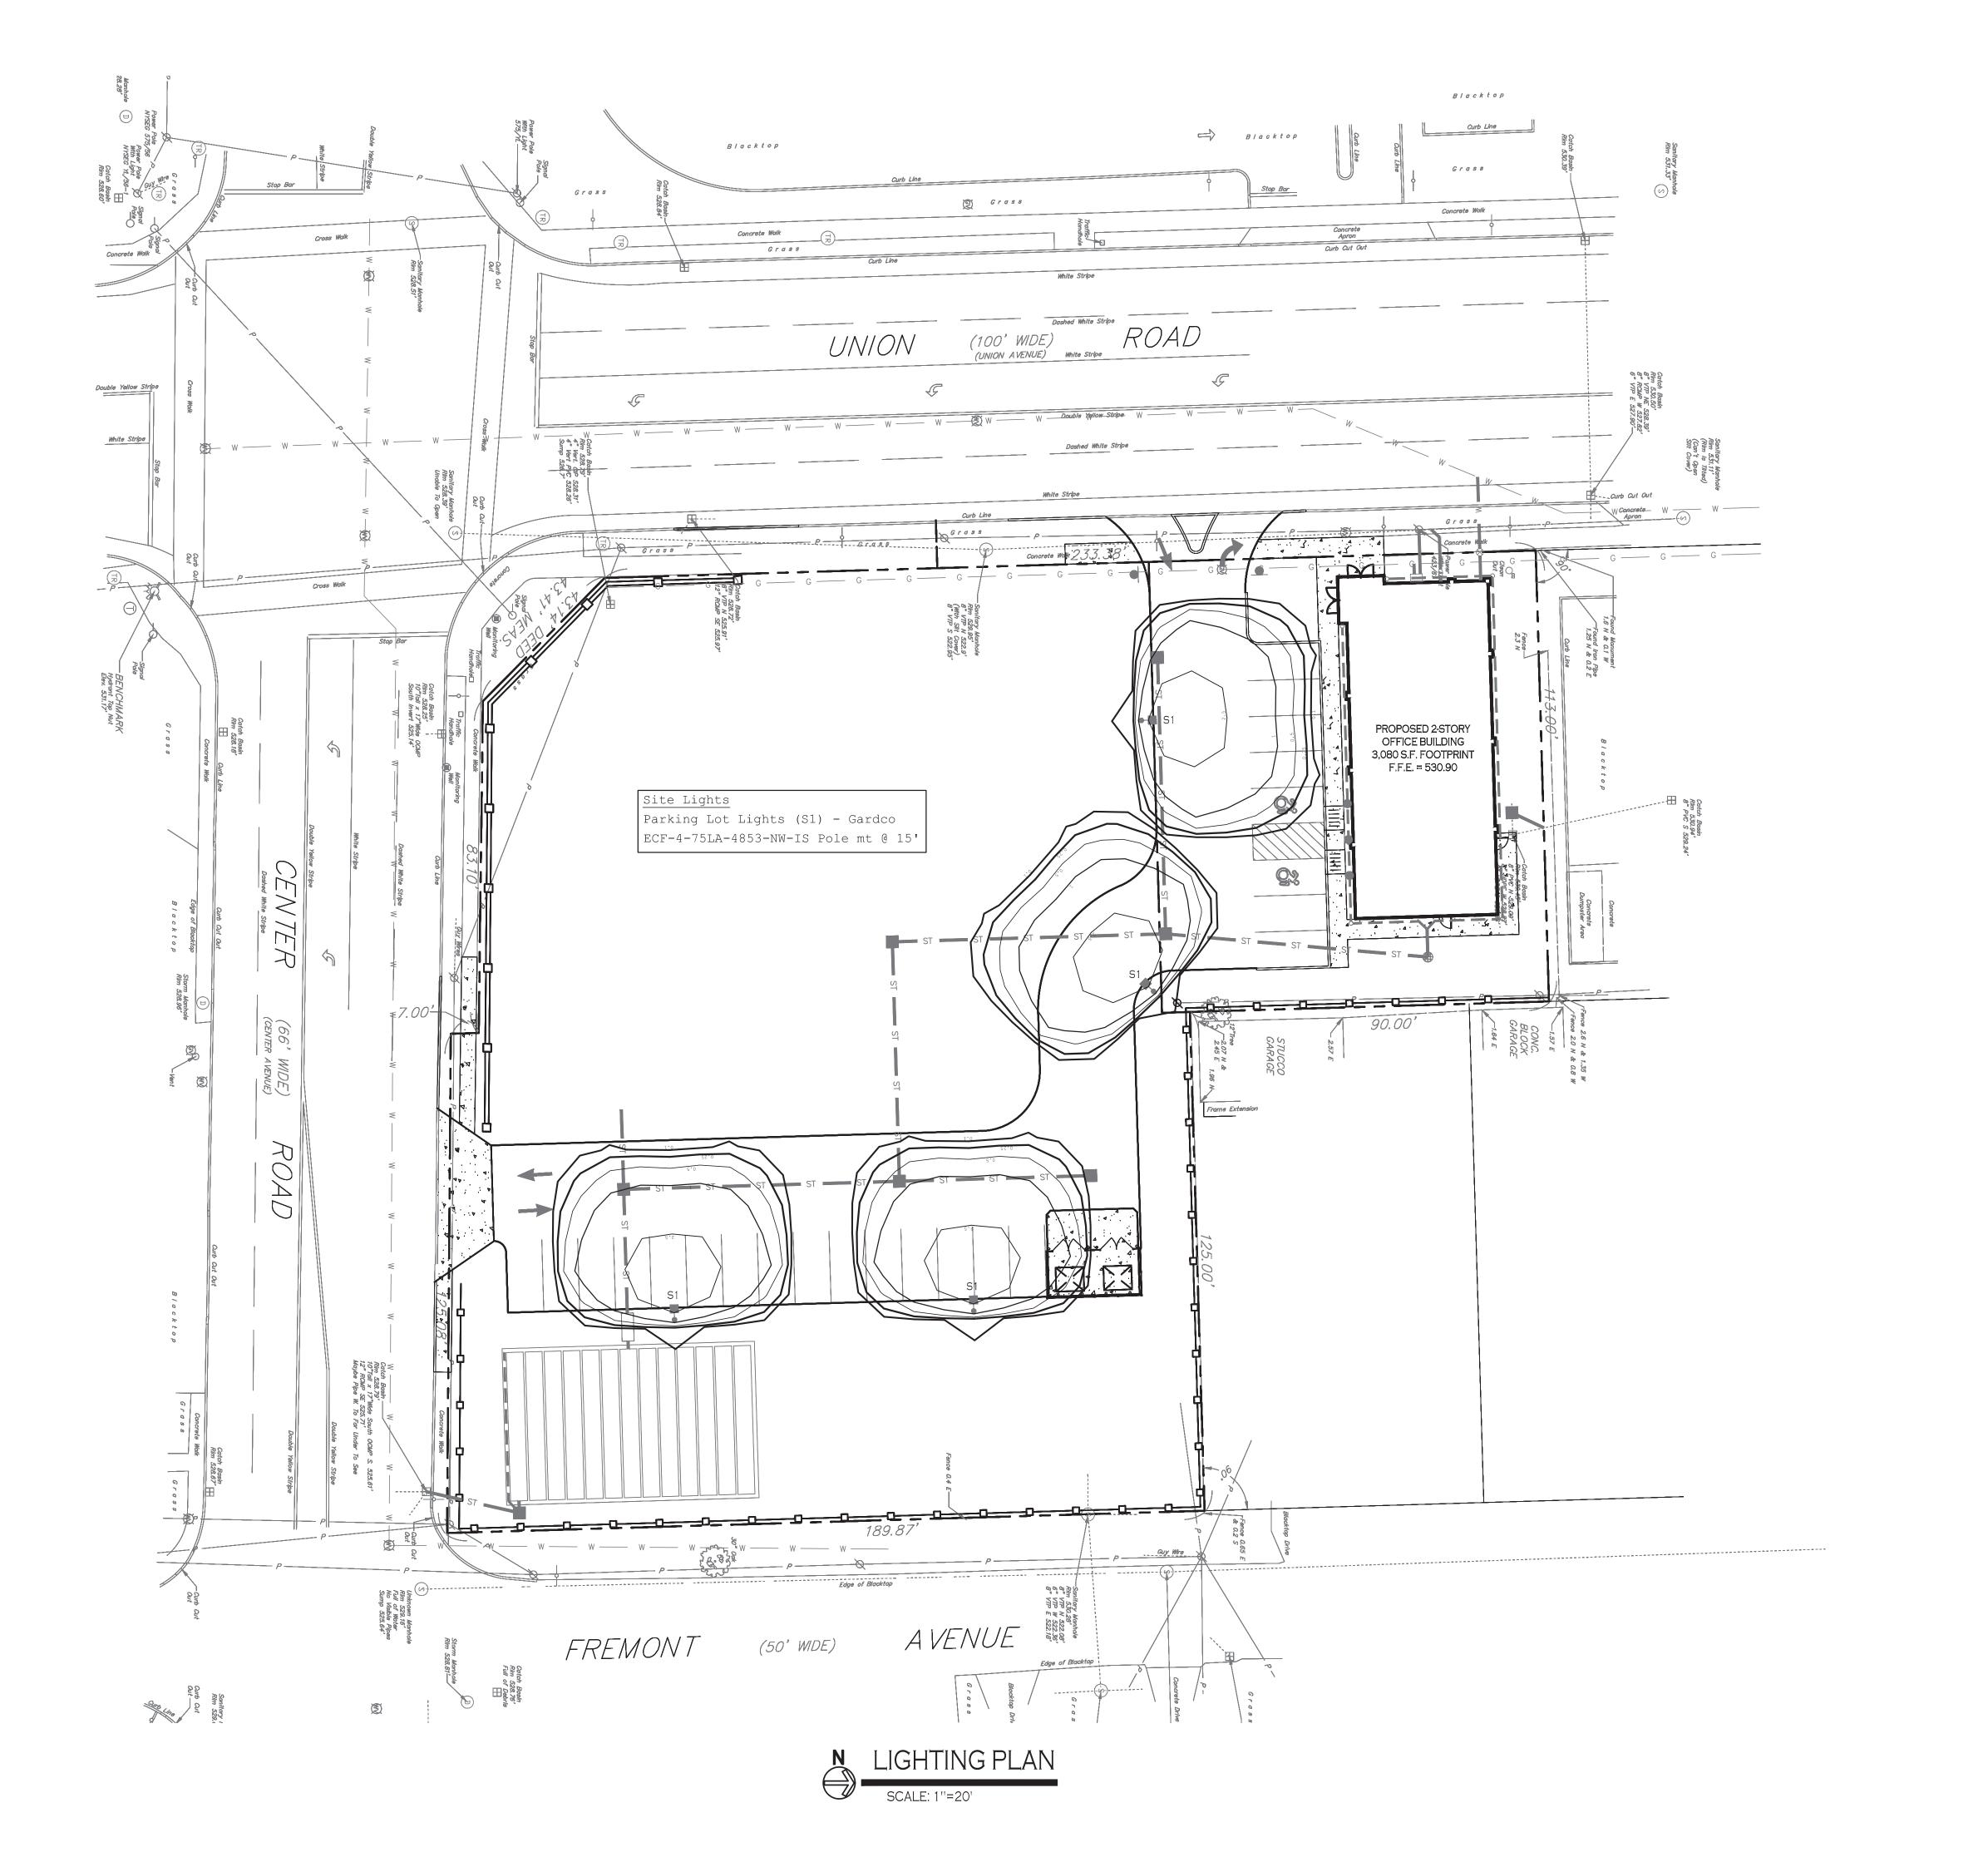

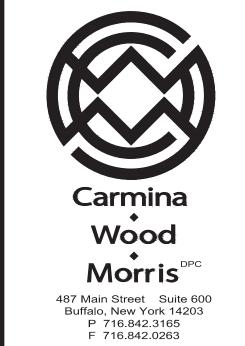



Building

8/24/21 A. Pandolfe As Noted

Date: Drawn by: Scale:

DRAWING NAME: Lighting Plan

DRAWING NO.

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